



**US Army Corps
of Engineers®**
New England District
696 Virginia Road
Concord, MA 01742-2751

PUBLIC NOTICE

Comment Period Begins: March 27, 2018
Comment Period Ends: April 26, 2018
File Number: NAE-2018-00176
In Reply Refer To: Rodney A. Howe
Phone: (978) 318-8496
E-mail: Rodney.A.Howe@usace.army.mil

The District Engineer has received a permit application to conduct work in waters of the United States from IDEXX Real Estate Holdings, LLC [1 IDEXX Drive Westbrook, Maine 04092]. This work is proposed in unnamed wetlands at 1 IDEXX Drive Westbrook, Maine. The project site is located on the USGS GORHAM, ME quadrangle sheet at: Latitude 43.65940°N Longitude -70.37745°W.

The work involves placing permanent fill in 2.9 acres of wetland to construct an addition to the existing Synergy Center located on the IDEXX property, as well as associated parking improvements to be located on the adjacent CMP transmission corridor property. Proposed work will consist of the construction of a building addition, several new parking lots, trails, stormwater management features, and associated site improvements. The proposed work will take place on two parcels. Work associated with the building addition is proposed on a parcel owned by IDEXX, identified by the City of Westbrook Assessor as Map 5B, Lot 5, that is approximately 53.3 acres in size; Work associated with the new parking lots is proposed on an abutting property owned by Central Maine Power (CMP) Company, identified on the City of Westbrook Interactive GIS Map as Map 2, Lot 30, that is approximately 17.2 acres in size. The existing Site contains buildings, parking lots, freshwater wetlands, and a stream tributary to Clark Brook, as shown on the attached plans. The purpose of the proposed building addition is to provide the necessary office space for approximately 600 new employees; the proposed parking lots will serve to provide the necessary parking for new employees and also includes additional parking spaces to account for the parking spaces that will be displaced by the building addition.

The work is shown on the attached plans entitled "IDEXX Laboratories, Inc., Synergy East Expansion Plan Set," on 21 sheets, and dated "December 2017."

Wetland impacts will be limited to those required to construct the parking and access trails necessary to support the existing and expanding facility and to construct the stormwater management infrastructure required by the Maine DEP to treat and manage the stormwater runoff generated by the proposed development. To compensate for the projects unavoidable impacts to 2.9-acres of freshwater wetlands, the applicant proposes to make an In-Lieu Fee payment of \$551,324.50 to the Maine Natural Resource Mitigation Fund.

AUTHORITY

Permits are required pursuant to:

- Section 10 of the Rivers and Harbors Act of 1899
- Section 404 of the Clean Water Act
- Section 103 of the Marine Protection, Research and Sanctuaries Act.

The decision whether to issue a permit will be based on an evaluation of the probable impact of the proposed activity on the public interest. That decision will reflect the national concern for both protection and utilization of important resources. The benefit which may reasonably accrue from the proposal must be balanced against its reasonably foreseeable detriments. All factors which may be relevant to the proposal will be considered, including the cumulative effects thereof; among those are: conservation, economics, aesthetics, general environmental concerns, wetlands, cultural value, fish and wildlife values, flood hazards, flood plain value, land use, navigation, shoreline erosion and accretion, recreation, water supply and conservation, water quality, energy needs, safety, food production and, in general, the needs and welfare of the people.

The U.S. Army Corps of Engineers, New England District (Corps), is soliciting comments from the public; Federal, state, and local agencies and officials; Indian Tribes; and other interested parties in order to consider and evaluate the impacts of this proposed activity. The Corps will consider all comments received to determine whether to issue, modify, condition or deny a permit for this proposal. To make this decision, comments are used to assess impacts on endangered species, historic properties, water quality, general environmental effects, and the other public interest factors listed above. Comments are used in the preparation of an Environmental Assessment and/or an Environmental Impact Statement pursuant to the National Environmental Policy Act. Comments are also used to determine the need for a public hearing and to determine the overall public interest of the proposed activity.

Where the activity involves the discharge of dredged or fill material into waters of the United States or the transportation of dredged material for the purpose of disposing it in ocean waters, the evaluation of the impact of the activity in the public interest will also include application of the guidelines promulgated by the Administrator, U.S Environmental Protection Agency, under authority of Section 404(b) of the Clean Water Act, and/or Section 103 of the Marine Protection Research and Sanctuaries Act of 1972, as amended.

NATIONAL HISTORIC PRESERVATION ACT

Based on his initial review, the District Engineer has determined that little likelihood exists for the proposed work to impinge upon properties with cultural or Native American significance, or listed in, or eligible for listing in, the National Register of Historic Places. Therefore, no further consideration of the requirements of Section 106 of the National Historic Preservation Act of 1966, as amended, is necessary. This determination is based upon one or more of the following:

- a. The permit area has been extensively modified by previous work.
- b. The permit area has been recently created.
- c. The proposed activity is of limited nature and scope.
- d. Review of the latest published version of the National Register shows that no presence of registered properties listed as being eligible for inclusion therein are in the permit area or general vicinity.
- e. Coordination with the State Historic Preservation Officer and/or Tribal Historic Preservation Officer(s).

ENDANGERED SPECIES CONSULTATION

The Corps has reviewed the application for the potential impact on Federally-listed threatened or endangered species and their designated critical habitat pursuant to section 7 of the Endangered Species Act as amended. It is our preliminary determination that the proposed activity for which authorization is being sought is designed, situated or will be operated/used in such a manner that it is not likely to adversely affect a listed species or their critical habitat. We are coordinating with the NMFS and/or U.S. Fish and Wildlife Service on listed species under their jurisdiction and the ESA consultation will be concluded prior to the final decision.

OTHER GOVERNMENT AUTHORIZATIONS

The following authorizations have been applied for, or have been, or will be obtained:

- (X) Permit, license or assent from State.
- (X) Permit from local wetland agency or conservation commission.
- (X) Water Quality Certification in accordance with Section 401 of the Clean Water Act.

COMMENTS

In order to properly evaluate the proposal, we are seeking public comment. Anyone wishing to comment is encouraged to do so. Comments should be submitted in writing by the above date. If you have any questions, please contact Rodney Howe at (978) 318-8496 or (207) 623-8367 ext. 5, if calling from within Maine.

Any person may request, in writing, within the comment period specified in this notice, that a public hearing be held to consider the application. Requests for a public hearing shall specifically state the reasons for holding a public hearing. The Corps holds public hearings for the purpose of obtaining public comments when that is the best means for understanding a wide variety of concerns from a diverse segment of the public.

The initial determinations made herein will be reviewed in light of facts submitted in response to this notice. All comments will be considered a matter of public record. Copies of letters of objection will be forwarded to the applicant who will normally be requested to contact objectors directly in an effort to reach an understanding.

THIS NOTICE IS NOT AN AUTHORIZATION TO DO ANY WORK.


Frank J. Del Giudice
Chief, Permits and Enforcement Branch
Regulatory Division

CENAE-R

FILE NO. NAE-2018-00176

If you would prefer not to continue receiving Public Notices by email, please contact Ms. Tina Chaisson at (978) 318-8058 or e-mail her at bettina.m.chaisson@usace.army.mil. You may also check here () and return this portion of the Public Notice to: Bettina Chaisson, Regulatory Division, U.S. Army Corps of Engineers, 696 Virginia Road, Concord, MA 01742-2751.

NAME: _____

ADDRESS: _____

PHONE: _____

IDEXX LABORATORIES, INC.

ONE IDEXX DRIVE
369 COUNTY ROAD
WESTBROOK, ME 04092

TAX MAP 5B - LOT5
TAX MAP 2 - LOT 30

JANUARY 2018

NOT FOR CONSTRUCTION



PROJECT LOCATION


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miles



41 Hutchins Drive | Portland, Maine 04102
800.426.4262 | www.woodardcurran.com

COMMITMENT & INTEGRITY DRIVE RESULTS


SHEET INDEX	
GENERAL	
0	C-001 COVER SHEET
1	C-001 GENERAL NOTES, LEGEND, ABBREVIATIONS, AND SHEET INDEX
CIVIL- Parking Lots	
2	C-101 EXISTING CONDITIONS PLAN
3	C-201 PROPOSED OVERALL SITE PLAN AND SHEET INDEX
4	C-201 WETLAND IMPACT PLAN
5	C-202 LOT 4 -- GRADING AND DRAINAGE PLAN
6	C-203 LOT 3 -- GRADING AND DRAINAGE PLAN
7	C-204 LOT 2 -- GRADING AND DRAINAGE PLAN
8	C-205 LOT 1 -- GRADING AND DRAINAGE PLAN
9	C-206 SOUTH ENTRANCE SIDEWALK GRADING AND DRAINAGE PLAN
10	C-207 SOUTHWEST SIDEWALK GRADING AND DRAINAGE
CIVIL- Building Expansion	
11	C-300 BUILDING EXPANSION -- EXISTING CONDITIONS & DEMOLITION PLAN
12	C-301 BUILDING EXPANSION -- SITE PLAN
13	BUILDING EXPANSION -- GRADING, DRAINAGE & UTILITIES PLAN
CIVIL- Details	
14	C-400 CIVIL DETAILS - 1
15	C-401 CIVIL DETAILS - 2
16	C-402 CIVIL DETAILS - 3
17	C-403 CIVIL DETAILS - 4
18	C-404 CIVIL DETAILS - 5
19	C-405 CIVIL DETAILS - 6
20	C-406 CIVIL DETAILS - 7

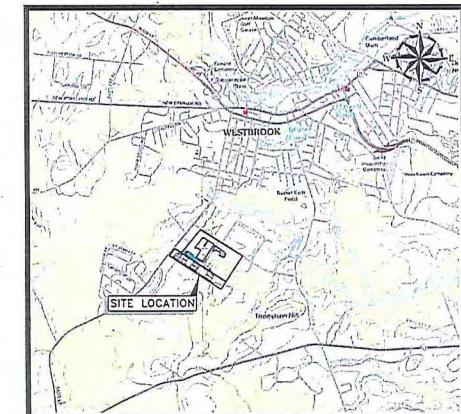


SOURCE: USGS TOPOGRAPHIC MAP

SITE LOCATION MAP


1 0 1
2000 0 2000 4000
feet meters

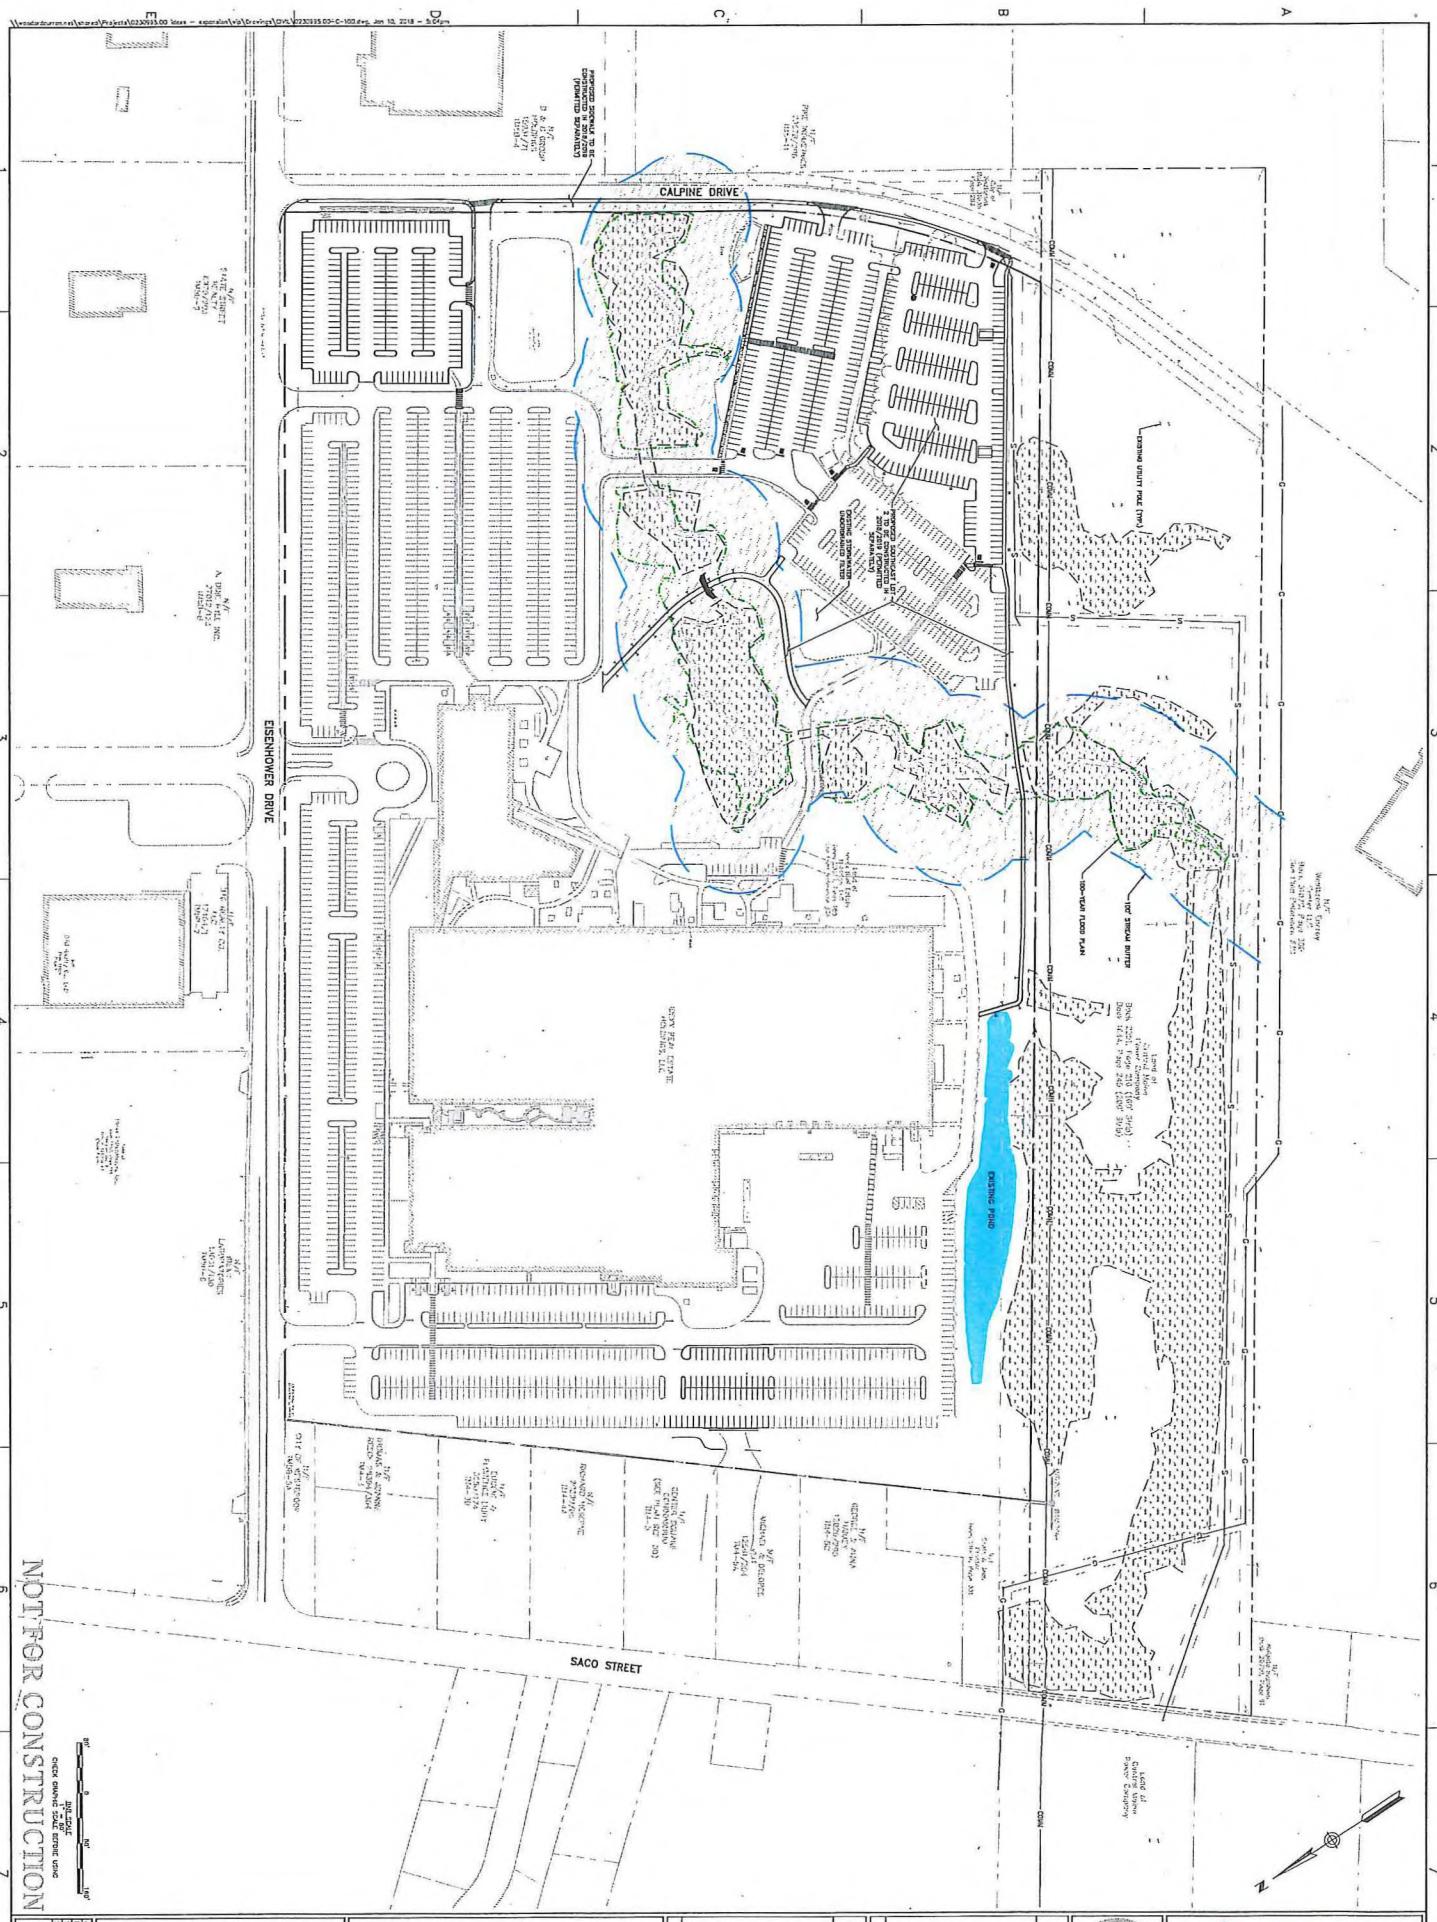

DATE ISSUED: 2018	SCALE: 1:1000
DATE DRAWN: 2018	DATE CHECKED: 2018

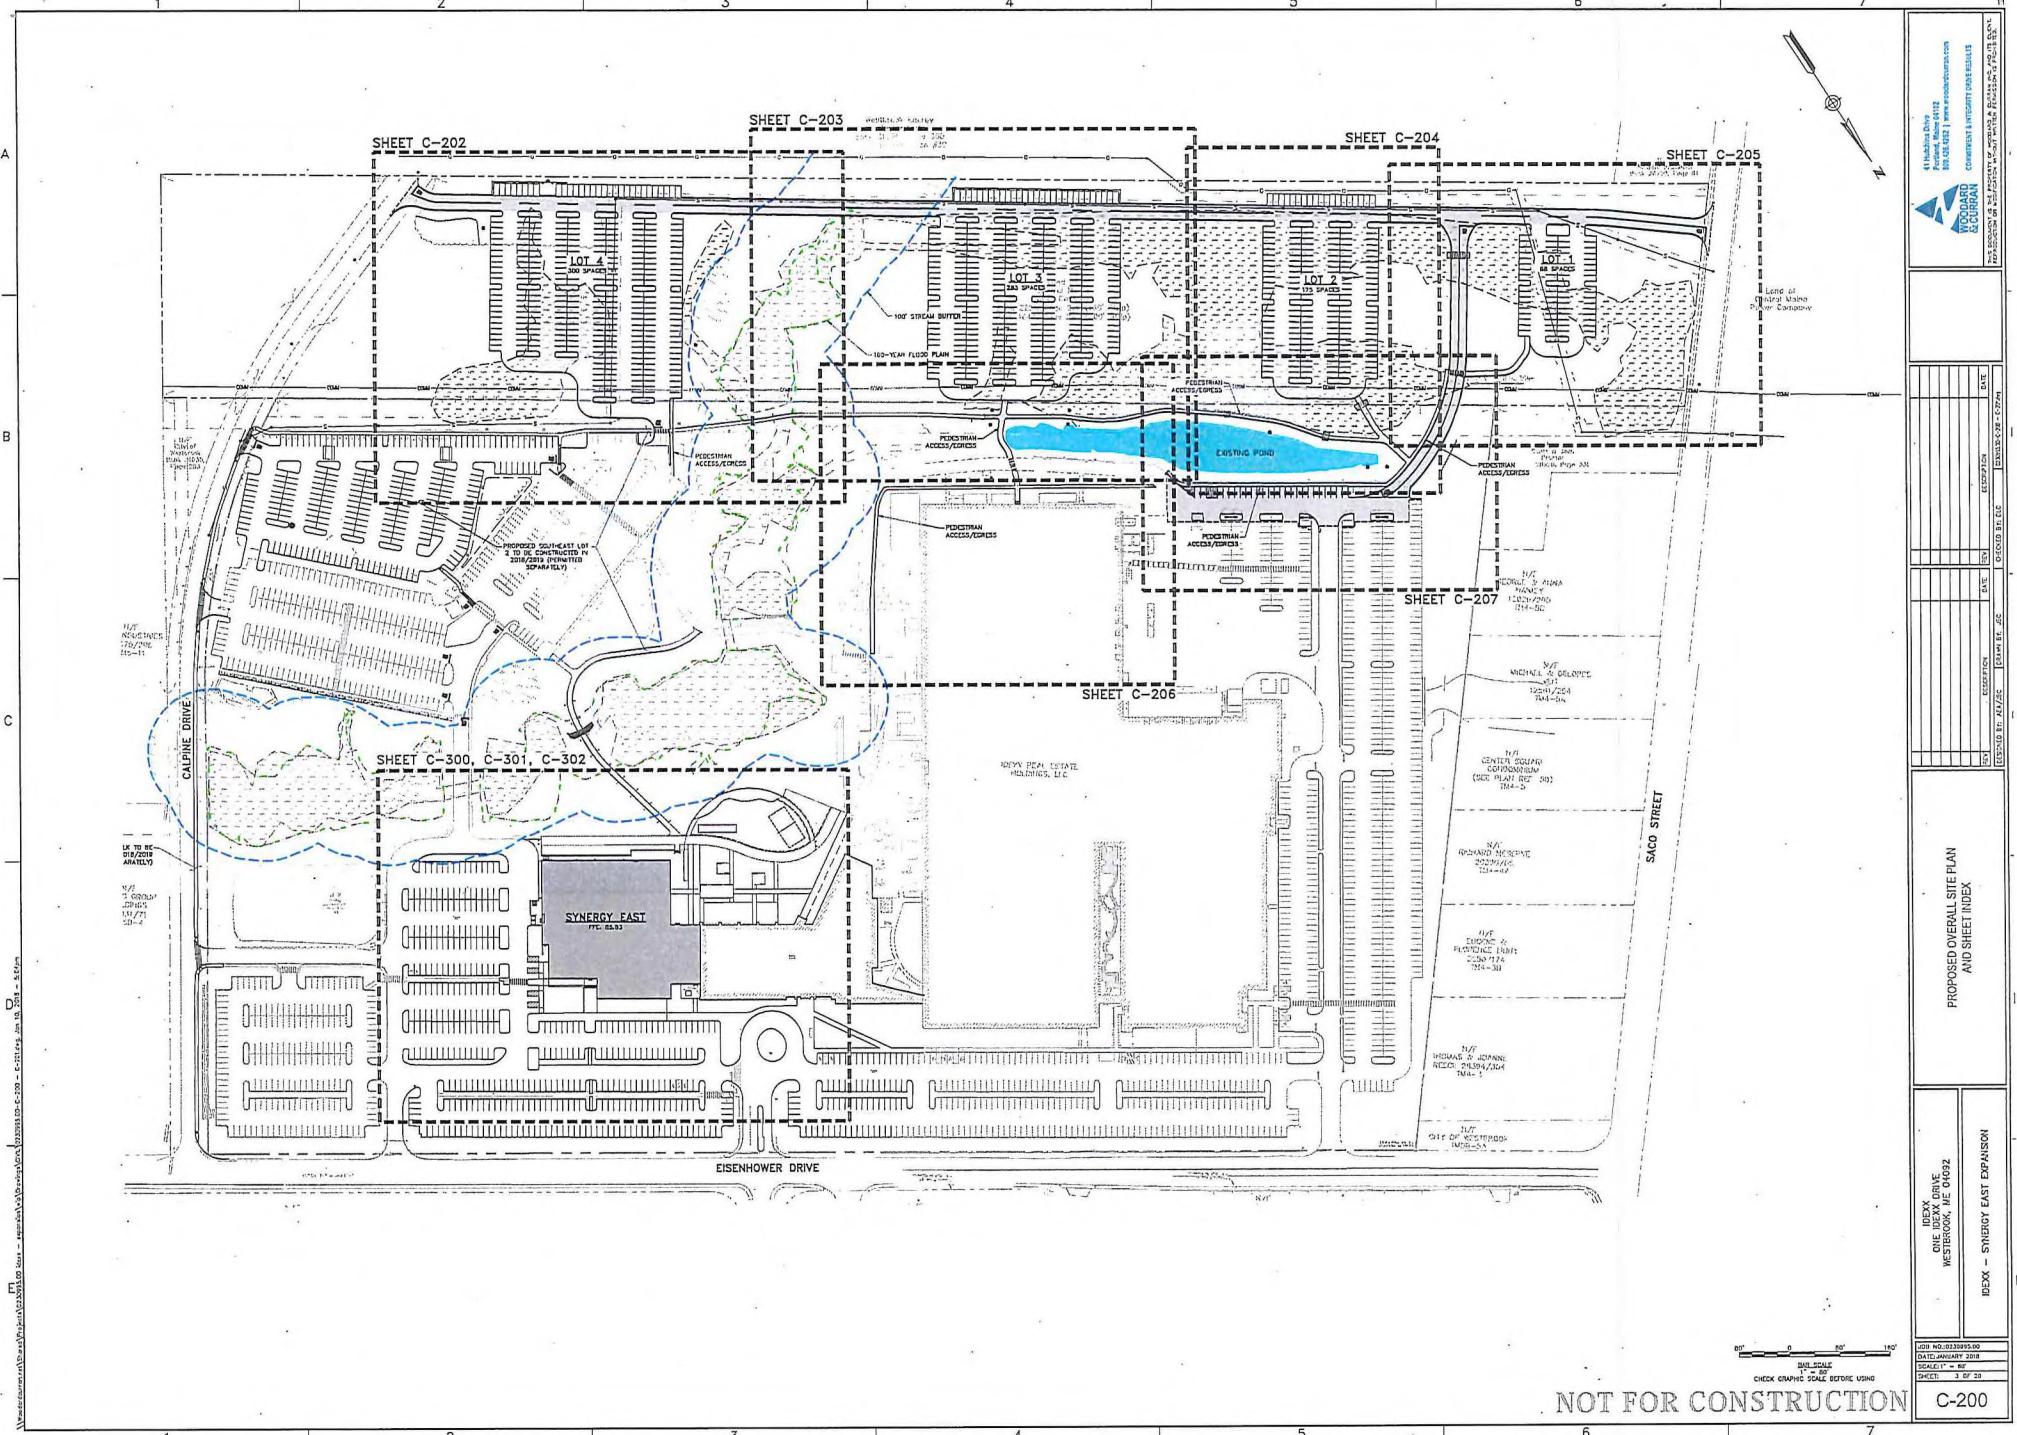

NOT FOR CONSTRUCTION

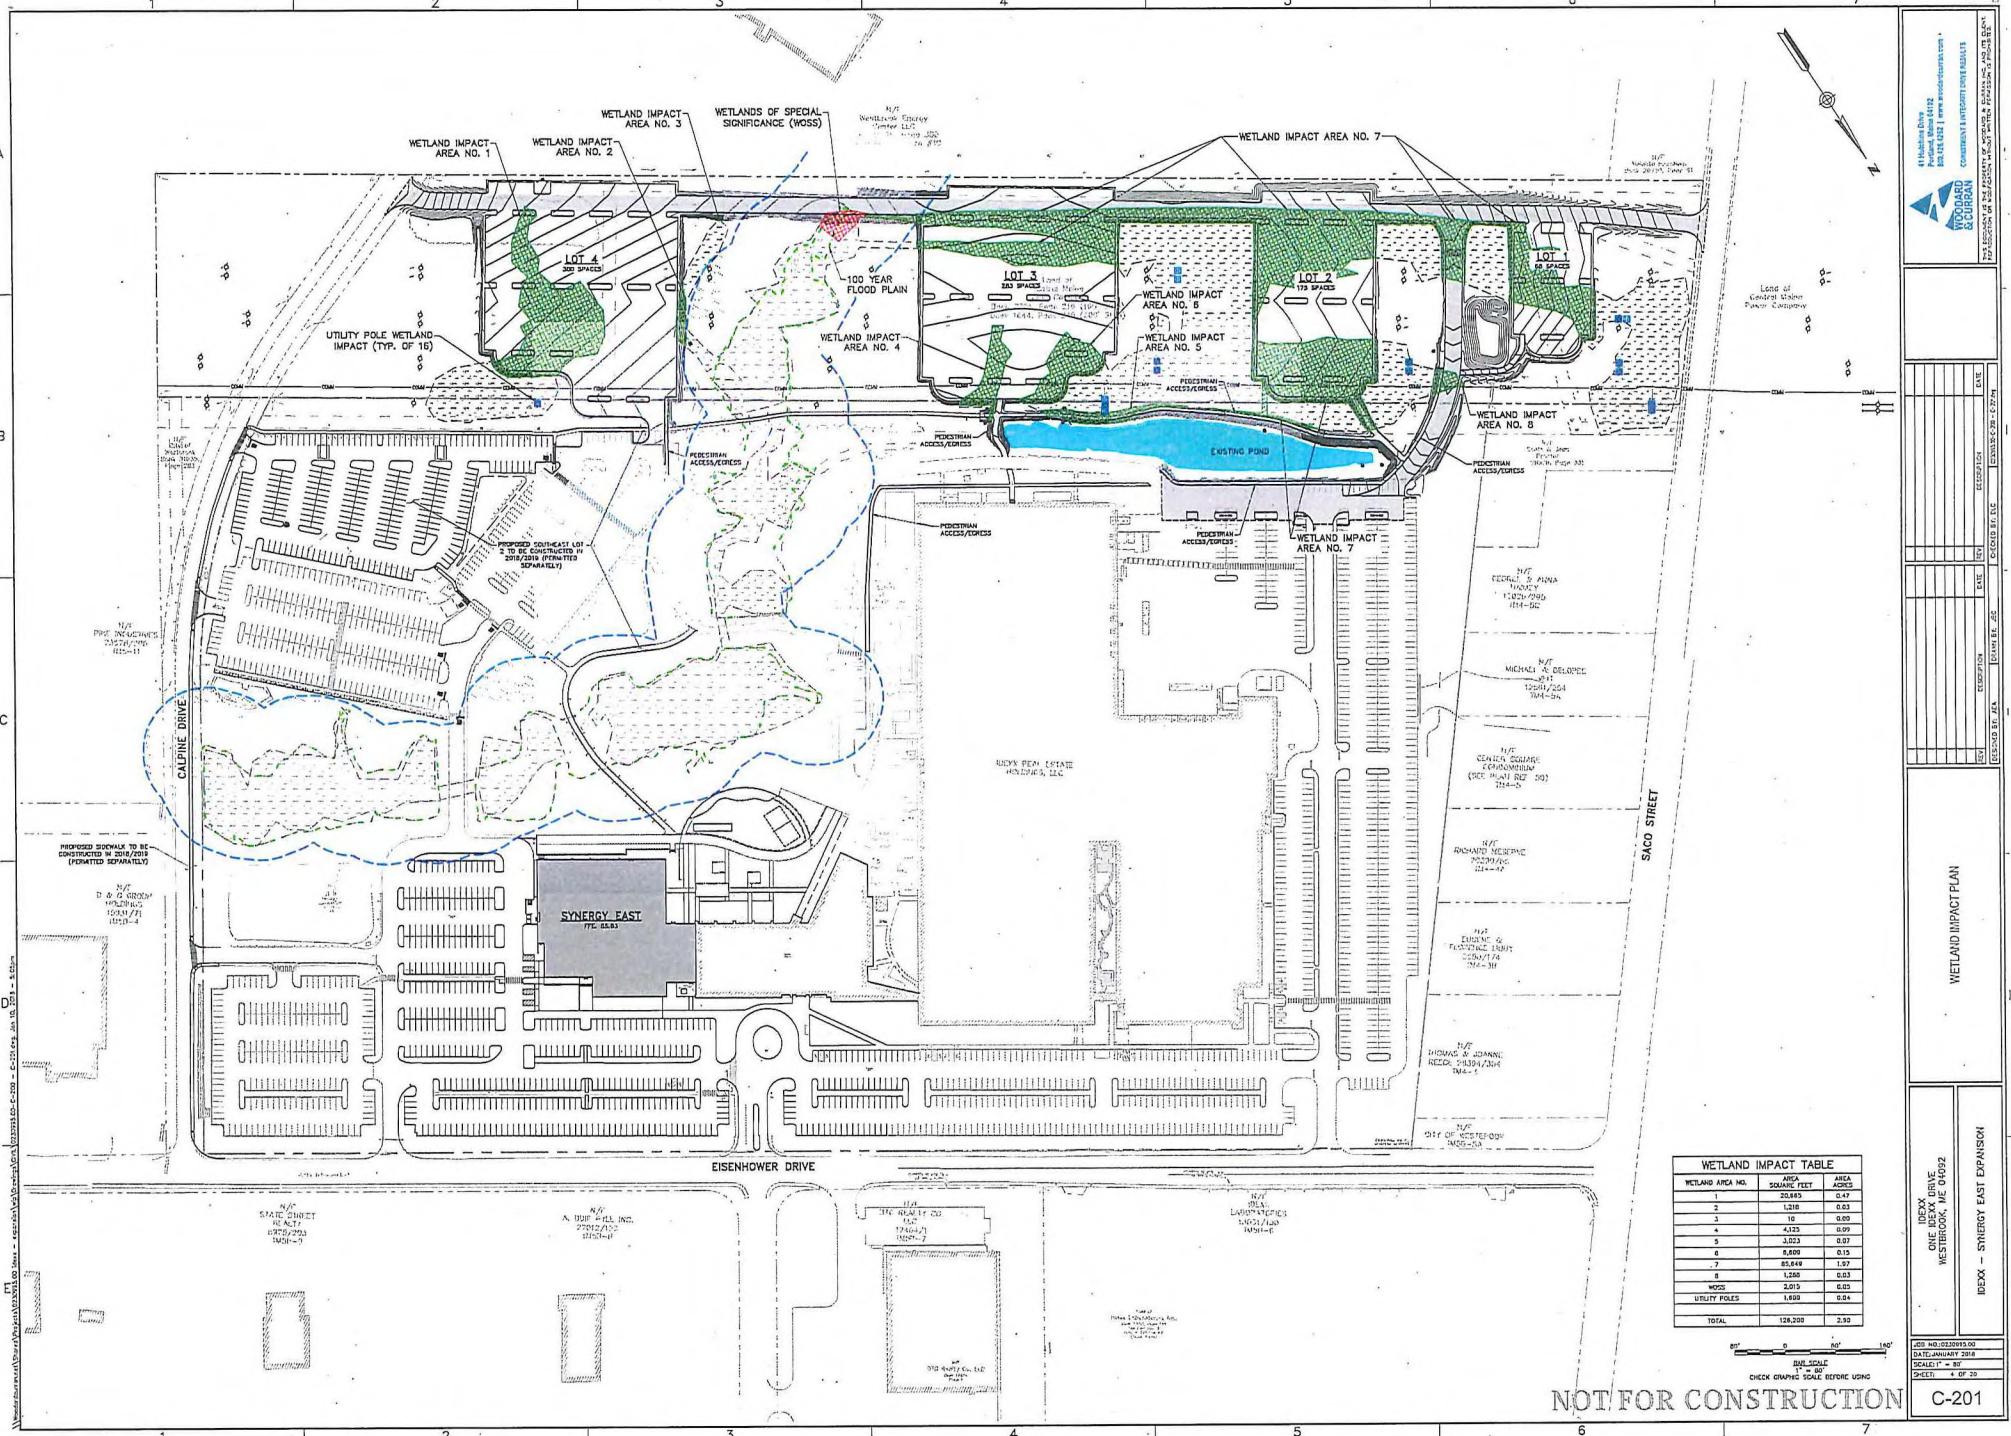

WETLAND AREA NO.	AREA SQUARE FEET	AREA ACRES
1	1,216	0.03
2	1,216	0.03
3	10	0.00
4	4,123	0.09
5	3,023	0.07
6	81,449	1.87
7	1,200	0.03
8	1,200	0.03
MOSS	2,019	0.05
UTILITY POLES	1,659	0.04
TOTAL	126,200	2.92


NOT FOR CONSTRUCTION
C-201





WETLAND IMPACT PLAN

INDEX LINE
LINE INDEX
WESTBROOK, ME 04092
INDEX - SYNERGY EAST EXPANSION

NOT FOR CONSTRUCTION
C-201

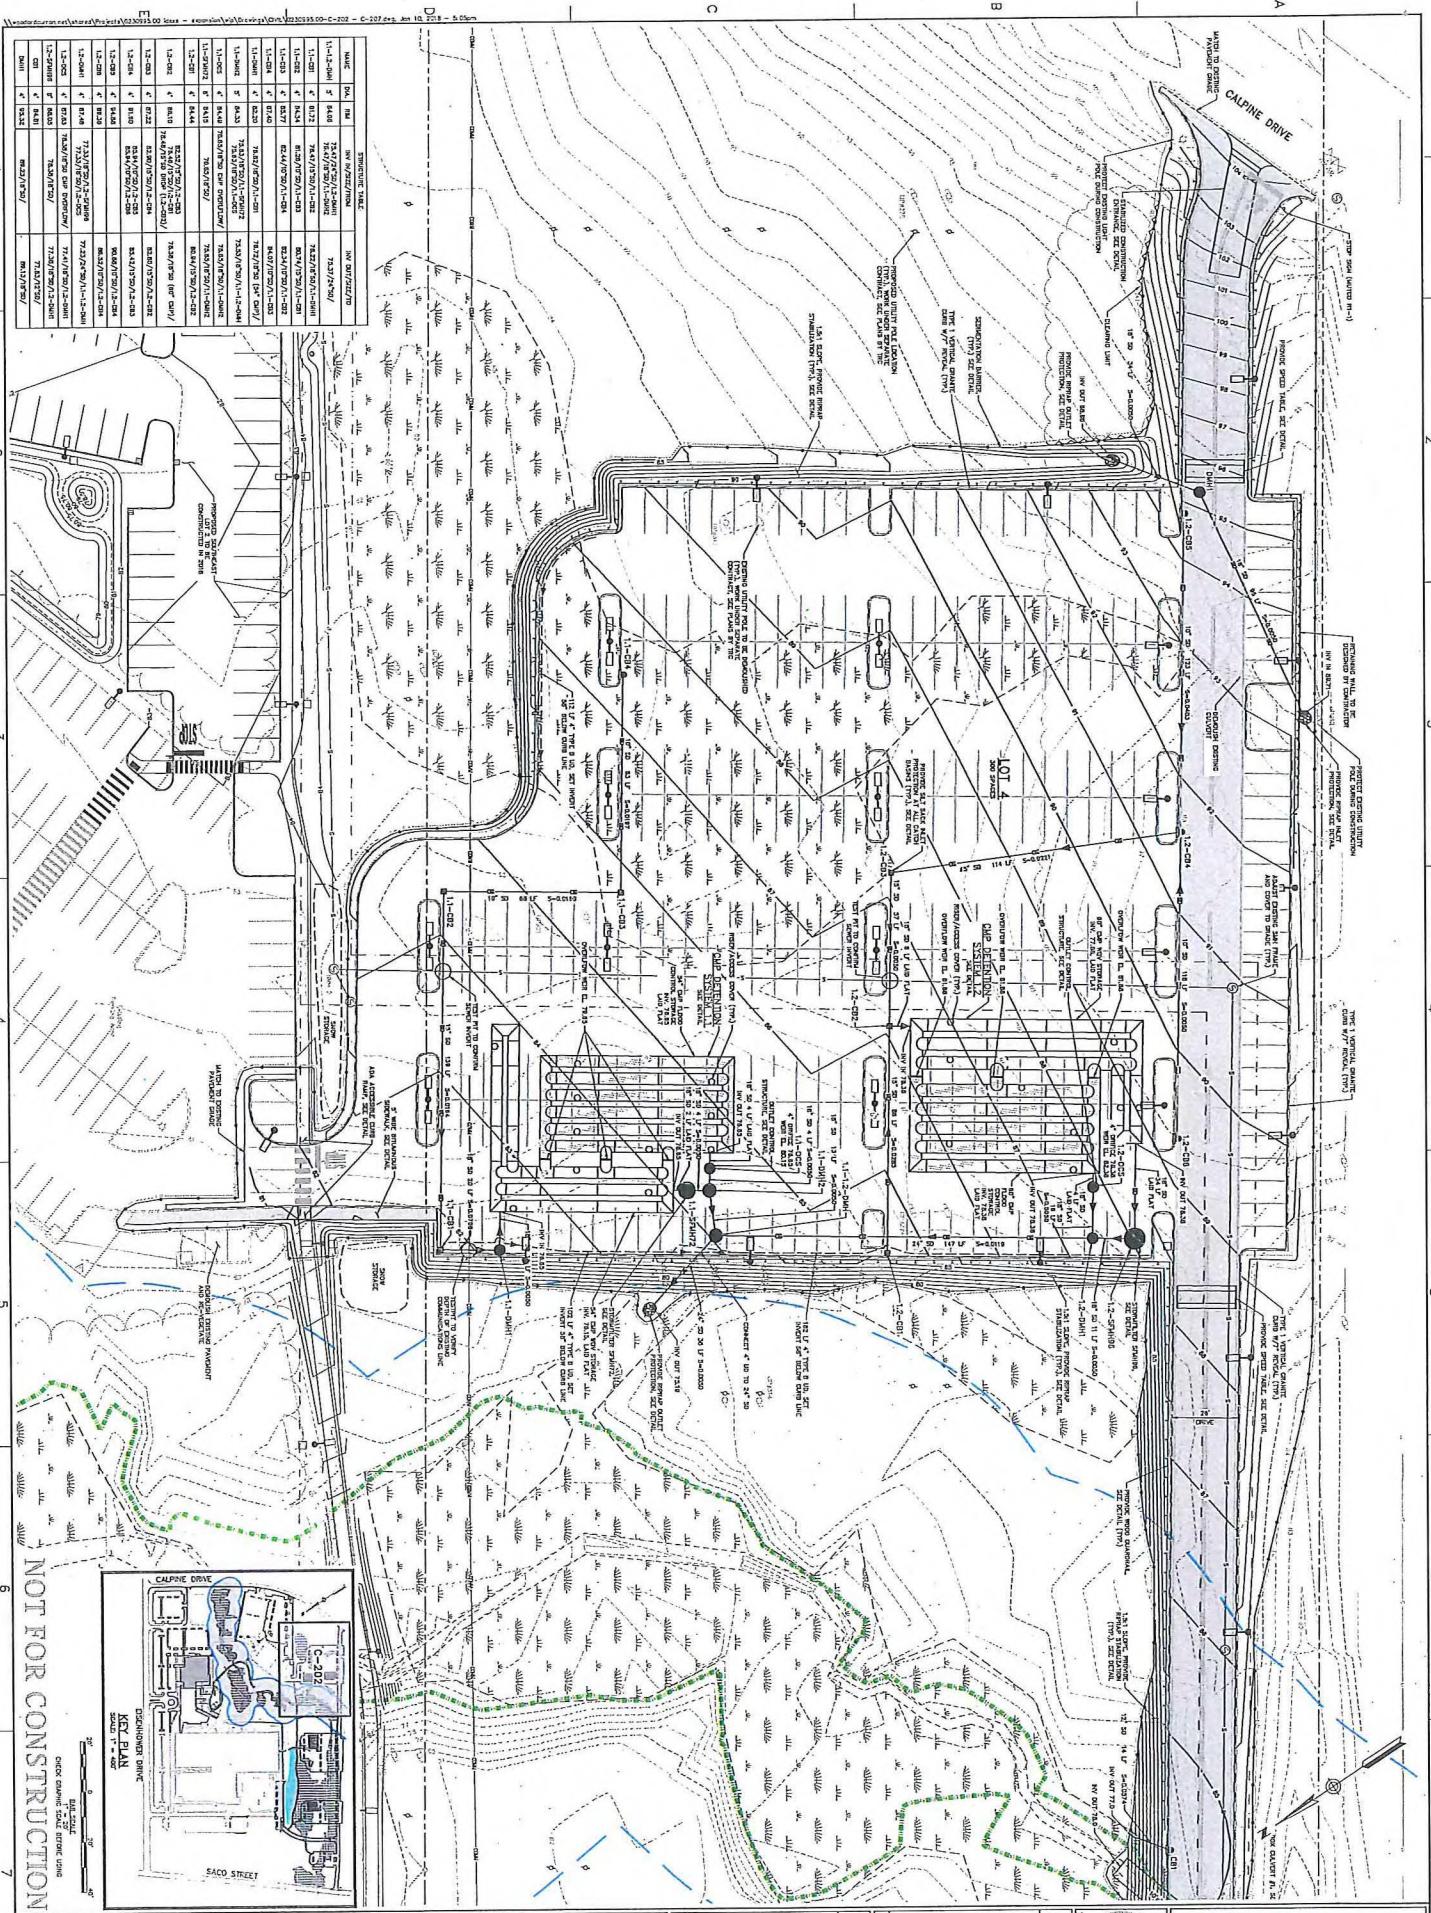

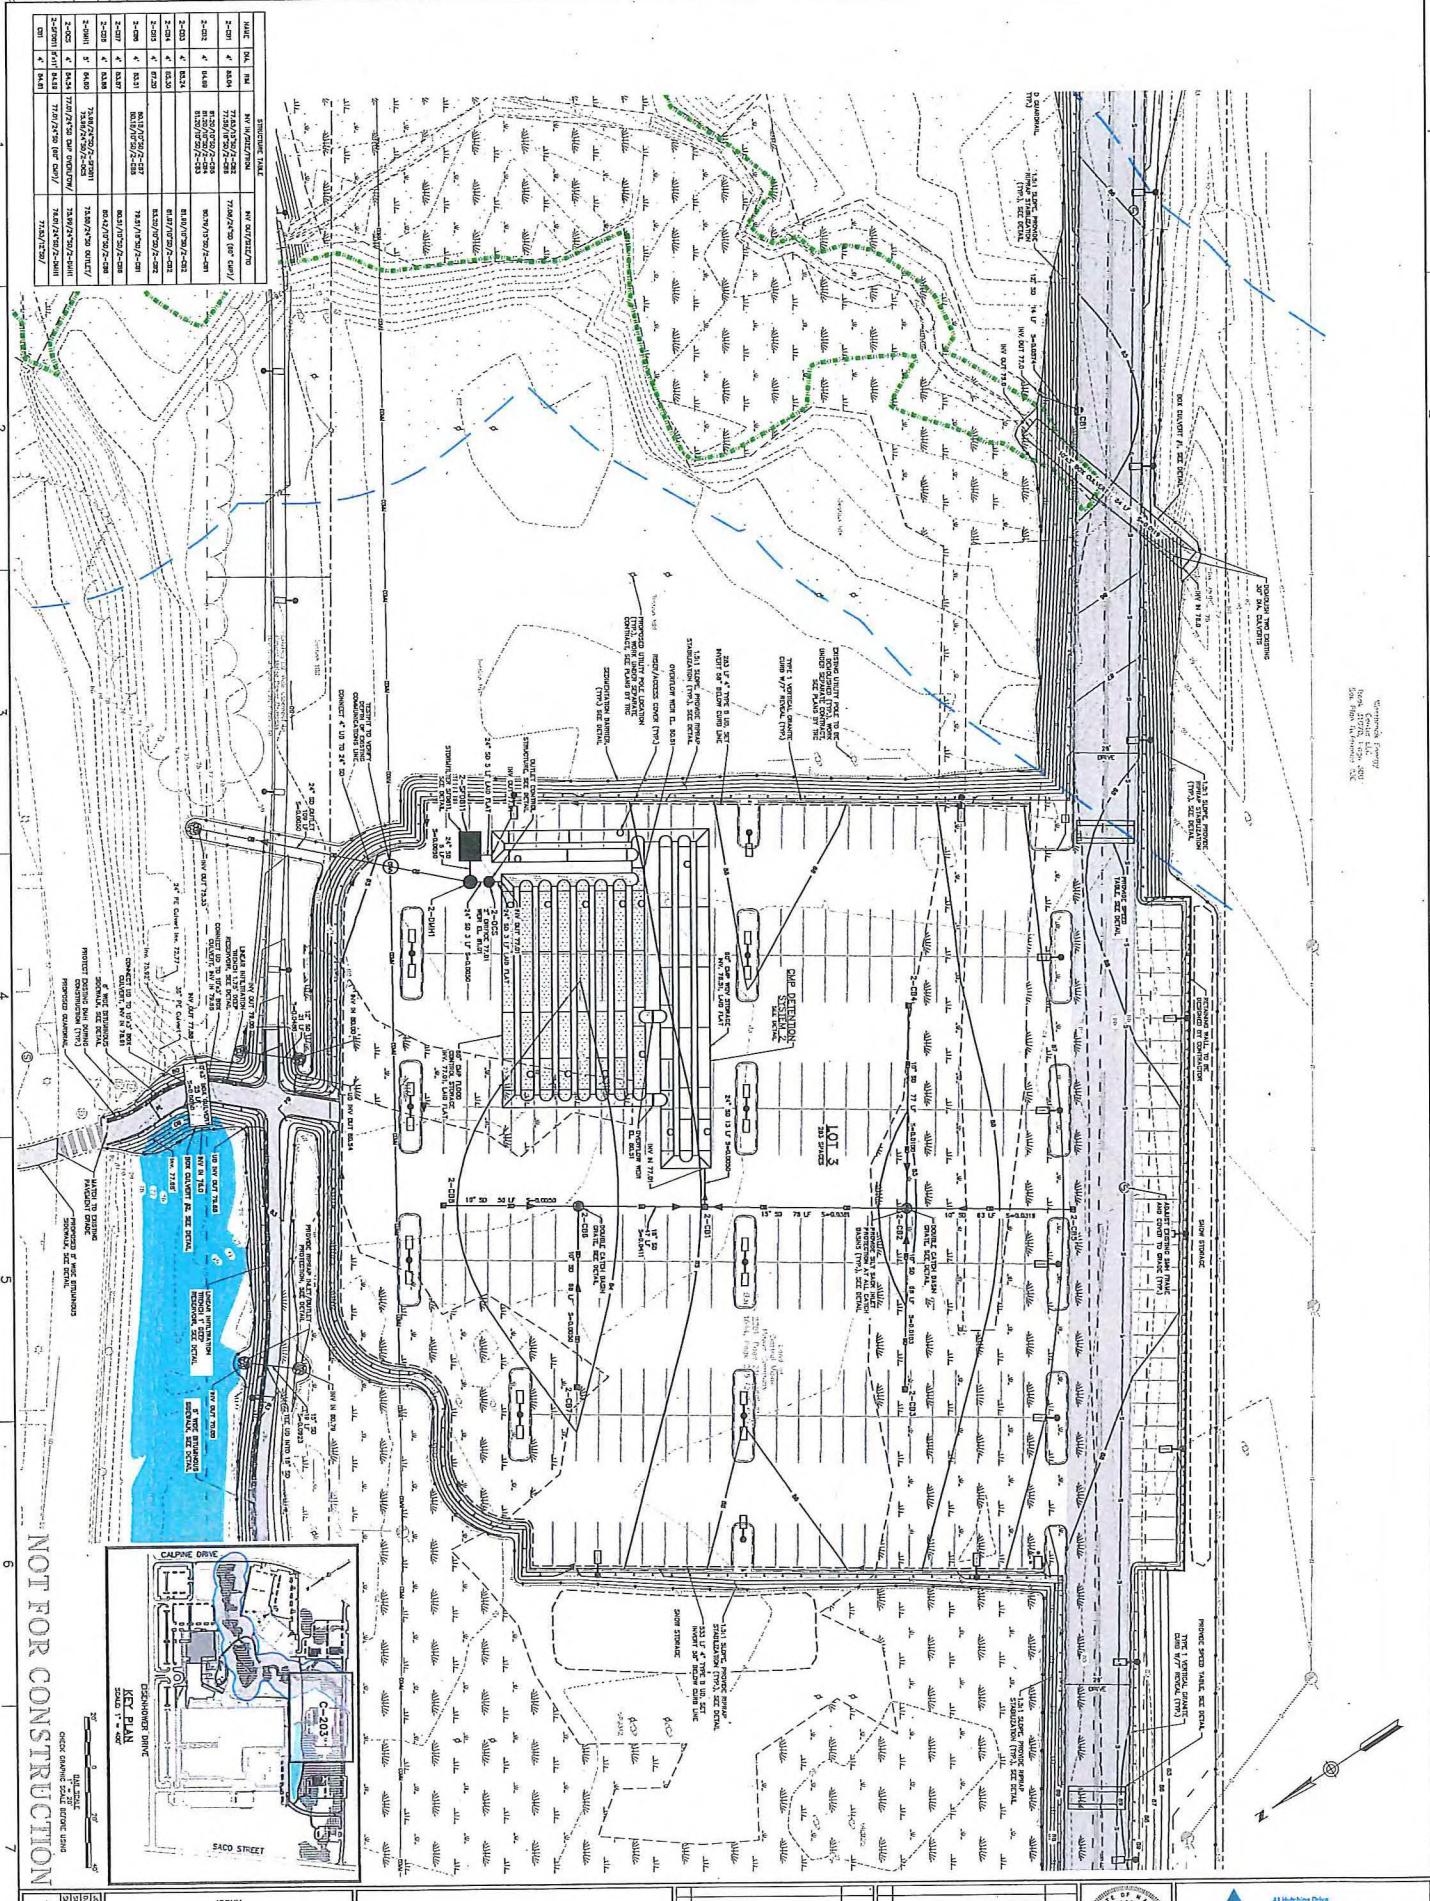

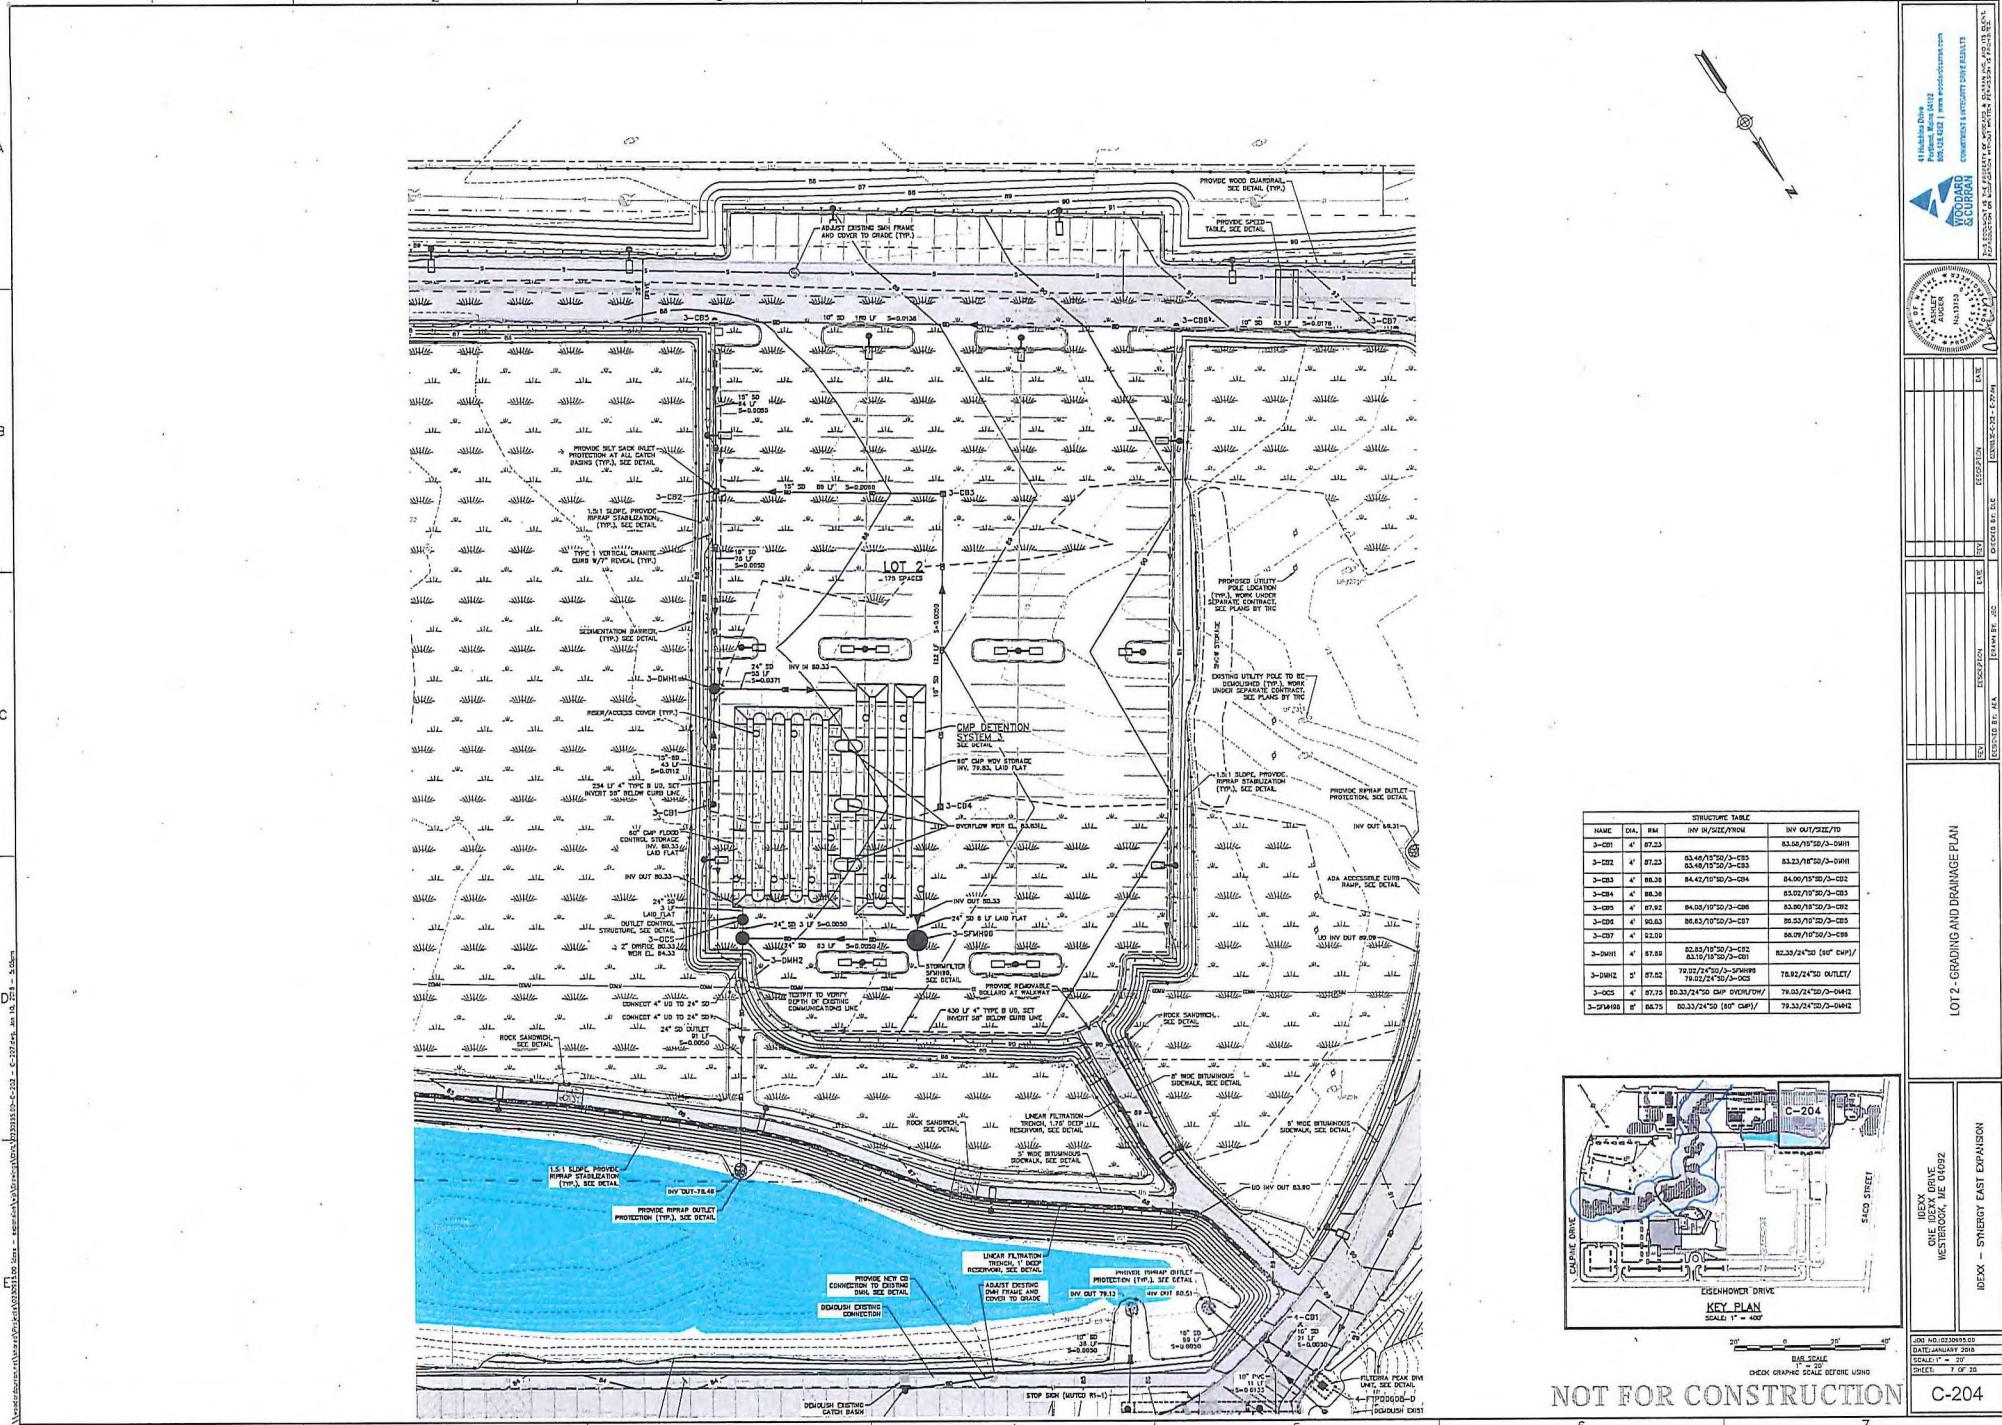

1

2

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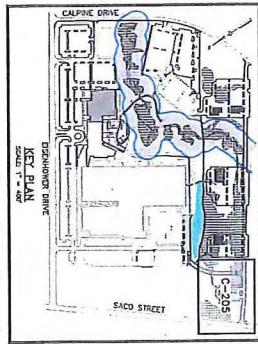
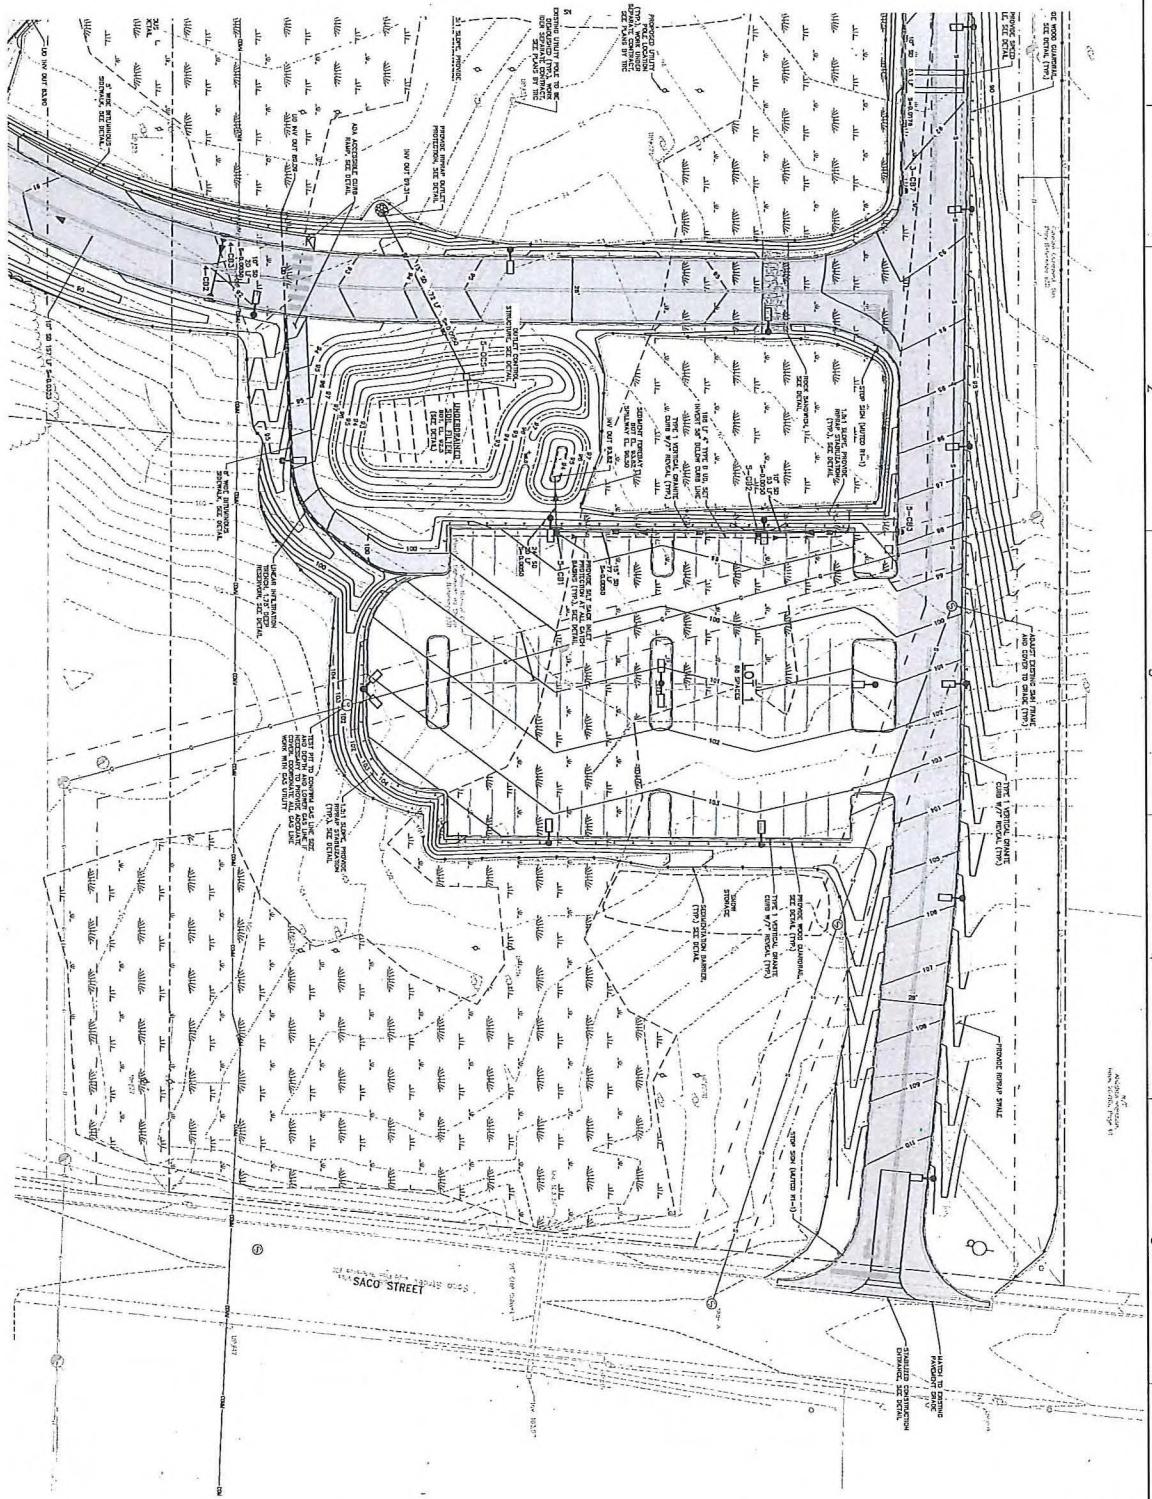
6

7

C

B

A



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ENCLOSURE SHEET			
NAME	SIZE	REV DATE	REV DESCRIPTION
LOT 1 - GRAZING AND DRAINAGE PLAN	1000x1000	000	000
IDEXX - SYNERGY EAST EXPANSION	1000x1000	000	000
IDEXX - SYNERGY EAST EXPANSION	1000x1000	000	000


LOT 1 - GRAZING AND DRAINAGE PLAN

DEV.	DESCRIPTION	DATE	REV.	DESCRIPTION	DATE
DESIGNED BY: AEA	DRAINED BY: JOC	000	000	CHECKED BY: ELC	000



C-205

1000

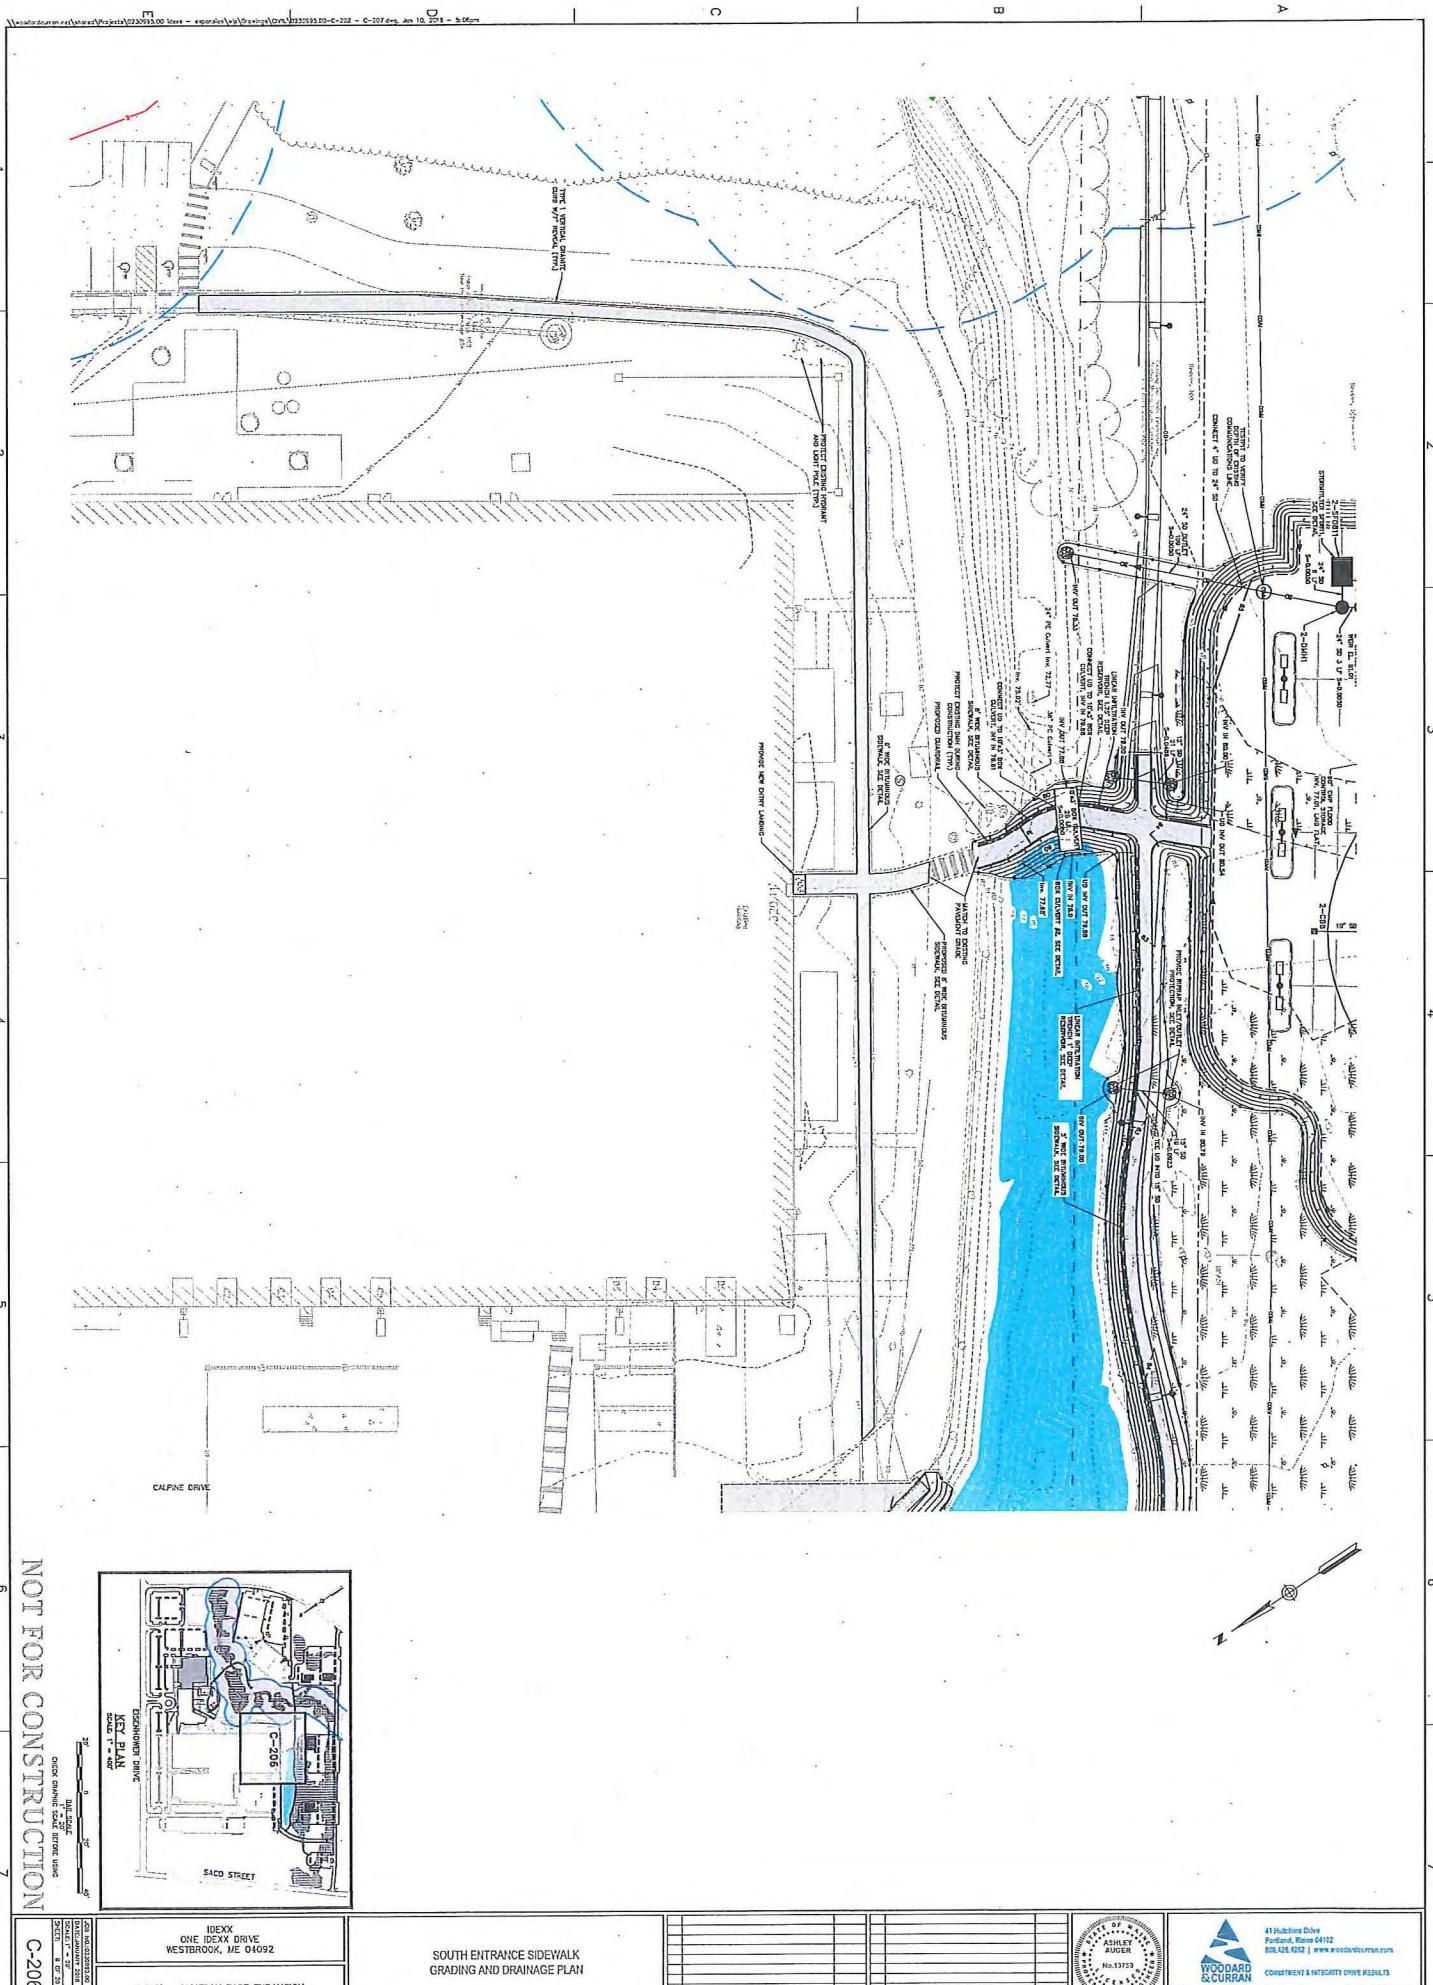

1

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3


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6

7

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check sheet scale true 1:600

DRAFT - NOT FOR CONSTRUCTION

DRAFTED - 06/19/2018

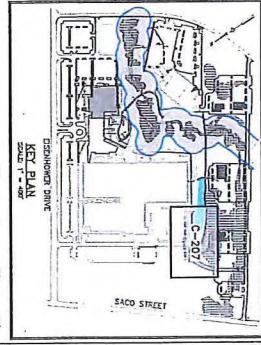CHECKED - 06/19/2018

APPROVED - 06/19/2018

DATE ISSUED - 06/19/2018

EXPIRES - 06/19/2019

NO. 13175

ASHLEY AUGER

W.D. & C.

WOODARD & CURRAN

COMMITMENT & INTEGRITY DRIVE RESULTS

The execution of this plan without written permission from its drafter

is prohibited.

IDEXX
ONE IDEXX DRIVE
WESTBROOK, ME 04092

IDEXX - SYNERGY EAST EXPANSION

SOUTHWEST SIDEWALK
GRADING AND DRAINAGE PLAN

NAME	DATE	STRUCTURE TYPE		NO. OF STREETS	NO. OF STREETS
		AS-BUILT	AS-BUILT		
A-201	4/16/2018	07/12/2018/2018	07/12/2018/2018	1	1
A-202	4/16/2018	07/12/2018/2018	07/12/2018/2018	1	1
A-203	4/16/2018	07/12/2018/2018	07/12/2018/2018	1	1
A-204	4/16/2018	07/12/2018/2018	07/12/2018/2018	1	1
A-205	4/16/2018	07/12/2018/2018	07/12/2018/2018	1	1
A-206	4/16/2018	07/12/2018/2018	07/12/2018/2018	1	1
A-207	4/16/2018	07/12/2018/2018	07/12/2018/2018	1	1
N					

REV.	DESCRIPTION	DATE	REV.	DESCRIPTION	DATE
C-207	DESIGNED BY AIA	DRAWN BY JJC	C-207	CHECKED BY DDC	C-207



41 Hutchins Drive
Portland, Maine 04102
207.428.4102 | www.woodardcurran.com


41 Hutchins Drive

Portland, Maine 04102

207.428.4102 | www.woodardcurran.com


COMMITMENT & INTEGRITY DRIVE RESULTS

The execution of this plan without written permission from its drafter

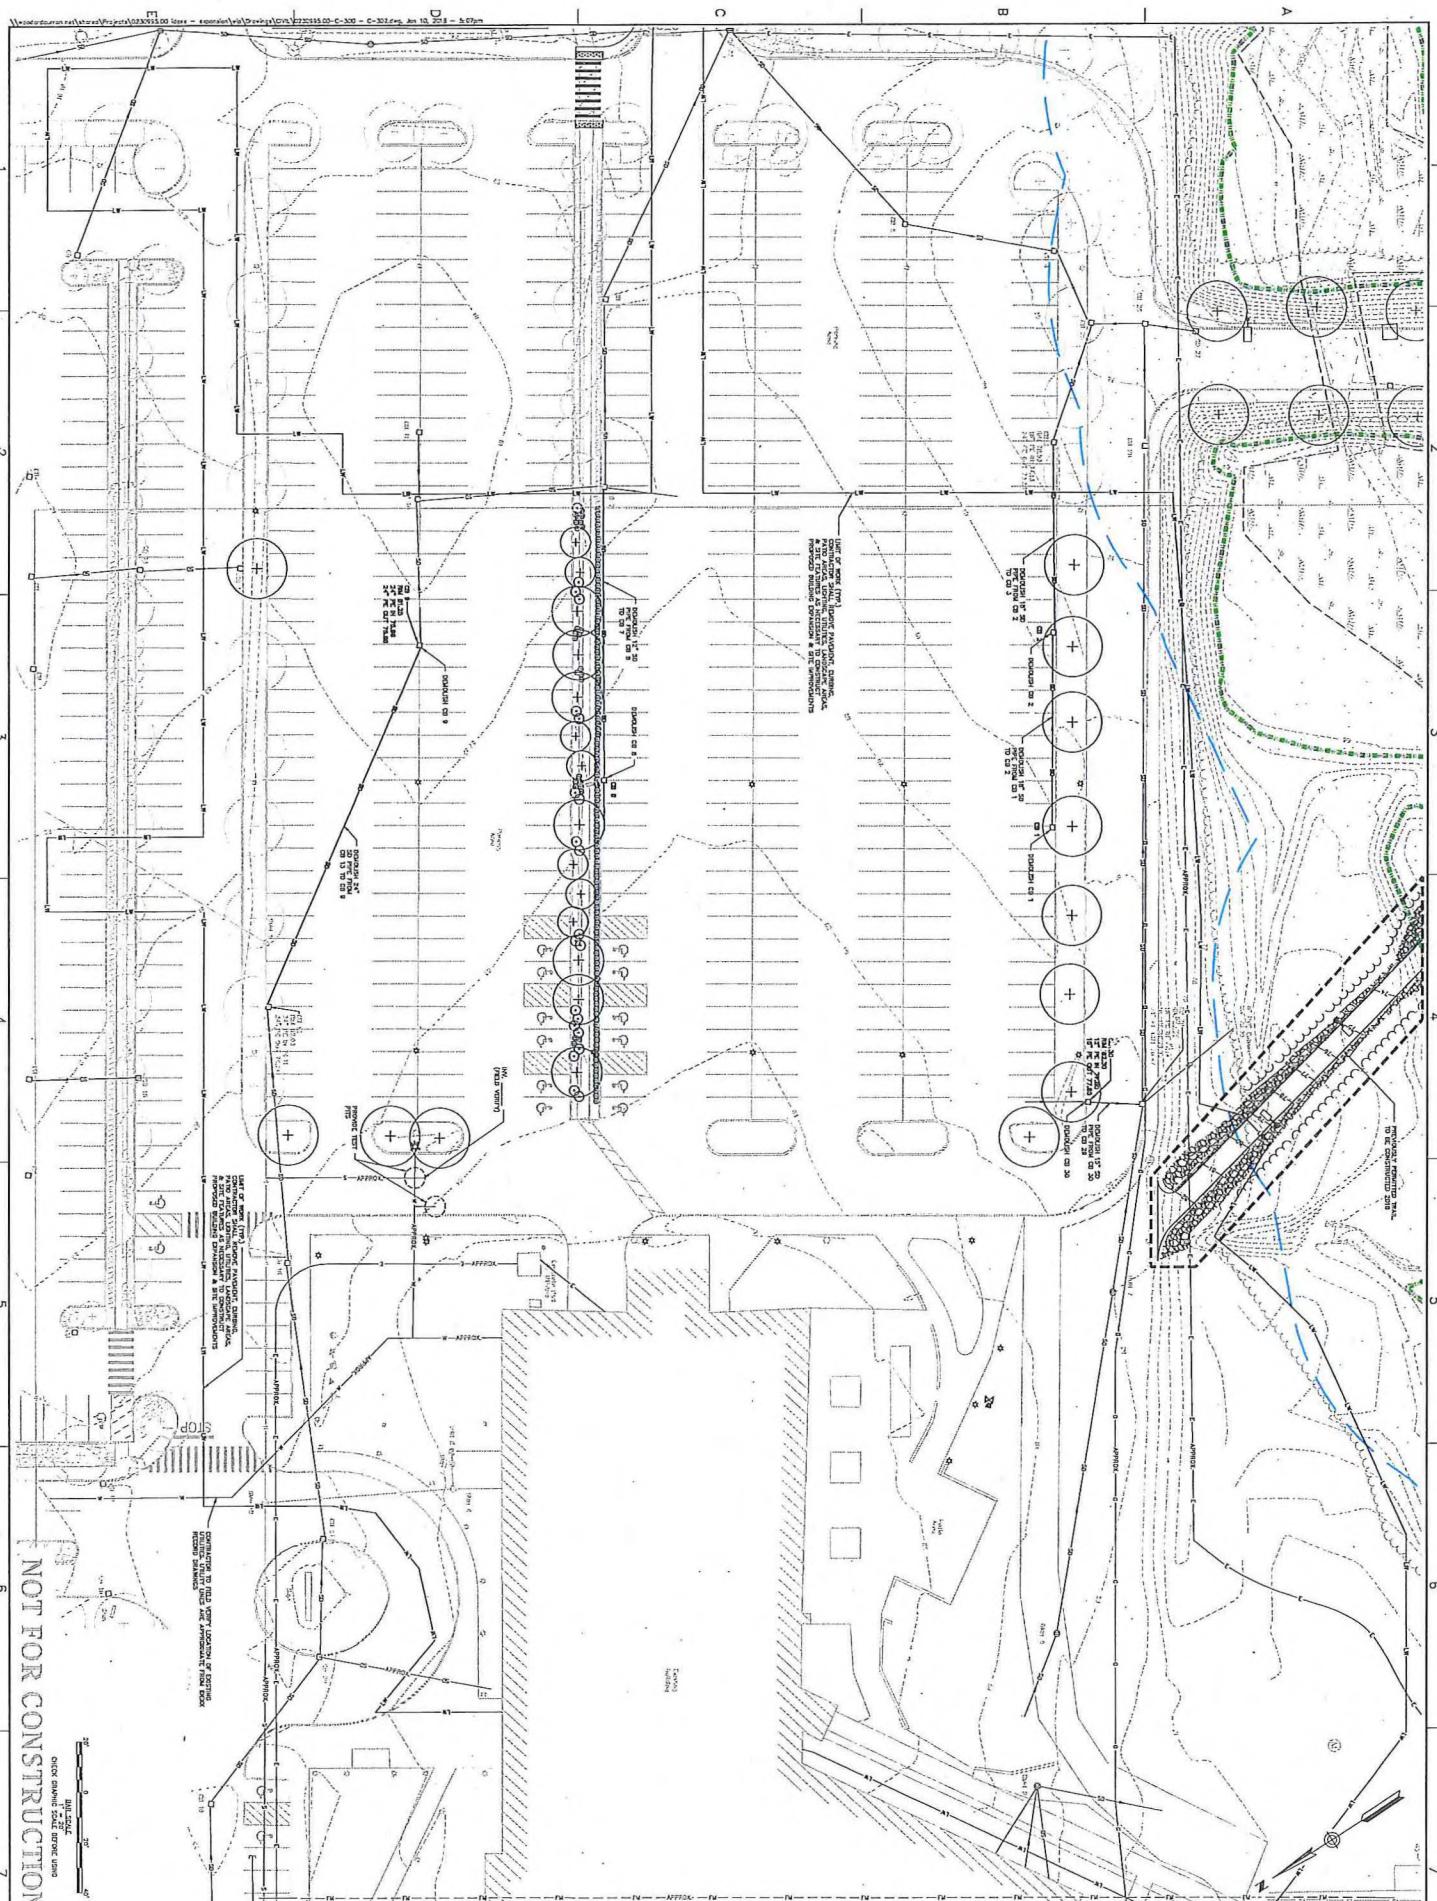

IDEXX ONE IDEXX DRIVE WESTBROOK, ME 04092	IDEXX - SYNERGY EAST EXPANSION
DESIGNER: E.A. COOPER DATE: 11/09/02	BUILDING EXPANSION - EXISTING CONDITIONS & DEMOLITION PLAN
C-300	

DESIGNED BY: E.A.	DRAWN BY: E.A.	CHECKED BY: S.L.C.	REVIEWED BY: C-300 - C-300
STATE OF MAINE ASHLEY AUGER No. 13732			
CONTRACT & INTEGRITY DRIVE RESULTS			
41 Hutchins Drive Portland, Maine 04102 800.426.6532 www.ecodatateam.com			

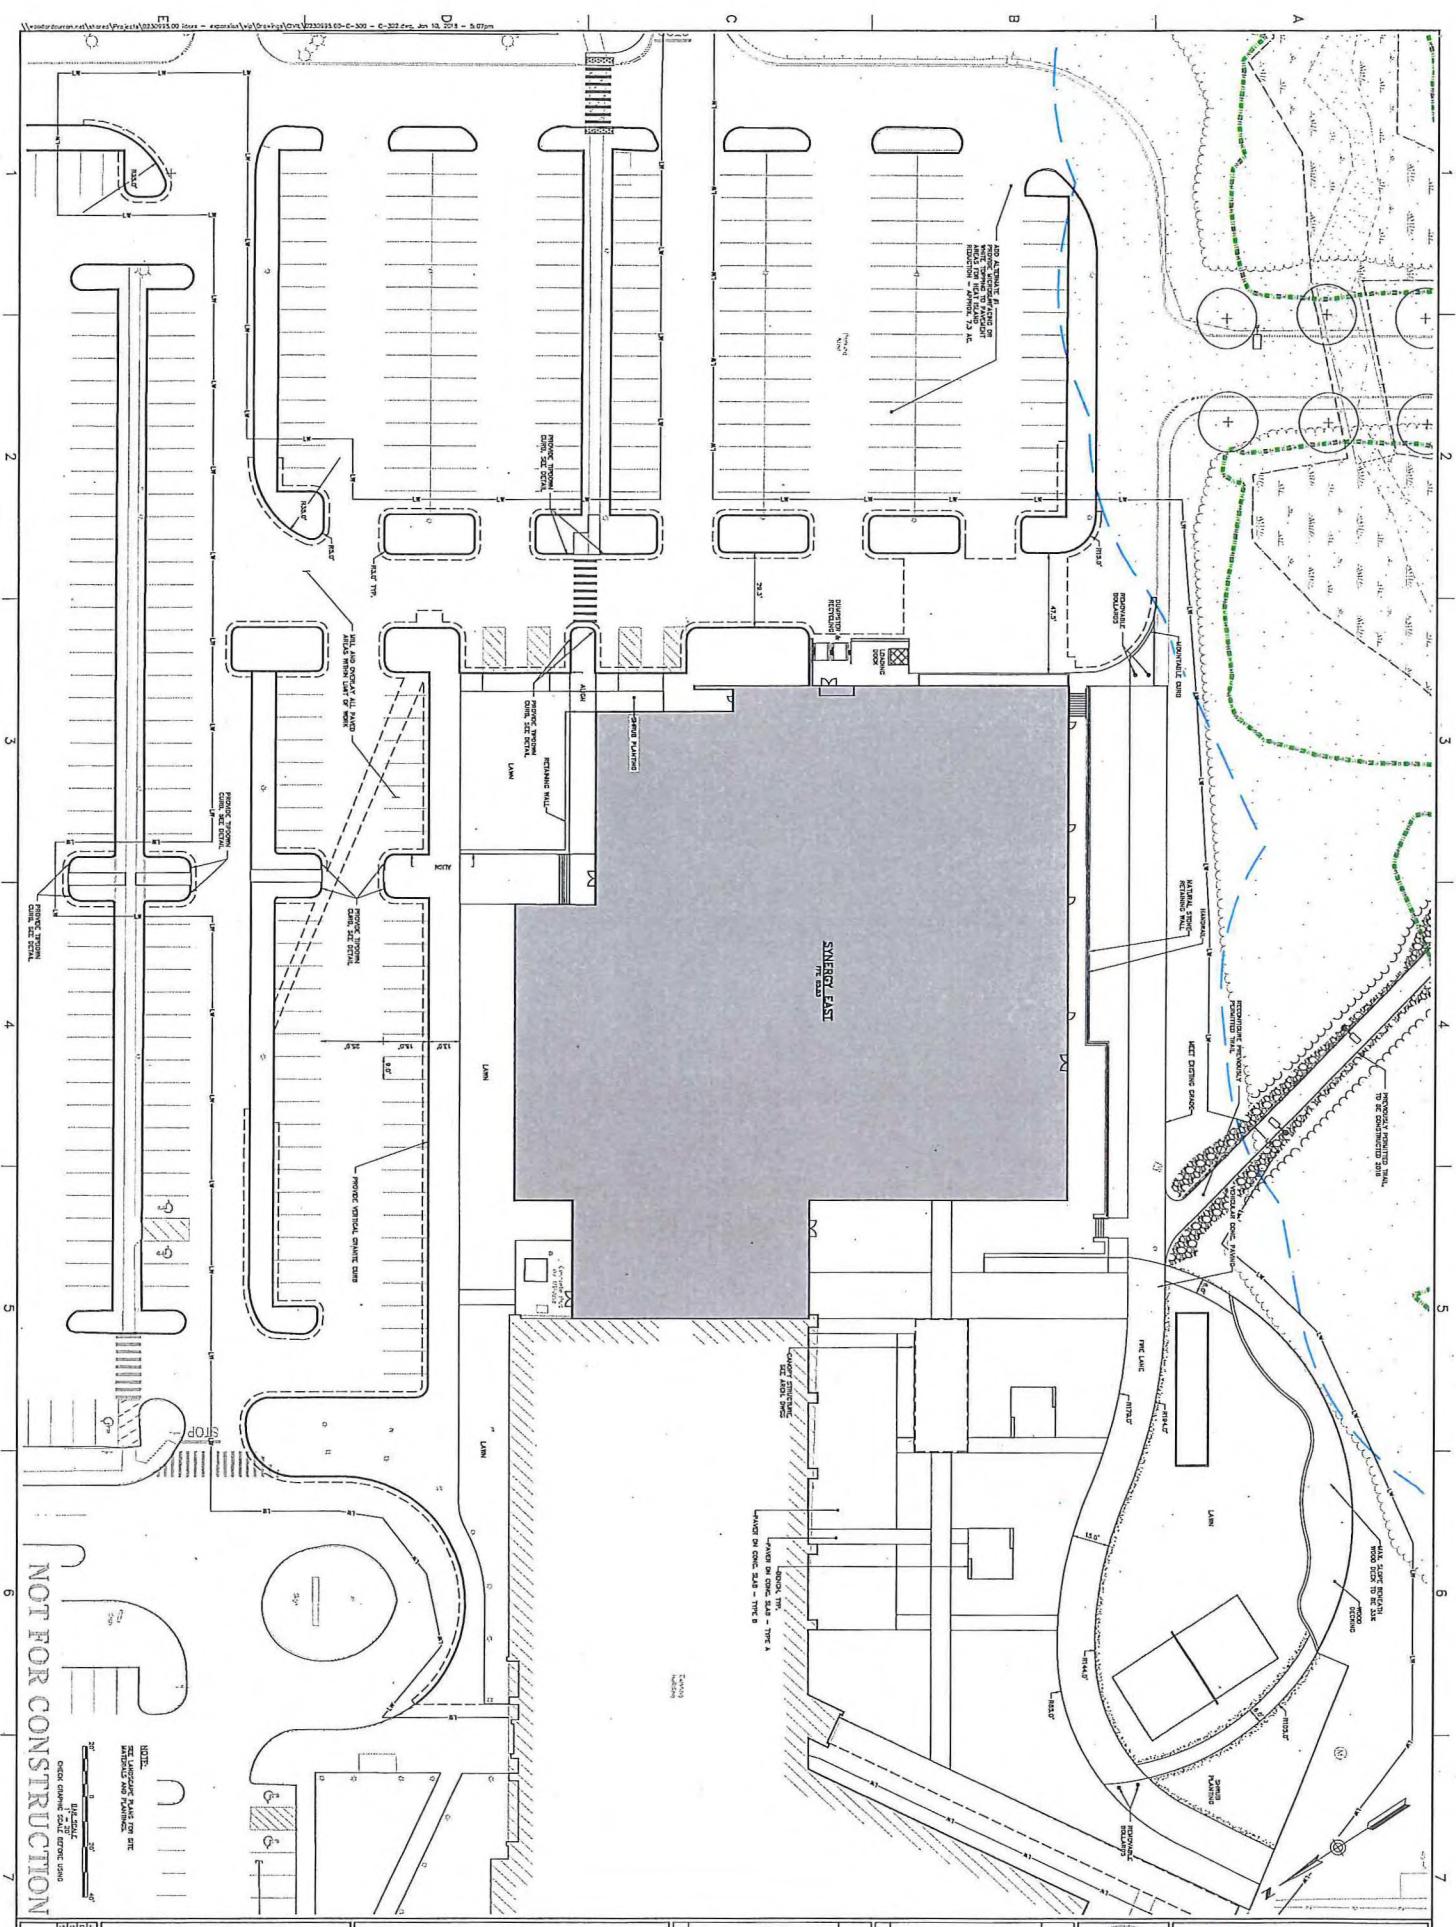



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DECODED BY: AEA	DRAWN BY: EAM		DECODED BY: ELC	DESIGNED BY: C-301 - C-302	
PRINTED BY: DRAFTS	SCALE: 1:250		PRINTED BY: DRAFTS	SCALE: 1:250	



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Portland, Maine 04102
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CONSTRUCTION & INTEGRITY DRIVEN RESULTS



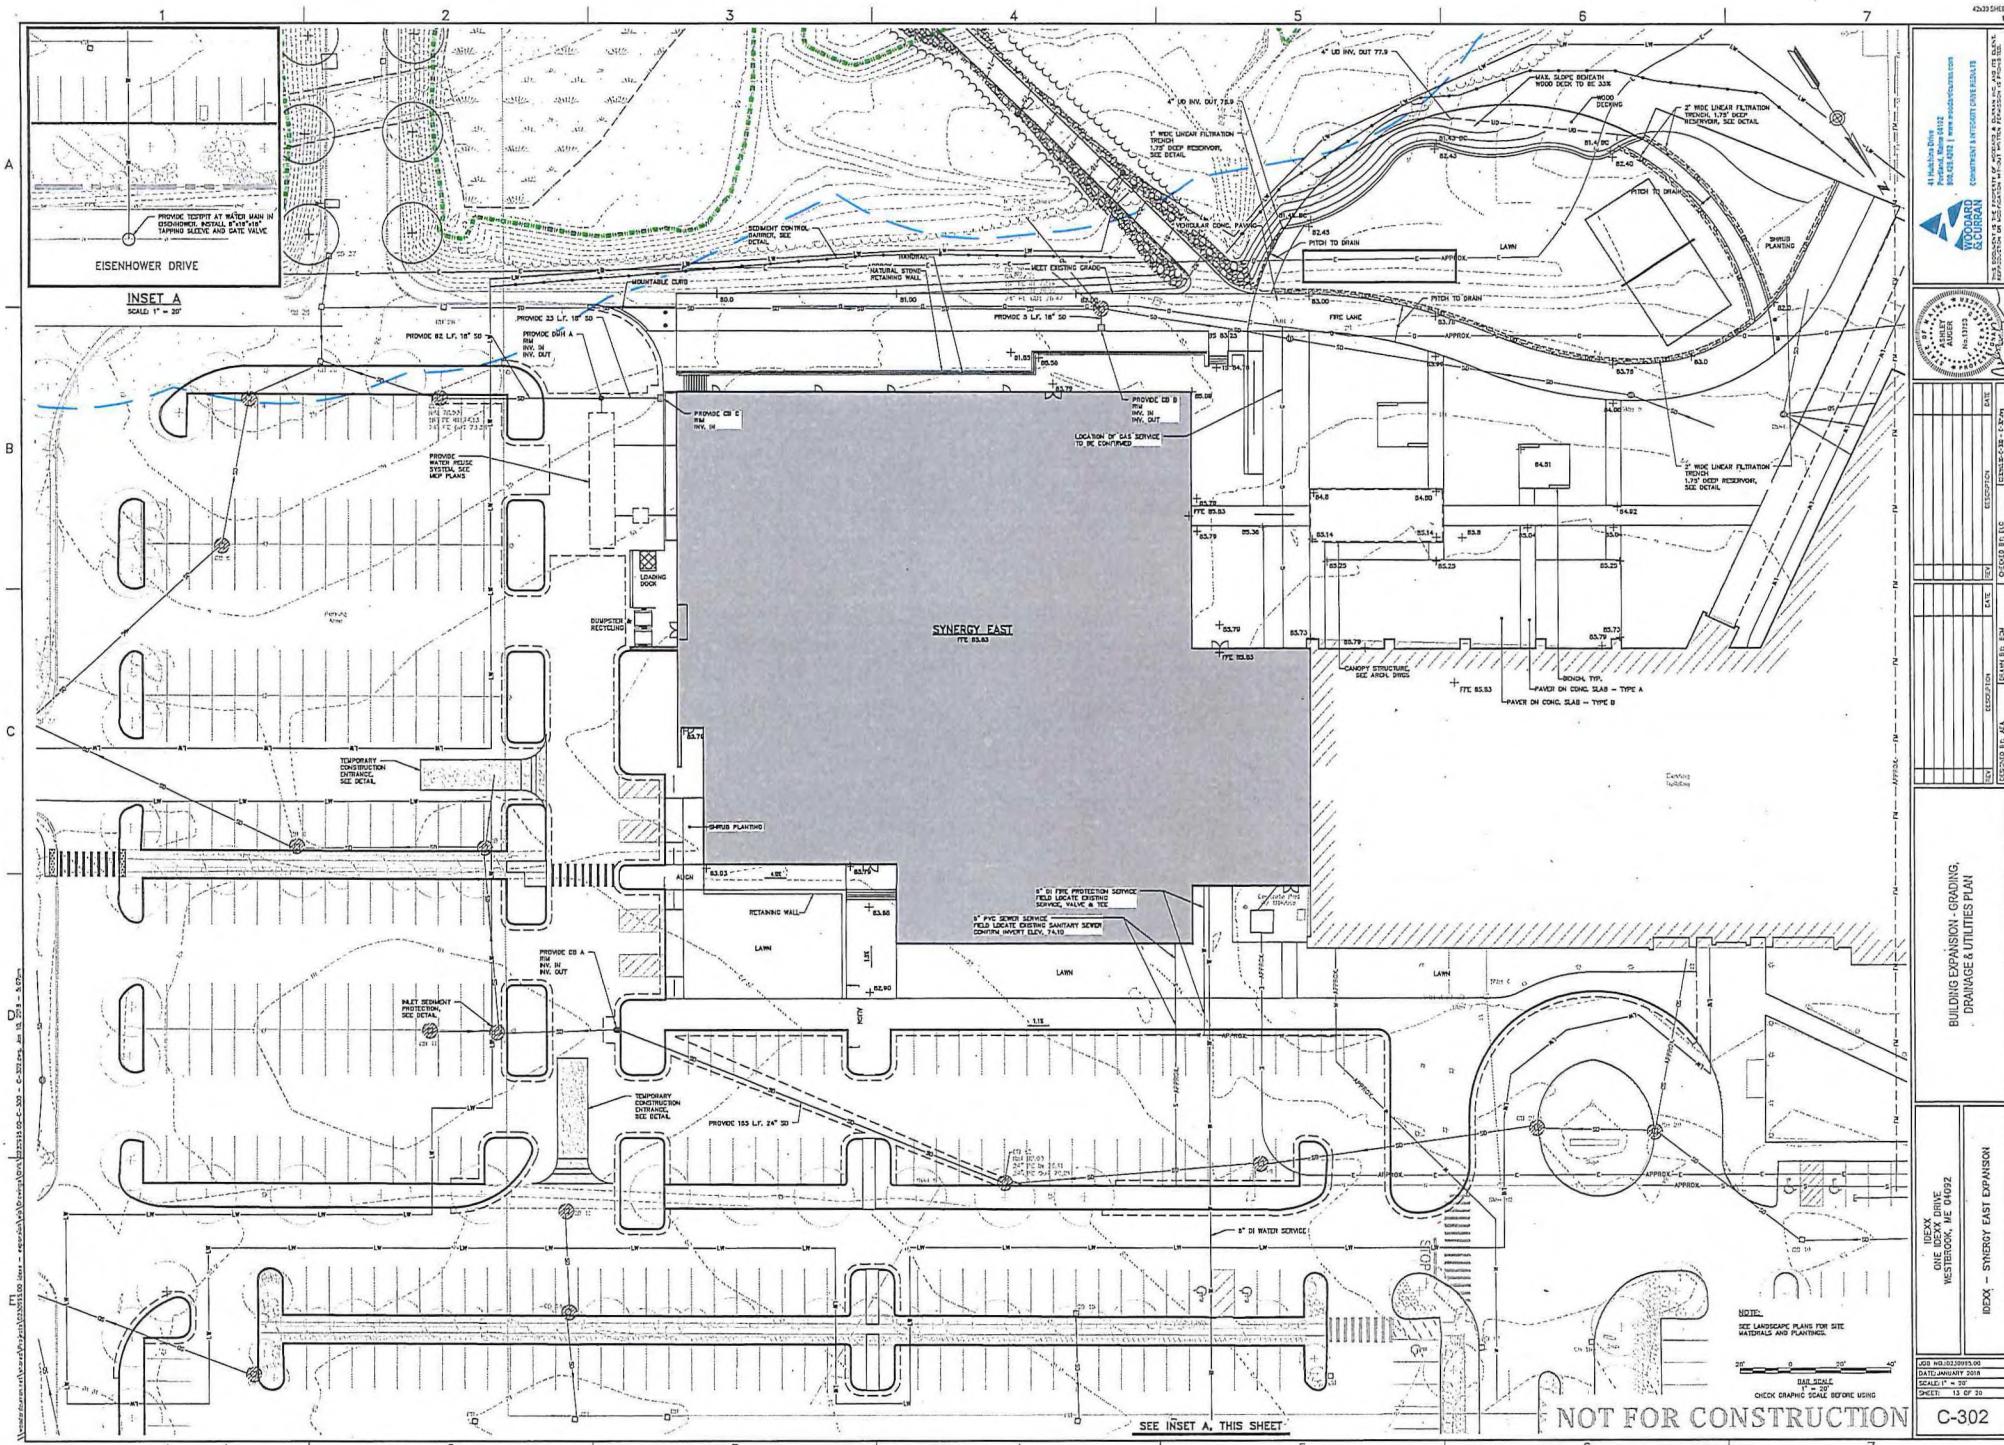

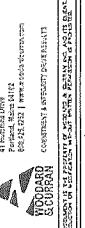MASSACHUSETTS
GENERAL ASSEMBLY
REGULAR SESSION
2013

SECTION	DESCRIPTION	DATE
1	NOT TO SCALE	
2	NOT TO SCALE	
3	NOT TO SCALE	
4	NOT TO SCALE	
5	NOT TO SCALE	
6	NOT TO SCALE	
7	NOT TO SCALE	

CIVIL DETAILS - 1

ONE INDEX DRIVE
HEWITT, NC 28347

INDEX - SYNERGY EAST EXPANSION

JULY NO. 03232012-00


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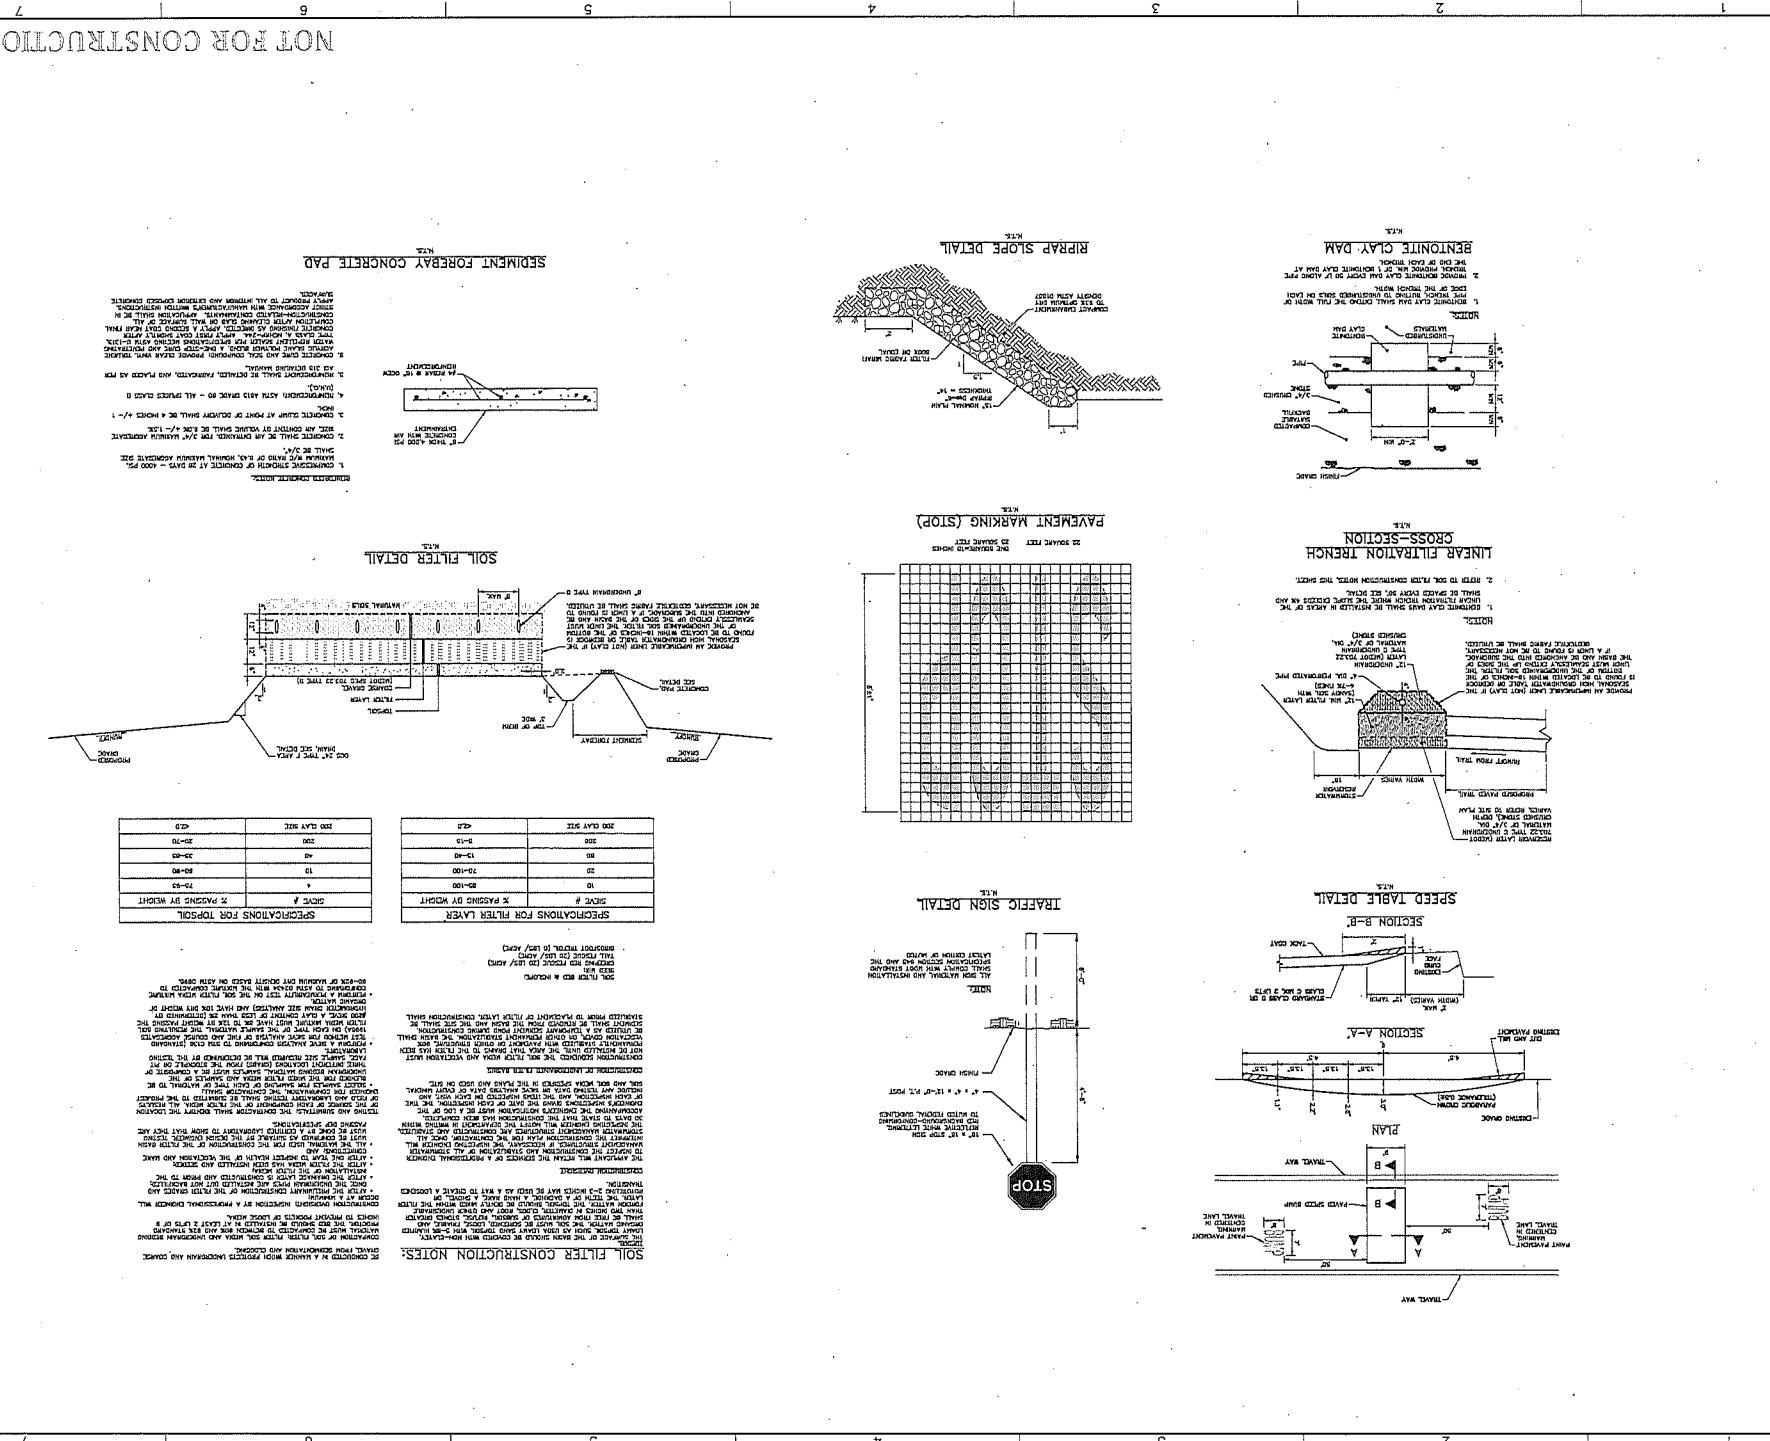
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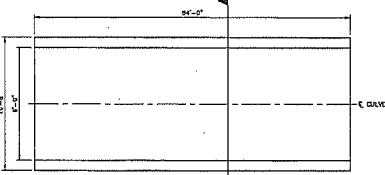
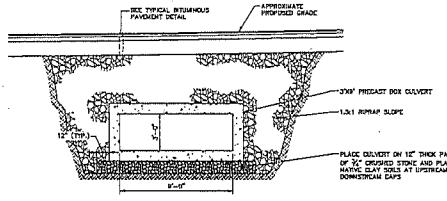
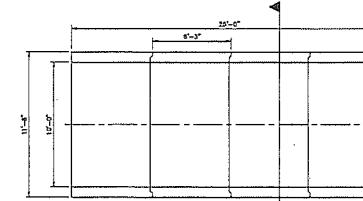
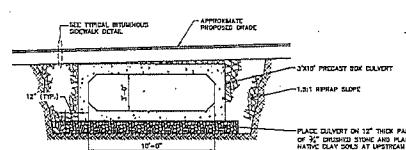
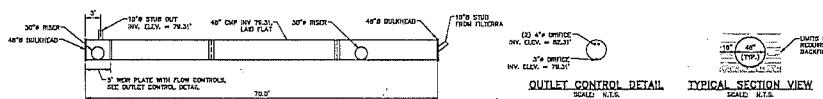
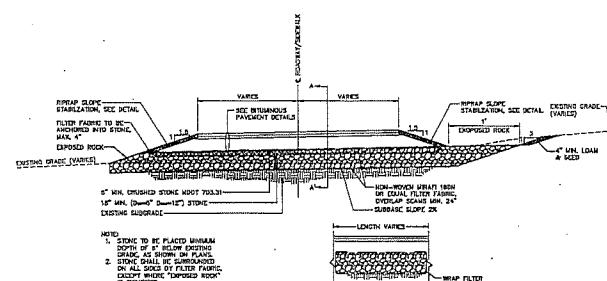
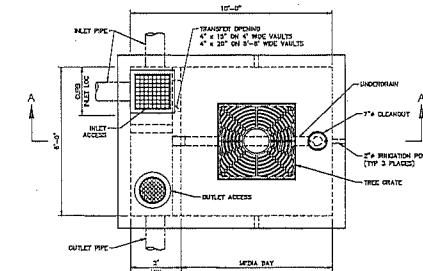
C-400




C-401

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BOX CULVERT #1 LAYOUT (PLAN VIEW)
K.I.S.BOX CULVERT #1 CROSS SECTION
K.I.S. 1 C-400BOX CULVERT #2 LAYOUT (PLAN VIEW)
K.I.S.BOX CULVERT #2 CROSS SECTION
K.I.S. 2 C-400TYPICAL SECTION VIEW
SCALE: N.T.S.48" CMP DETENTION SYSTEM - 4
SCALE: N.T.S.ROCK SANDWICH DETAIL
SCALE: N.T.S.

PLAN VIEW

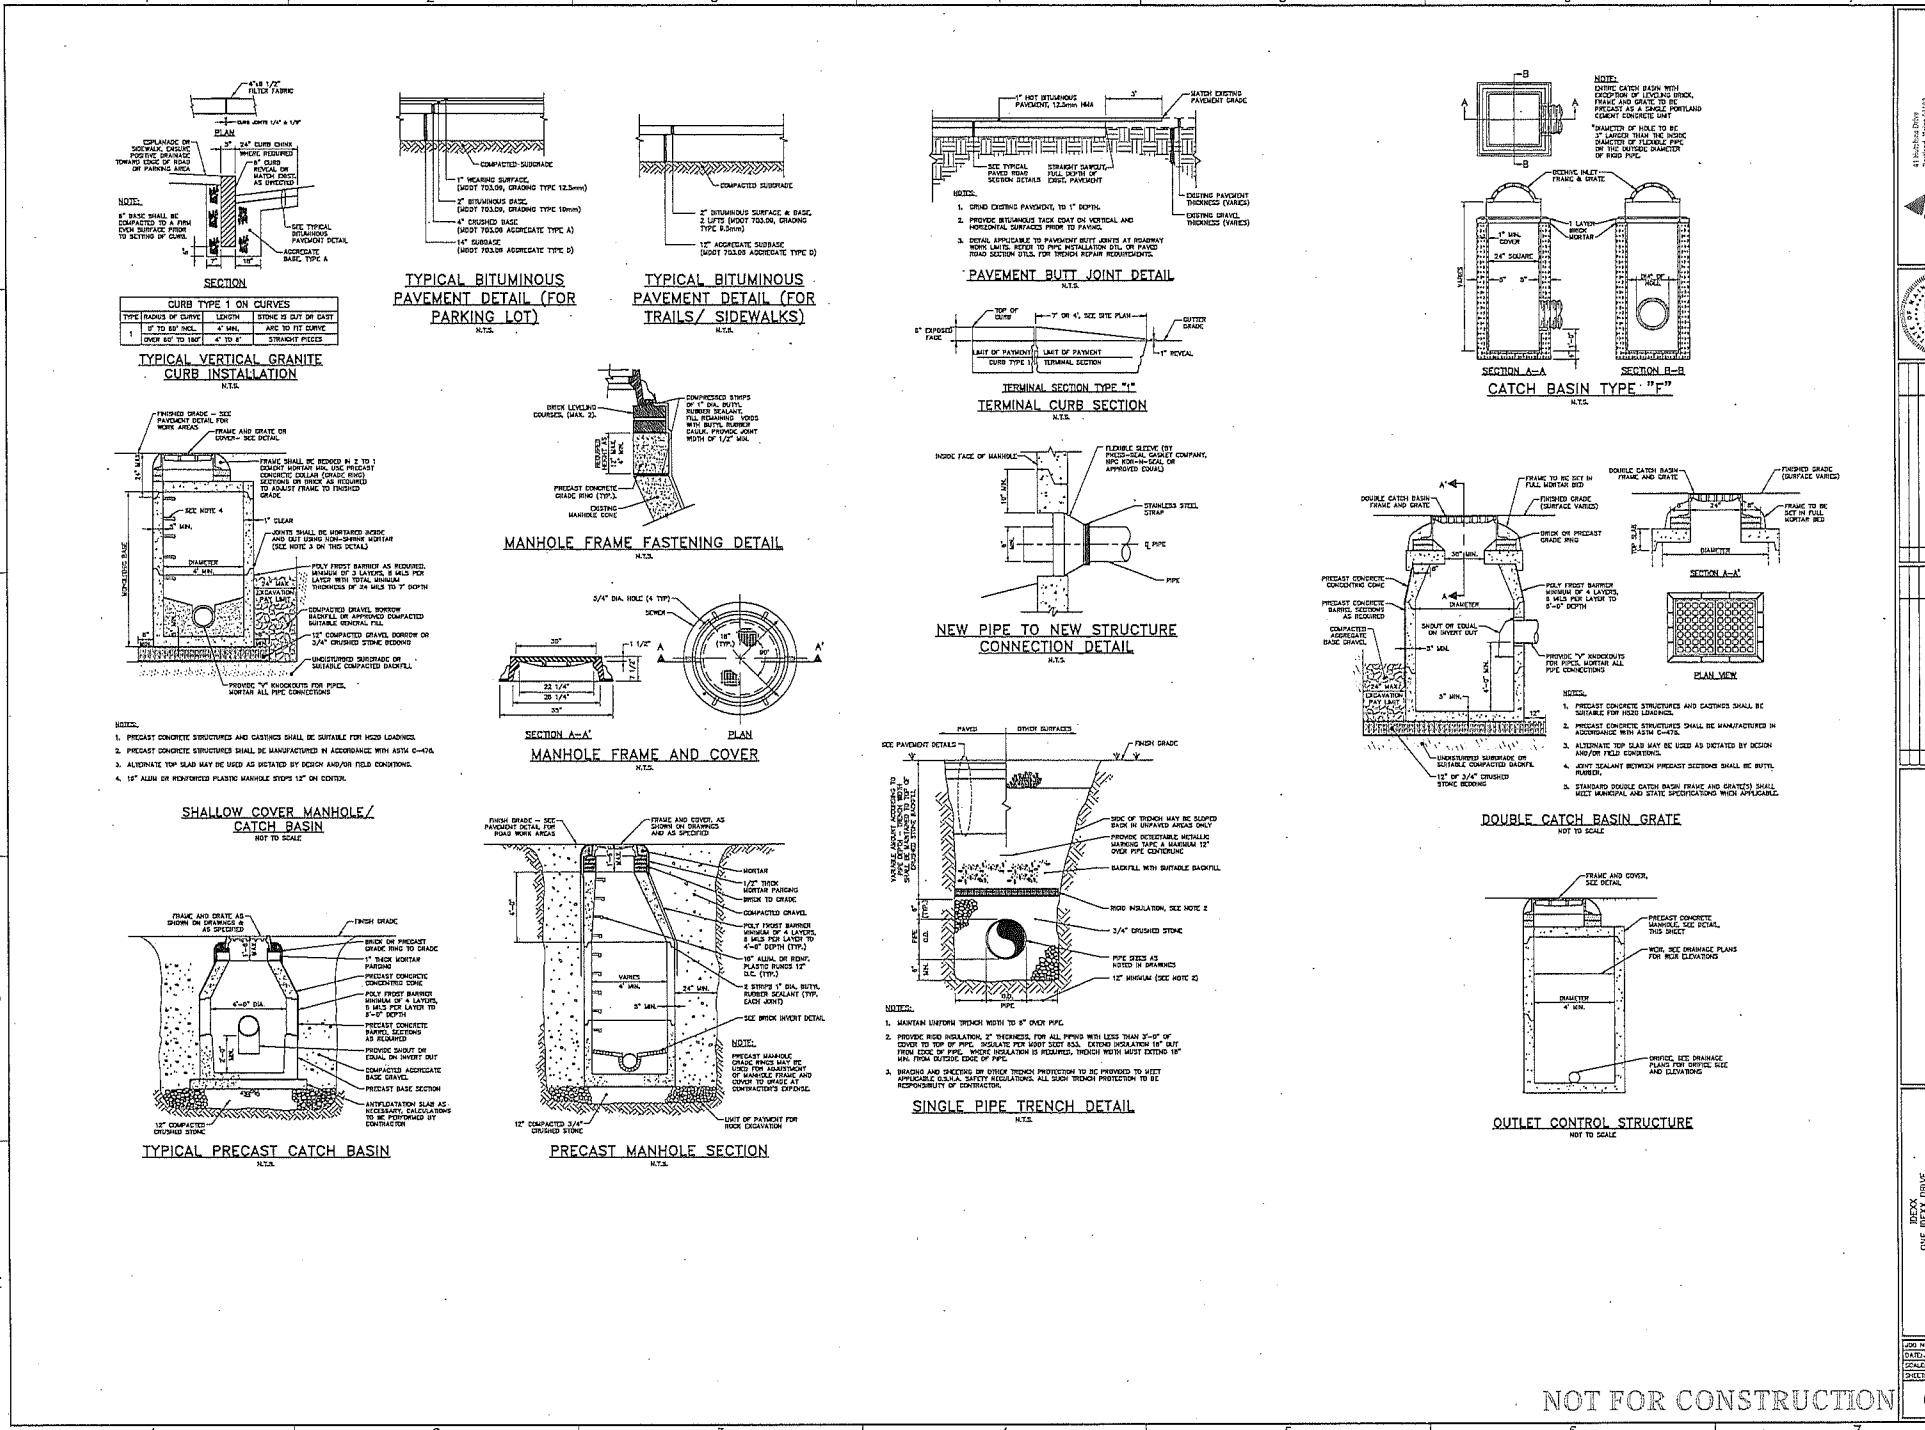FILTERRA PEAK DIVERSION (FTP0608-D) DETAIL
SCALE: N.T.S.

CIVIL DETAILS - 3

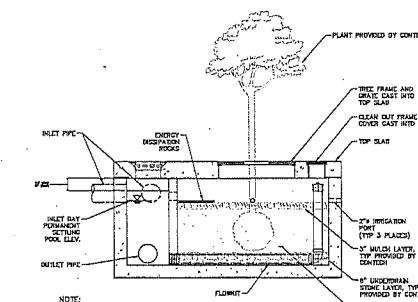DECK - ENERGY EAST EXPANSION

DECK - DECK REPAIR
WESTERDORF, MI 49652

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CIVIL DETAILS - 4

BEXX	CIV. BEXX DRIVE
	HEMBROL, IL 60142
	DETENTION SYSTEM 1.2


DETENTION SYSTEM 1.2
SFMH96 STORMFILTER PLAN AND SECTION
SCALE N.T.S.

17 OF 20

C-403

NOT FOR CONSTRUCTION

DETENTION SYSTEM 1.2
SFMH96 STORMFILTER PLAN AND SECTION
SCALE N.T.S.

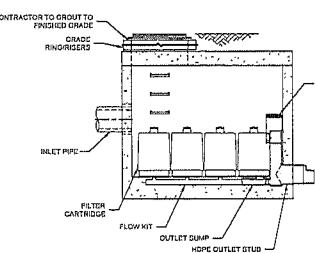

PLAN VIEW
STANDARD OUTLET RISER
FLOWHHR 10A


NOTE: FOR DETAILED CONSTRUCTION
DIMENSIONS CONTRACTOR SHALL CONTACT COTEC.

PLAN VIEW
STANDARD OUTLET RISER
FLOWHHR 10A


NOTE: FOR DETAILED CONSTRUCTION
DIMENSIONS CONTRACTOR SHALL CONTACT COTEC.

PLAN VIEW
STANDARD OUTLET RISER
FLOWHHR 10A


NOTE: FOR DETAILED CONSTRUCTION
DIMENSIONS CONTRACTOR SHALL CONTACT COTEC.

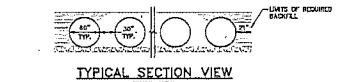


TYPICAL SECTION VIEW
SCALE N.T.S.

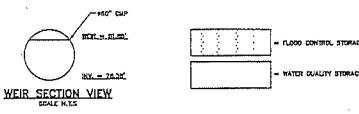

WEIR SECTION VIEW
SCALE N.T.S.

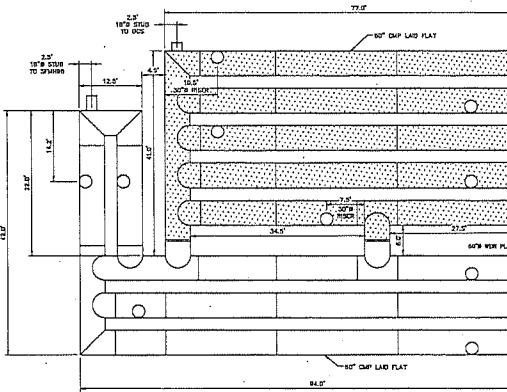


CMP DETENTION SYSTEM 1.2
SCALE N.T.S.

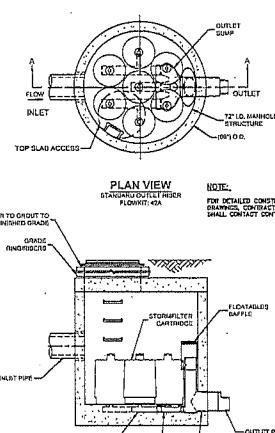


PLAN VIEW
STANDARD OUTLET RISER
FLOWHHR 10A

NOTE: FOR DETAILED CONSTRUCTION
DIMENSIONS CONTRACTOR SHALL CONTACT COTEC.


DETENTION SYSTEM 1.1
SFMH72 STORMFILTER PLAN AND SECTION
SCALE N.T.S.

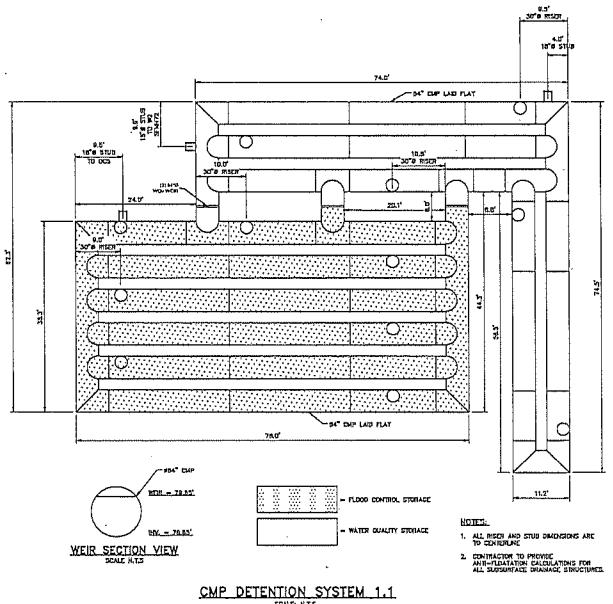

CMP DETENTION SYSTEM 1.1
SCALE N.T.S.

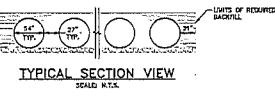

TYPICAL SECTION VIEW
SCALE N.T.S.

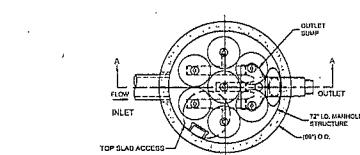

PLAN VIEW
STANDARD OUTLET RISER
FLOWHHR 10A

NOTE: FOR DETAILED CONSTRUCTION
DIMENSIONS CONTRACTOR SHALL CONTACT COTEC.

CONTRACTOR TO GROUT TO
FINISHED GRADE
GRANITE RINGED

STORMFILTER CARTIDGE

FLOTABLES BAFFLE

INLET PIPE

FLOW HHR
OUTLET SUM

HOLE CUTLET STUD

OUTLET PIPE

SECTION A-A

DETENTION SYSTEM 1.1
SFMH72 STORMFILTER PLAN AND SECTION
SCALE N.T.S.



SECTION	VIEW	SCALE
A	PLAN	1:200
B	SECTION	1:200
C	SECTION	1:200
D	SECTION	1:200
E	SECTION	1:200
F	SECTION	1:200
G	SECTION	1:200





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B	SECTION	1:200
C	SECTION	1:200
D	SECTION	1:200
E	SECTION	1:200
F	SECTION	1:200
G	SECTION	1:200

SECTION	VIEW	SCALE
A	PLAN	1:200
B	SECTION	1:200
C	SECTION	1:200
D	SECTION	1:200
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F	SECTION	1:200
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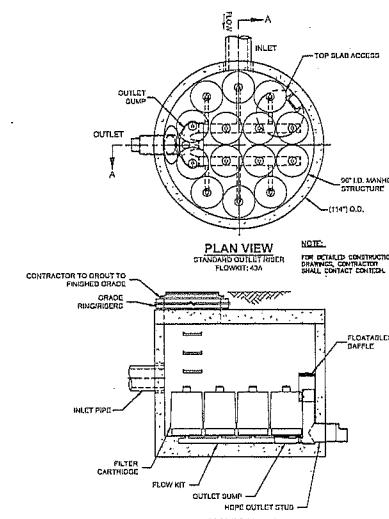
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B	SECTION	1:200
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D	SECTION	1:200
E	SECTION	1:200
F	SECTION	1:200
G	SECTION	1:200

SECTION	VIEW	SCALE
A	PLAN	1:200
B	SECTION	1:200
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D	SECTION	1:200
E	SECTION	1:200
F	SECTION	1:200
G	SECTION	1:200

SECTION	VIEW	SCALE
A	PLAN	1:200
B	SECTION	1:200
C	SECTION	1:200
D	SECTION	1:200
E	SECTION	1:200
F	SECTION	1:200
G	SECTION	1:200

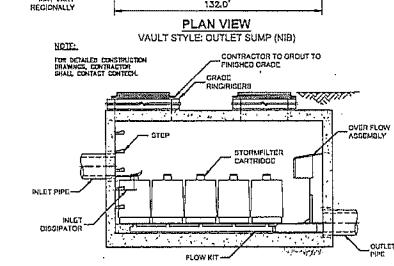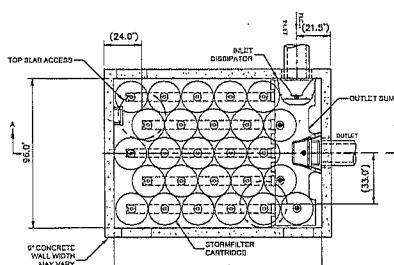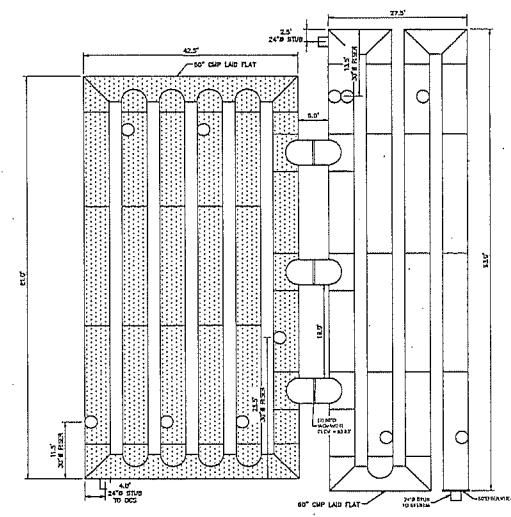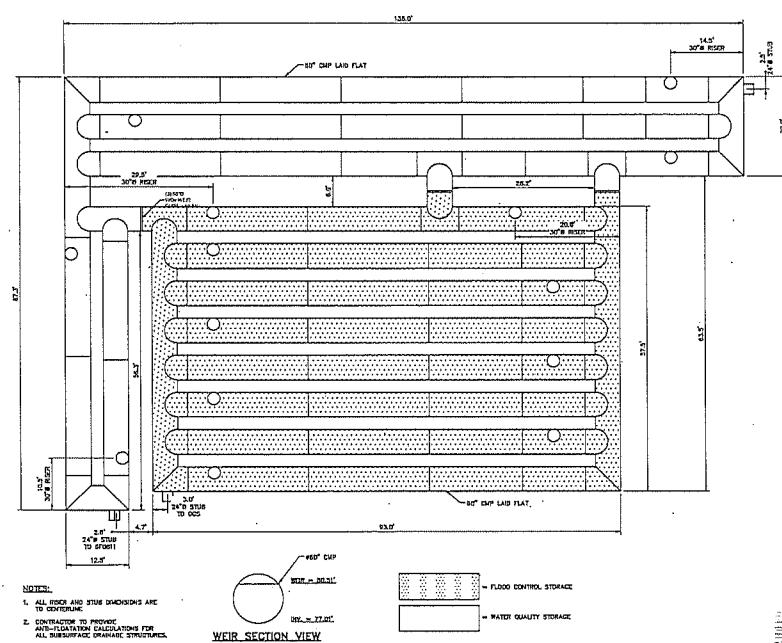






DETENTION SYSTEM 2
SF0811 STORMFILTER PLAN AND SECTION
SCALE 1:200



DET
SYN
EAST
EXPANSION
C-404


NOT FOR CONSTRUCTION

DET
SYN
EAST
EXPANSION
C-404

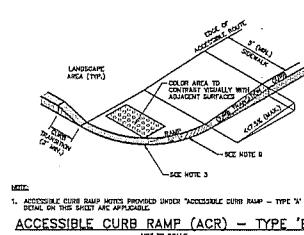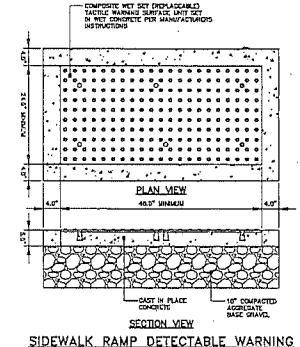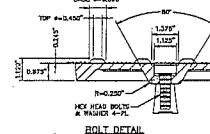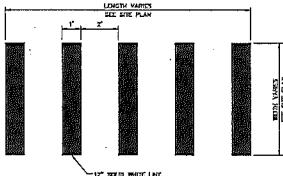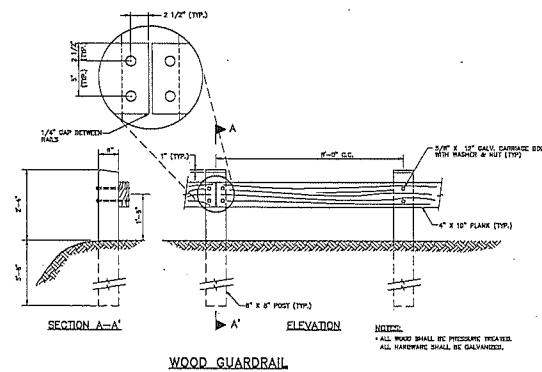

NOTES:

1. THE MAXIMUM ALLOWABLE SIDEWALK AND CURB RAMP CROSS SLOPES SHALL BE 1:50 (1% MAX).
2. BASE OF RAMP SHALL BE CRACKED TO PREVENT POCKING.
3. ADJACENT SURFACES AT TRANSITIONS SHALL BE FLUSH WITH CURB RAMPS.
4. SEE TYPICAL SIDEWALK SECTION FOR RAMP CONSTRUCTION.
5. CLEAN UP ALL CURVING AT RAMP (OTHER THAN VERTICAL CURVING), WHICH SHALL BE SET FLUSH WHERE IT ADJACTS HIGHWAY OR OTHER SURFACE.
6. DETECTABLE WARNING SHALL CONTRAST VISUALLY WITH ADJOINING SURFACES.
7. TRIMMED EDGES AND ALL RELATED INSTALLED SURFACES TO BE INSTALLED ACCORDING TO MANUFACTURER'S SPECIFICATIONS. ALL DETECTABLE WARNING SURFACE INSTALLATIONS SHALL BE AT A MINIMUM AT LEAST AS HIGH AS THE SURROUNDING PERIODIAN SURFACES.

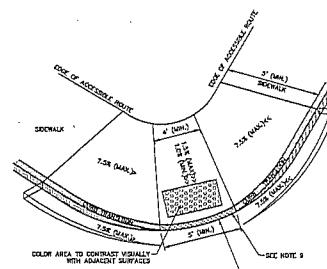

IDEXX
ONE IDEXX DRIVE
HESTRICK, ME 04022

IDEXX - SYNERGY EAST EXPANSION

JOB NO.0312095.00
DATE/January 2018
CIVIL
SHEET: 18 OF 20

C-405

NOT FOR CONSTRUCTION

Erosion and Sediment Control Notes

STABILIZED COUNTRY-
ENTRANCE DETAIL

LATITION ENCE DETAIL

EDIMENT BARRIER - SILTSOX

The diagram illustrates the internal structure of the INTEL SEMICONDUCTOR CONTROL DEVICE. It features a central vertical cylinder labeled 'THERMISTOR' at the top, which is connected to a rectangular component labeled '(P)'. Below this, a horizontal plate labeled 'CIRCUIT BOARD' contains a grid of small squares representing integrated circuit pads. A label 'SILICON CHIP' points to one of these pads. The entire assembly is mounted on a base labeled 'SUBSTRATE'. Various dimensions are indicated: 'H' for height, 'W' for width, and 'L' for length. Labels include 'INTEGRATED CIRCUIT', 'THERMISTOR', '(P)', 'CIRCUIT BOARD', 'SILICON CHIP', 'SUBSTRATE', 'W', 'H', and 'L'. A note at the bottom right states: 'NOT TO SCALE'.

ALIPRAP INLET/OUTLET PROTECTION

The diagram illustrates a geological cross-section labeled 'SECTION A-A''. It shows three distinct layers of sediment: 'LOWER HOLOCENE' at the bottom, 'MIDDLE HOLOCENE' in the middle, and 'UPPER HOLOCENE' at the top. A core sample has been taken from the 'UPPER HOLOCENE' layer, specifically from the 'TOP OF MIDDLE HOLOCENE' section. The cross-section also includes labels for 'SEA LEVEL' and 'TIDE LEVEL'. A vertical scale bar indicates distances from 0 to 10 meters.

ROLL-UP ERGOSION CONTROL MATTING