

**US Army Corps  
of Engineers®**  
New England District  
696 Virginia Road  
Concord, MA 01742-2751

# PUBLIC NOTICE

**Comment Period Begins: 5/14/2019**  
**Comment Period Ends: 6/14/2019**  
**File Number: NAE-2016-01554**  
**In Reply Refer To: Phillip Nimeskern**  
**Phone: (978) 318-8660**  
**E-mail: phillip.w.nimeskern@usace.army.mil**

The District Engineer has received a permit application to conduct work in navigable waters of the United States from the Town of Dennis, P.O. Box 2060, South Dennis, Massachusetts, 02660. This work is proposed on Chapin Beach in Cape Cod Bay off Dr. Bottero Road and Chapin Beach Road, Dennis, Massachusetts. The site coordinates are: Latitude 41.73612° N; Longitude -70.22844° W.

The work involves beach nourishment to restore the beach along Dr. Bottero Road, which will provide a natural buffer to dissipate wave energy and prevent further erosion of the beach and roadway. The work includes the placement of both sand for beach nourishment and stone for groin construction below the High Tide Line (approximately 19,110 cu. yds. and 710 cu. yds. respectively). Two stone groins will be constructed perpendicular to the shore for the purposes of stabilizing the sand fill, and extending the design life of the nourishment. The groins will be approximately 100' long and 69' long, measured from the mean high water (MHW) line, and vary from 5' to 32' wide. The groins will place 303 cu. yds. and 136 cu. yds. of fill below MHW, respectively. The area of disturbance below the High Tide Line for groins and beach fill is approximately 1,390' long and between 80' to 100' wide, for a total area of approximately 3.46 acres.

The sand for beach nourishment will be from an upland source and will match the grain size of the sand presently on the beach.

The work is shown on the attached plans entitled "Application by: Town of Dennis," on 8 sheets, and dated "March 2019."

Throughout the development of this project, the applicant has worked to avoid and minimize direct impacts to waters of the United States. As the project purpose is to stabilize an eroding beach, no compensatory mitigation is proposed.

## AUTHORITY

Permits are required pursuant to:

- Section 10 of the Rivers and Harbors Act of 1899
- Section 404 of the Clean Water Act
- Section 103 of the Marine Protection, Research and Sanctuaries Act.

The decision whether to issue a permit will be based on an evaluation of the probable impact of the proposed activity on the public interest. That decision will reflect the national concern for both protection and utilization of important resources. The benefit which may reasonably accrue from the proposal must be balanced against its reasonably foreseeable detriments. All factors which may be relevant to the proposal will be considered, including the cumulative effects thereof; among those are: conservation, economics, aesthetics, general

environmental concerns, wetlands, cultural value, fish and wildlife values, flood hazards, flood plain value, land use, navigation, shoreline erosion and accretion, recreation, water supply and conservation, water quality, energy needs, safety, food production and, in general, the needs and welfare of the people.

The Corps of Engineers is soliciting comments from the public; Federal, state, and local agencies and officials; Indian Tribes; and other interested parties in order to consider and evaluate the impacts of this proposed activity. Any comments received will be considered by the Corps of Engineers to determine whether to issue, modify, condition or deny a permit for this proposal. To make this decision, comments are used to assess impacts on endangered species, historic properties, water quality, general environmental effects, and the other public interest factors listed above. Comments are used in the preparation of an Environmental Assessment and/or an Environmental Impact Statement pursuant to the National Environmental Policy Act. Comments are also used to determine the need for a public hearing and to determine the overall public interest of the proposed activity.

Where the activity involves the discharge of dredged or fill material into waters of the United States or the transportation of dredged material for the purpose of disposing it in ocean waters, the evaluation of the impact of the activity in the public interest will also include application of the guidelines promulgated by the Administrator, US Environmental Protection Agency, under authority of Section 404(b) of the Clean Water Act, and/or Section 103 of the Marine Protection Research and Sanctuaries Act of 1972, as amended.

## **ESSENTIAL FISH HABITAT**

The Magnuson-Stevens Fishery Conservation and Management Act, as amended by the Sustainable Fisheries Act of 1996 (Public Law 104-267), requires all federal agencies to consult with the National Marine Fisheries Service on all actions, or proposed actions, permitted, funded, or undertaken by the agency, that may adversely affect Essential Fish Habitat (EFH).

This project will impact 3.5 acres of Essential Fish Habitat (EFH) for Atlantic cod (*Gadus morhua*), Atlantic sea scallop (*Placopecten magellanicus*), Atlantic wolffish (*Anarhichas lupus*), ocean pout (*Macrozoarces americanus*), red hake (*Urophycis chuss*), sand tiger shark (*Carcharias taurus*), silver hake (*Merluccius bilinearis*), smooth dogfish (*Mustelus canis*), surf clam (*Spisula solidissima*), windowpane flounder (*Scophthalmus aquosus*), winter flounder (*Pseudopleuronectes americanus*). This habitat consists of sandy, intertidal beach. Loss of this habitat may adversely affect these species. However, the District Engineer has made a preliminary determination that the site-specific adverse effect will not be substantial. Further consultation with the National Marine Fisheries Service regarding EFH conservation recommendations is being conducted and will be concluded prior to the final decision.

## **NATIONAL HISTORIC PRESERVATION ACT**

Based on his initial review, the District Engineer has determined that little likelihood exists for the proposed work to impinge upon properties with cultural or Native American significance, or listed in, or eligible for listing in, the National Register of Historic Places. Therefore, no further consideration of the requirements of Section 106 of the National Historic Preservation Act of 1966, as amended, is necessary. This determination is based upon one or more of the following:

- a. The permit area has been extensively modified by previous work.
- b. The permit area has been recently created.

- c. The proposed activity is of limited nature and scope.
- d. Review of the latest published version of the National Register shows that no presence of registered properties listed as being eligible for inclusion therein are in the permit area or general vicinity.
- e. Coordination with the State Historic Preservation Officer and/or Tribal Historic Preservation Officer(s)

## **ENDANGERED SPECIES CONSULTATION**

The New England District, Army Corps of Engineers has reviewed the list of species protected under the Endangered Species Act of 1973, as amended, which might occur at the project site. A threatened species, the piping plover (*Charadrius melanotos*), has been found on Chapin Beach during its entire breeding cycle. It is our preliminary determination that the proposed activity for which authorization is being sought is designed, situated or will be operated/used in such a manner that it is not likely to adversely affect any federally listed endangered or threatened species or their designated critical habitat. By this Public Notice, we are requesting that the appropriate Federal Agency concur with our determination.

## **COASTAL ZONE MANAGEMENT**

The States of Connecticut, Maine, Massachusetts, New Hampshire and Rhode Island have approved Coastal Zone Management Programs. Where applicable, the applicant states that any proposed activity will comply with and will be conducted in a manner that is consistent with the approved Coastal Zone Management Program. By this Public Notice, we are requesting the State concurrence or objection to the applicant's consistency statement.

The following authorizations have been applied for, or have been, or will be obtained:


- (x) Permit, License or Assent from State.
- (x) Permit from Local Wetland Agency or Conservation Commission.
- (x) Water Quality Certification in accordance with Section 401 of the Clean Water Act.

In order to properly evaluate the proposal, we are seeking public comment. Anyone wishing to comment is encouraged to do so. Comments should be submitted in writing by the above date. If you have any questions, please contact Phillip Nimeskern at (978) 318-8660, (800) 343-4789 or (800) 362-4367, if calling from within Massachusetts.

Any person may request, in writing, within the comment period specified in this notice, that a public hearing be held to consider the application. Requests for a public hearing shall specifically state the reasons for holding a public hearing. The Corps holds public hearings for the purpose of obtaining public comments when that is the best means for understanding a wide variety of concerns from a diverse segment of the public.

The initial determinations made herein will be reviewed in light of facts submitted in response to this notice. All comments will be considered a matter of public record. Copies of letters of objection will be forwarded to the applicant who will normally be requested to contact objectors directly in an effort to reach an understanding.

**THIS NOTICE IS NOT AN AUTHORIZATION TO DO ANY WORK.**

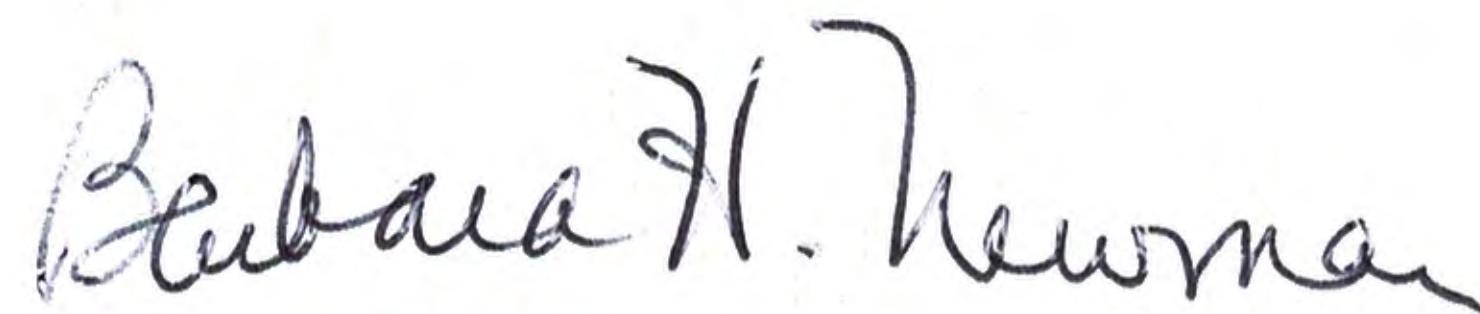

**Barbara H. Newman  
Chief, Permits and Enforcement Branch  
Regulatory Division**

If you would prefer not to continue receiving Public Notices by email, please contact Ms. Tina Chaisson at (978) 318-8058 or e-mail her at [bettina.m.chaisson@usace.army.mil](mailto:bettina.m.chaisson@usace.army.mil). You may also check here (  ) and return this portion of the Public Notice to: Bettina Chaisson, Regulatory Division, U.S. Army Corps of Engineers, 696 Virginia Road, Concord, MA 01742-2751.

NAME: \_\_\_\_\_

ADDRESS: \_\_\_\_\_


PHONE: \_\_\_\_\_

# IMPROVING COASTAL RESILIENCY AT DR. BOTTERO ROAD AND CHAPIN BEACH DENNIS, MASSACHUSETTS

MARCH 2019



PREPARED FOR:

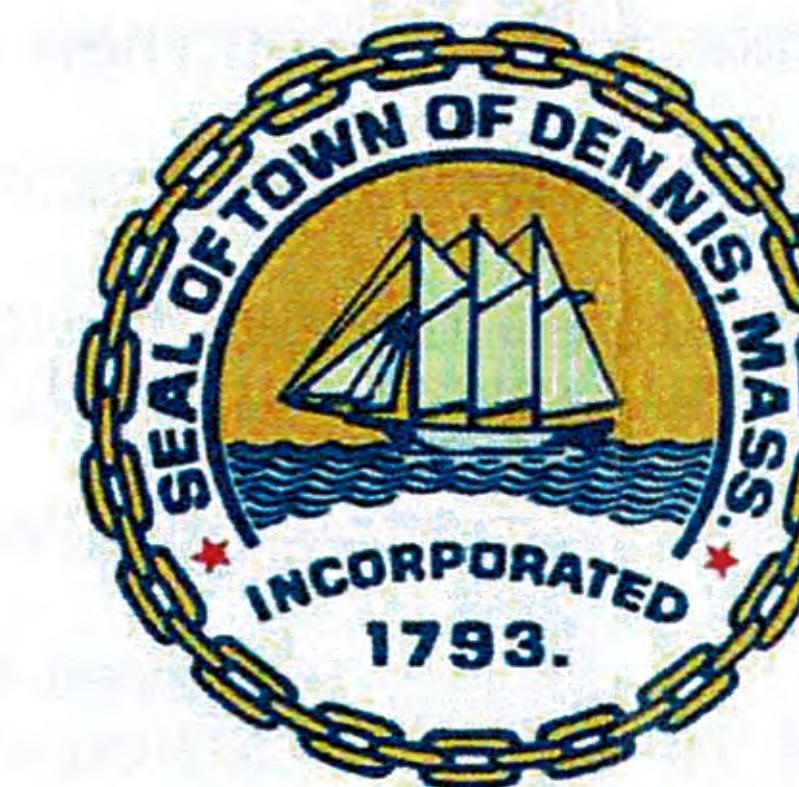

Town of Dennis  
685 Route 134  
South Dennis, Massachusetts 02660

PREPARED BY:



environmental consulting  
& engineering services

100 Fifth Avenue, 5th Floor  
Waltham, Massachusetts 02451  
p 781.419.7696  
www.essgroup.com



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Mashpee, Massachusetts 02649  
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2 OF 8	GENERAL NOTES
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8 OF 8	MONITORING TRANSECTS

For US Army Corps of Engineers Permit Application

**GENERAL NOTES:**

- THE HORIZONTAL DATUM SHOWN HEREON IS THE NORTH AMERICAN DATUM OF 1983 (NAD-83) MASSACHUSETTS STATE PLANE COORDINATE SYSTEM, FEET.
- THE VERTICAL DATUM FOR TOPOGRAPHY AND BATHYMETRY REFERENCES NAVD88. LiDAR WAS OBTAINED FROM AIRSHARK 12/06/2016.
- TOPOGRAPHIC DATA OBTAINED FROM AIRSHARK WAS USED TO DERIVE MEAN HIGH WATER (MHW) AND HIGH TIDE LINE (HTL). MEAN LOW WATER (MLW) OUTSIDE OF PLAN VIEW AND PROJECT AREA. MLW = -5.2 FT. TIDAL DATUMS BASED ON TIDAL BENCHMARK 8443970.
- FEMA FLOOD HAZARD ELEVATIONS AND ZONES FROM FEMA FIS AND FIRM NO. 25001C0576J, EFFECTIVE DATE JULY 16, 2014.
- PROPOSED BEACH NOURISHMENT AND GROIN DESIGN PROVIDED BY APPLIED COASTAL RESEARCH AND ENGINEERING, INC.
- SOURCE OF PROPERTY LINES: MassGIS LEVEL 3 ASSESSOR'S PARCEL MAPPING, 2018 AND SURVEY PROVIDED BY TOWN OF DENNIS.

**SEDIMENTATION & EROSION CONTROL NOTES:**

- THE CONTRACTOR SHALL PROVIDE EROSION CONTROL MEASURES, AS SPECIFIED ON THE DRAWINGS AS NECESSARY, AND AS REQUIRED BY THE PERMITS.
- PERIMETER SOIL AND EROSION CONTROLS SHALL BE PLACED PRIOR TO ANY CONSTRUCTION ACTIVITIES. CONTRACTOR TO NOTIFY THE ENGINEER AT LEAST 48 HOURS PRIOR TO ANY CONSTRUCTION ACTIVITIES. ALL SOIL AND EROSION CONTROLS SHALL BE CHECKED AND REPAIRED AS NECESSARY BY THE CONTRACTOR.
- THE CONTRACTOR SHALL PROVIDE SUPPLEMENTAL EROSION CONTROL MEASURES TO PREVENT OFF-SITE TRANSPORT OF EARTH, SEDIMENT AND DEBRIS AS NECESSARY.
- TEMPORARY STOCKPILES OF EXCAVATED MATERIAL SHALL BE LOCATED ON-SITE, WITHIN THE DESIGNATED AREA(S). ANY MATERIAL NOT RE-USED ON-SITE SHALL BE TRUCKED TO AN ACCEPTABLE OFF-SITE DISPOSAL LOCATION IN ACCORDANCE WITH THE PROJECT'S PERMITS.
- EROSION CONTROL MEASURES SHALL BE INSPECTED DAILY AND DURING AND AFTER EVERY RAIN EVENT. ANY NECESSARY REPLACEMENT OR REPAIR SHALL BE PERFORMED PROMPTLY BY THE CONTRACTOR.
- DUST SHALL BE CONTROLLED IN ACCORDANCE WITH THE SPECIFICATIONS AND APPLICABLE REGULATIONS.
- THE CONTRACTOR SHALL PHASE EXCAVATION OPERATIONS TO MINIMIZE THE AREA DISTURBED OR OPEN TO THE ELEMENTS AT ANY GIVEN TIME.
- THE SITE SHALL BE LEFT IN A STABLE CONDITION AT THE CLOSE OF EACH DAY.

TIDAL DATUMS	
MLW	-5.2 FT
NAVD88	0 FT
MHW	4.3 FT
HTL	6.7 FT
100-YR FLOOD*	14-16 FT

\*FEMA FLOOD HAZARD ELEVATIONS AND ZONES FROM FEMA FIS AND FIRM NO. 25001C0576J, EFFECTIVE DATE JULY 16, 2014.

**CONSTRUCTION NOTES:**

- THE CONTRACTOR SHALL CALL "DIG SAFE" AT 1-888-344-7233 AT LEAST 72 HOURS PRIOR TO EXCAVATION IN ACCORDANCE WITH COMMONWEALTH OF MASSACHUSETTS, GENERAL LAWS C39-1.2.
- THE CONTRACTOR SHALL NOTIFY ALL APPROPRIATE AGENCIES AND UTILITY COMPANIES, IN WRITING, 48 HOURS PRIOR TO ANY WORK WITHIN 15 FEET OF A UTILITY LINE.
- THE CONTRACTOR SHALL, UNDER THE DIRECTION OF THE ENGINEER, ESTABLISH "CONSTRUCTION LIMITS" ON THE SITE BY ACCEPTABLE VISIBLE MARKERS. ALL WORK AND EQUIPMENT SHALL BE CONFINED TO WITHIN THESE LIMITS, UNLESS OTHERWISE SPECIFICALLY AUTHORIZED.
- NO CHANGES ARE TO BE MADE UNLESS AUTHORIZED BY THE TOWN OR THE TOWN AUTHORIZED ENGINEER.
- THE CONTRACTOR SHALL COMPLY WITH ALL APPLICABLE FEDERAL, STATE AND LOCAL SAFETY CODES, REGULATIONS, LEGAL REQUIREMENTS, PERMIT CONDITIONS, ETC.
- THE CONTRACTOR SHALL TAKE ADEQUATE PRECAUTIONS TO PROTECT ALL WALKS, STREETS, PAVEMENTS, HIGHWAY GUARDS, CURBING, EDGING, TREES, PLANTINGS, STRUCTURES, PIPES, ETC. ON OR OFF THE PREMISES, AND SHALL REPAIR AND REPLACE OR OTHERWISE MAKE GOOD AT HIS/HER OWN EXPENSE AS REQUIRED BY THE TOWN OR THE TOWN AUTHORIZED ENGINEER ANY ITEMS DAMAGED AS A RESULT OF THE CONTRACTOR'S WORK.
- THE CONTRACTOR SHALL DISPOSE OF ALL STUMPS, RUBBISH AND DEBRIS IN ACCORDANCE WITH THE SPECIFICATIONS AND ALL APPLICABLE CODES AND REGULATIONS. THE CONTRACTOR SHALL LEAVE THE PROJECT SITE IN SAFE AND CLEAN CONDITION UPON COMPLETION OF EXCAVATION OPERATIONS.

- THE CONTRACTOR SHALL PROVIDE ADEQUATE BRACING AND SHORING OF EXCAVATIONS IN ACCORDANCE WITH THE REQUIREMENTS OF ALL GOVERNING CODES AND REGULATIONS.
- ALL SURFACES DISTURBED BY THIS WORK SHALL BE RESTORED TO THEIR ORIGINAL CONDITION AS DETAILED OR AS SPECIFIED BY THE ENGINEER.
- EXCAVATION SEQUENCE SHALL BE COORDINATED TO MINIMIZE DISTURBANCE OF EXISTING CONDITIONS AND OPERATIONS.
- EXCAVATION SHALL TAKE PLACE WITHIN APPROVED WORK WINDOWS.
- ALL EXISTING PIPING AND STRUCTURES EXPOSED DURING EXCAVATION SHALL BE ADEQUATELY SUPPORTED, BRACED, OR OTHERWISE PROTECTED DURING EXCAVATION ACTIVITIES.
- ALL NECESSARY FEES AND PERMITS SHALL BE OBTAINED AND PAID FOR BY THE CONTRACTOR.
- WORK SHALL COMPLY WITH APPLICABLE MUNICIPAL, STATE, AND FEDERAL PERMITS AND REQUIREMENTS.

**UTILITIES NOTES:**

- BEFORE COMMENCEMENT OF EXCAVATION, THE CONTRACTOR SHALL BE SOLELY RESPONSIBLE FOR MAKING ALL NECESSARY ARRANGEMENTS AND FOR PERFORMING ANY NECESSARY WORK INVOLVED IN CONNECTION WITH THE DISCONTINUANCE OR JURISDICTION OF THE UTILITY COMPANIES, SUCH AS ELECTRICITY, TELEPHONE, WATER, GAS AND ANY SYSTEM OR SYSTEMS WHICH WILL BE AFFECTED BY THE WORK TO BE PERFORMED UNDER THIS CONTRACT.
- UNLESS OTHERWISE NOTED OR APPROVED BY THE ENGINEER OR OWNER, THE CONTRACTOR SHALL MAINTAIN ALL EXISTING UTILITIES.
- IF REQUIRED, OVERHEAD LINES SHALL BE RELOCATED BY THE UTILITY COMPANY AT THE CONTRACTOR'S EXPENSE.
- WHERE AN EXISTING UTILITY IS FOUND TO CONFLICT WITH THE PROPOSED WORK, THE LOCATION, ELEVATION AND SIZE OF THE UTILITY SHALL BE ACCURATELY DETERMINED WITHOUT DELAY BY THE CONTRACTOR AND THE INFORMATION FURNISHED TO THE ENGINEER AND OWNER FOR RESOLUTION OF THE CONFLICT.



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No.	REVISION	DATE	APP BY
DRAWN BY: SJC	CHECKED BY: PRW		
DESIGNED BY: SJC	APPROVED BY: PRW		

Application by:  
**TOWN OF DENNIS**


AT: DENNIS  
IN: CAPE COD BAY  
BARNSTABLE COUNTY  
COMMONWEALTH OF MASSACHUSETTS

DR. BOTTERO ROAD & CHAPIN BEACH  
IMPROVING COASTAL RESILIENCY

**GENERAL NOTES**

PROJECT No.: D186-000.04	SHEET No.
DATE OF ISSUE: MARCH 2019	
SHEET No.: 2 OF 8	
SCALE: N/A	

**2 OF 8**

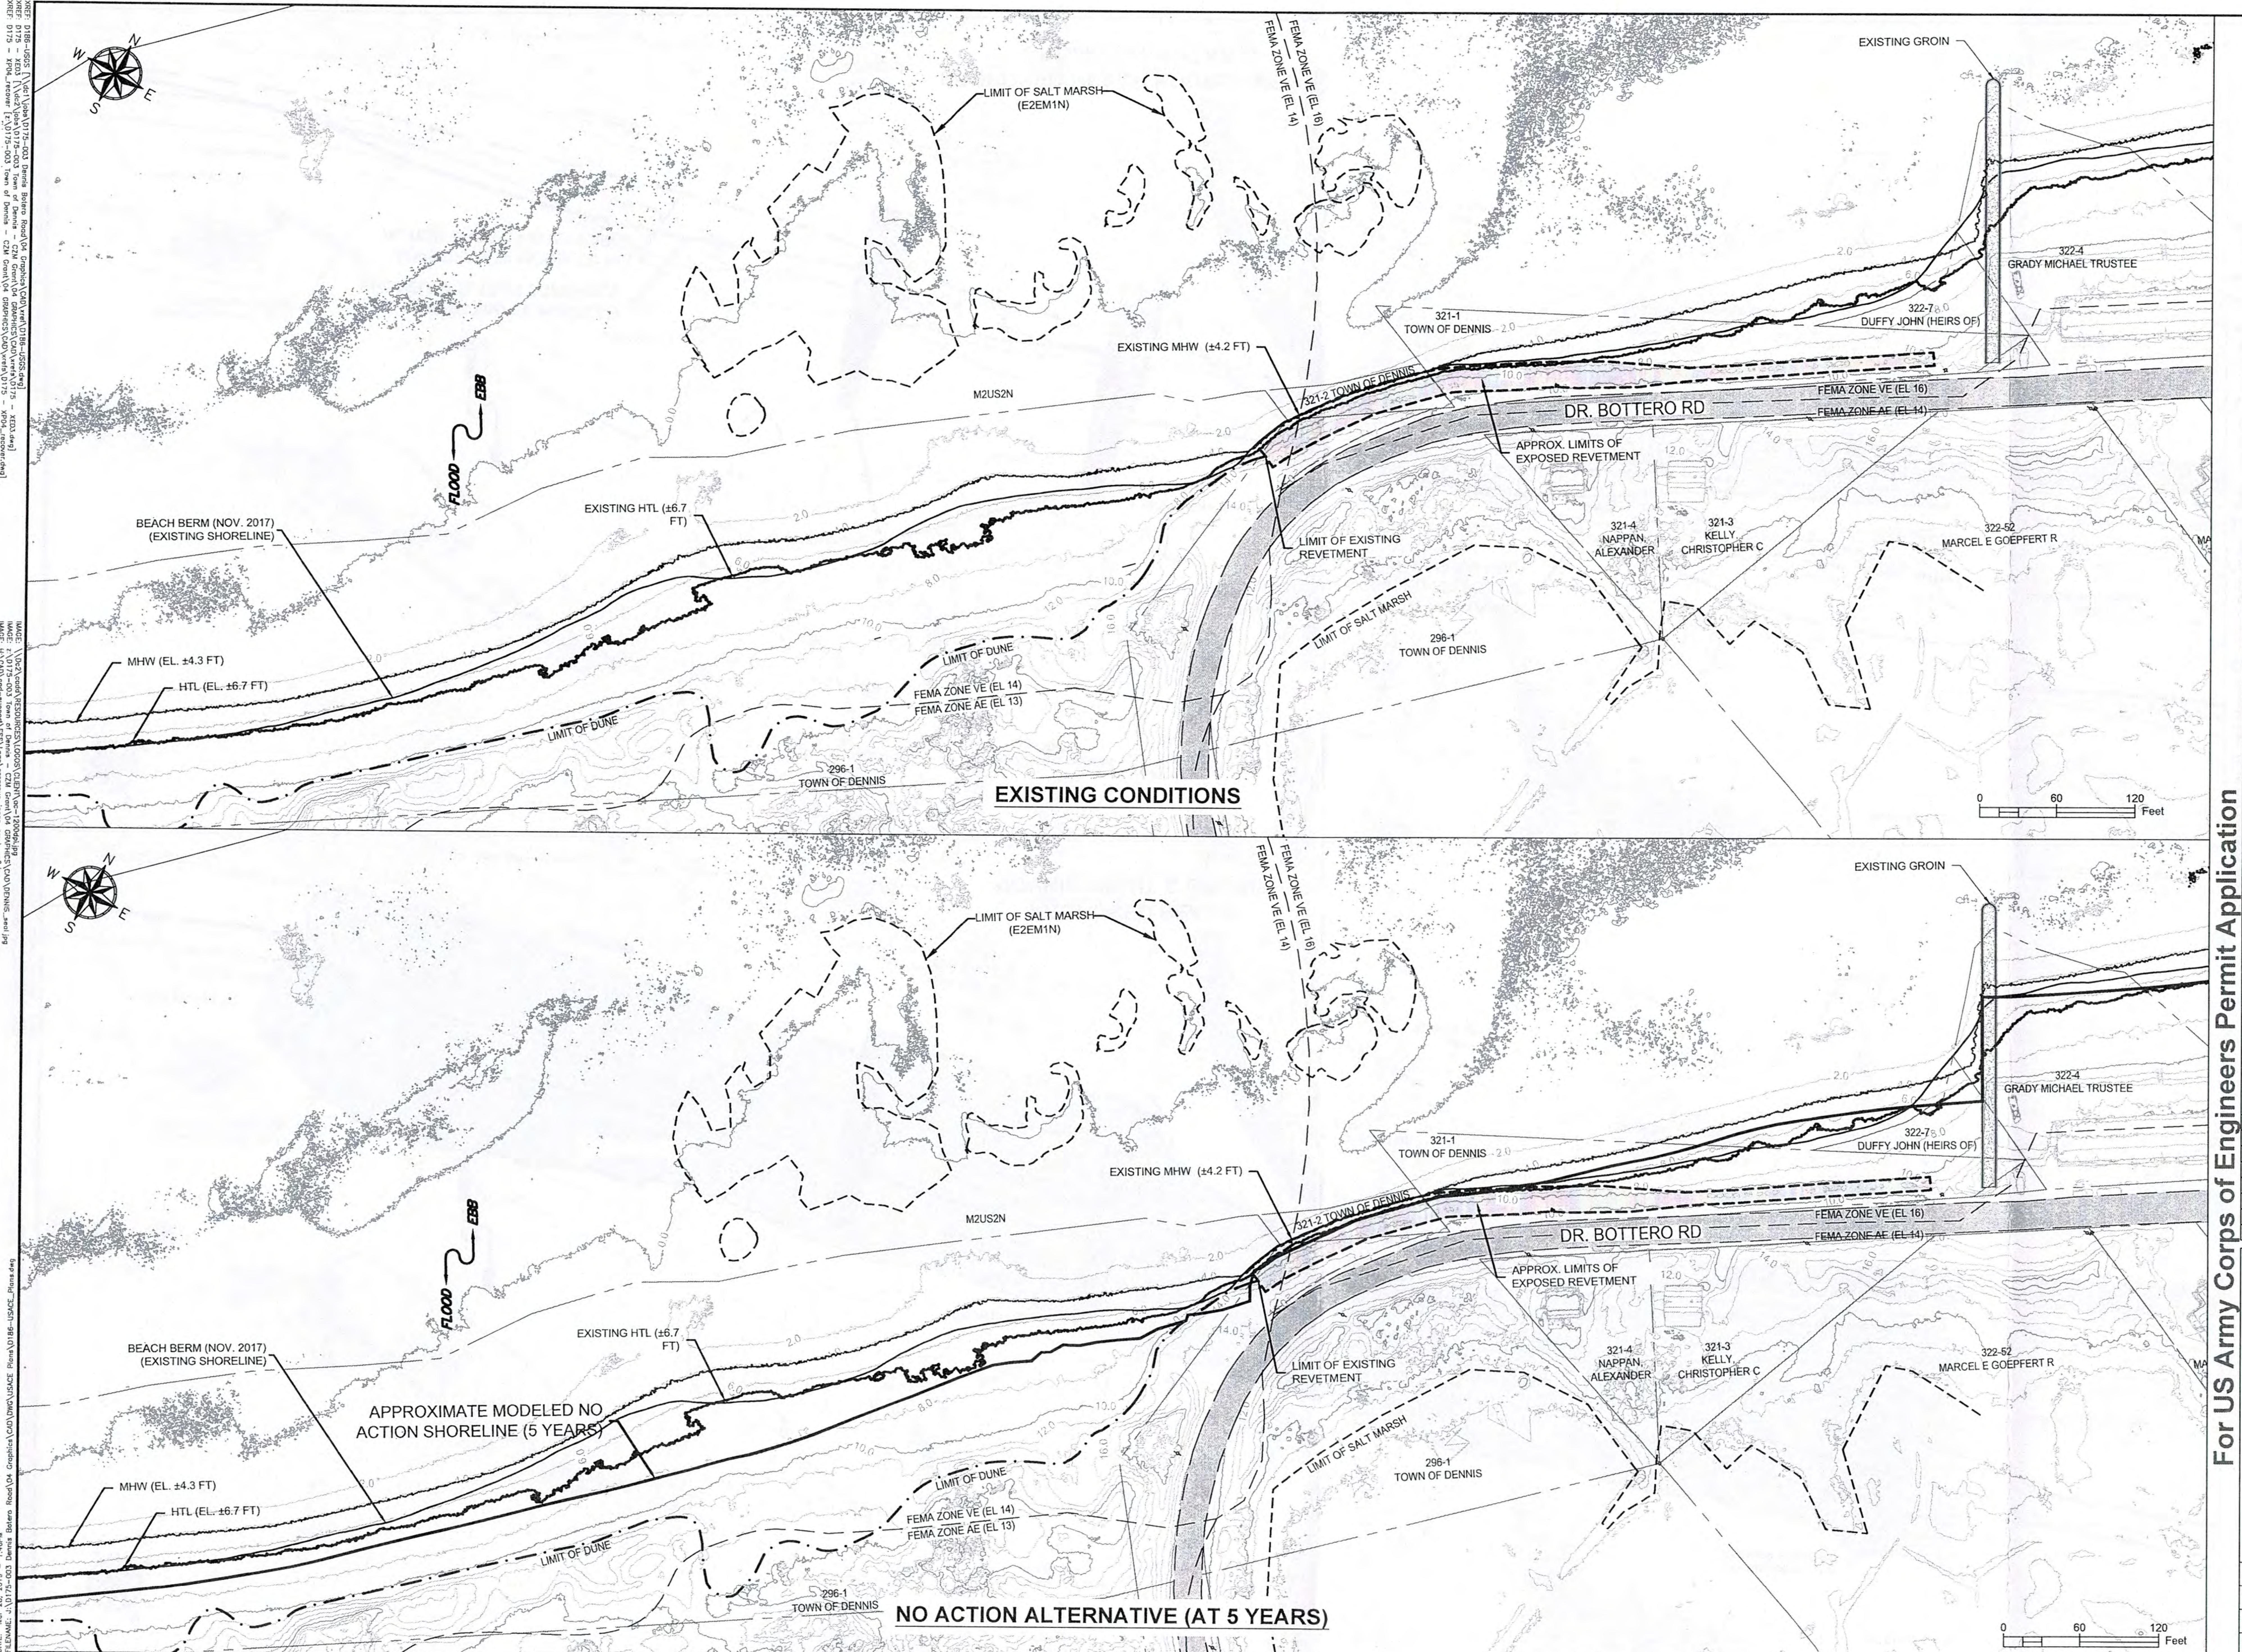

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BY: SJC	APPROVED BY: PRW	

Application by:  
**OWN OF DENNIS**

AT: DENNIS  
N: CAPE COD BAY  
RNSTABLE COUNTY  
EALTH OF MASSACHUSETTS

**ZERO ROAD & CHAPIN BEACH  
NO COASTAL RESILIENCY**

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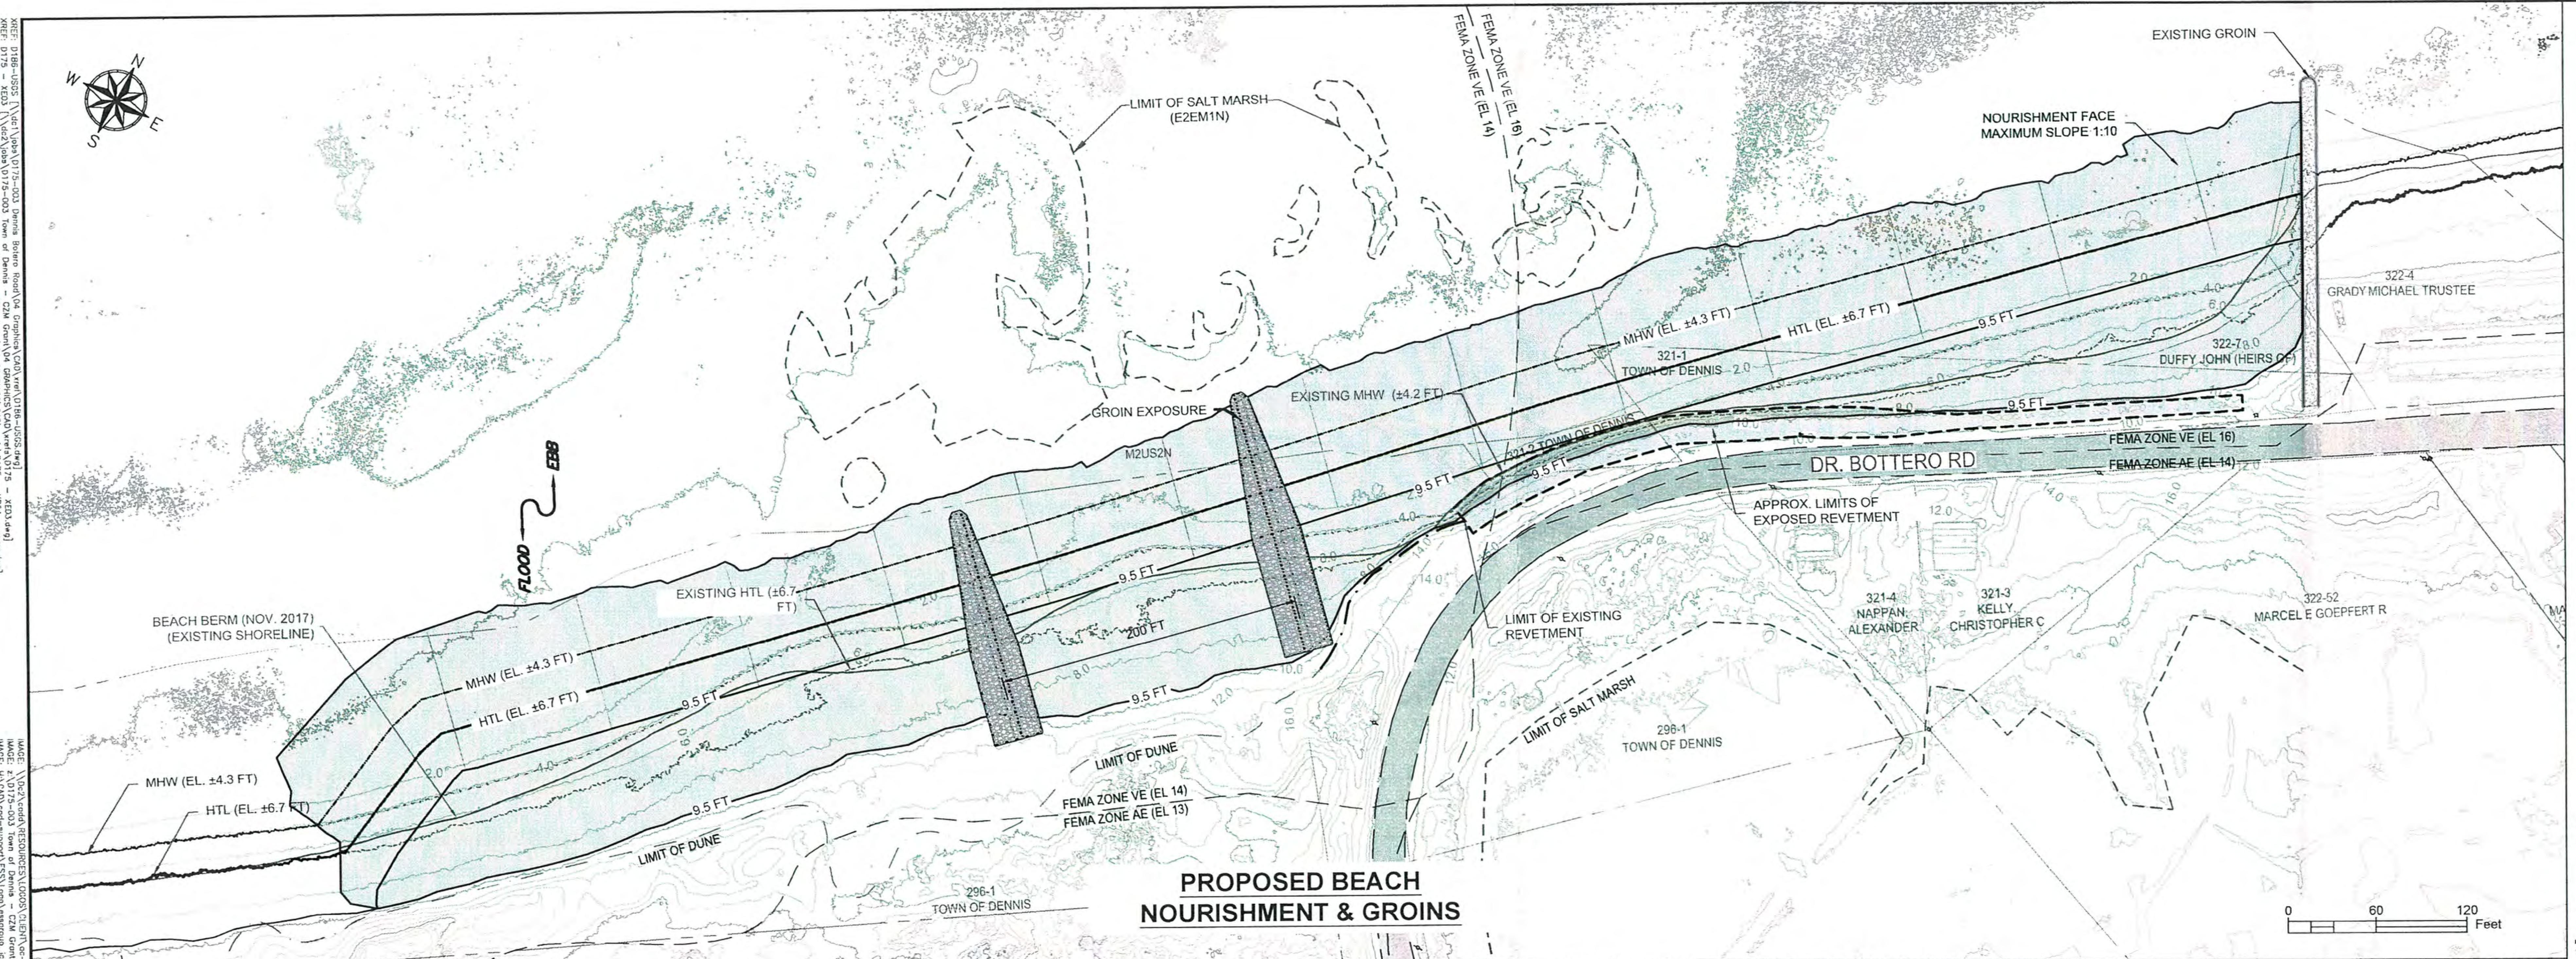
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**OWN OF DENNIS**

AT: DENNIS  
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RNSTABLE COUNTY  
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**ZERO ROAD & CHAPIN BEACH  
NO COASTAL RESILIENCY**

TRANSFORMING LEADERSHIP

PROJECT No.:D186-000.04	SHEET No.
DATE OF ISSUE: MARCH 2019	
SHEET No.: 3 OF 8	
SCALE: AS SHOWN	<b>3 OF 8</b>



#### LEGEND

- Proposed Beach Nourishment
- Groin Exposure Above Beach Nourishment
- Extent of Groin Covered by Beach Nourishment
- Existing Groin



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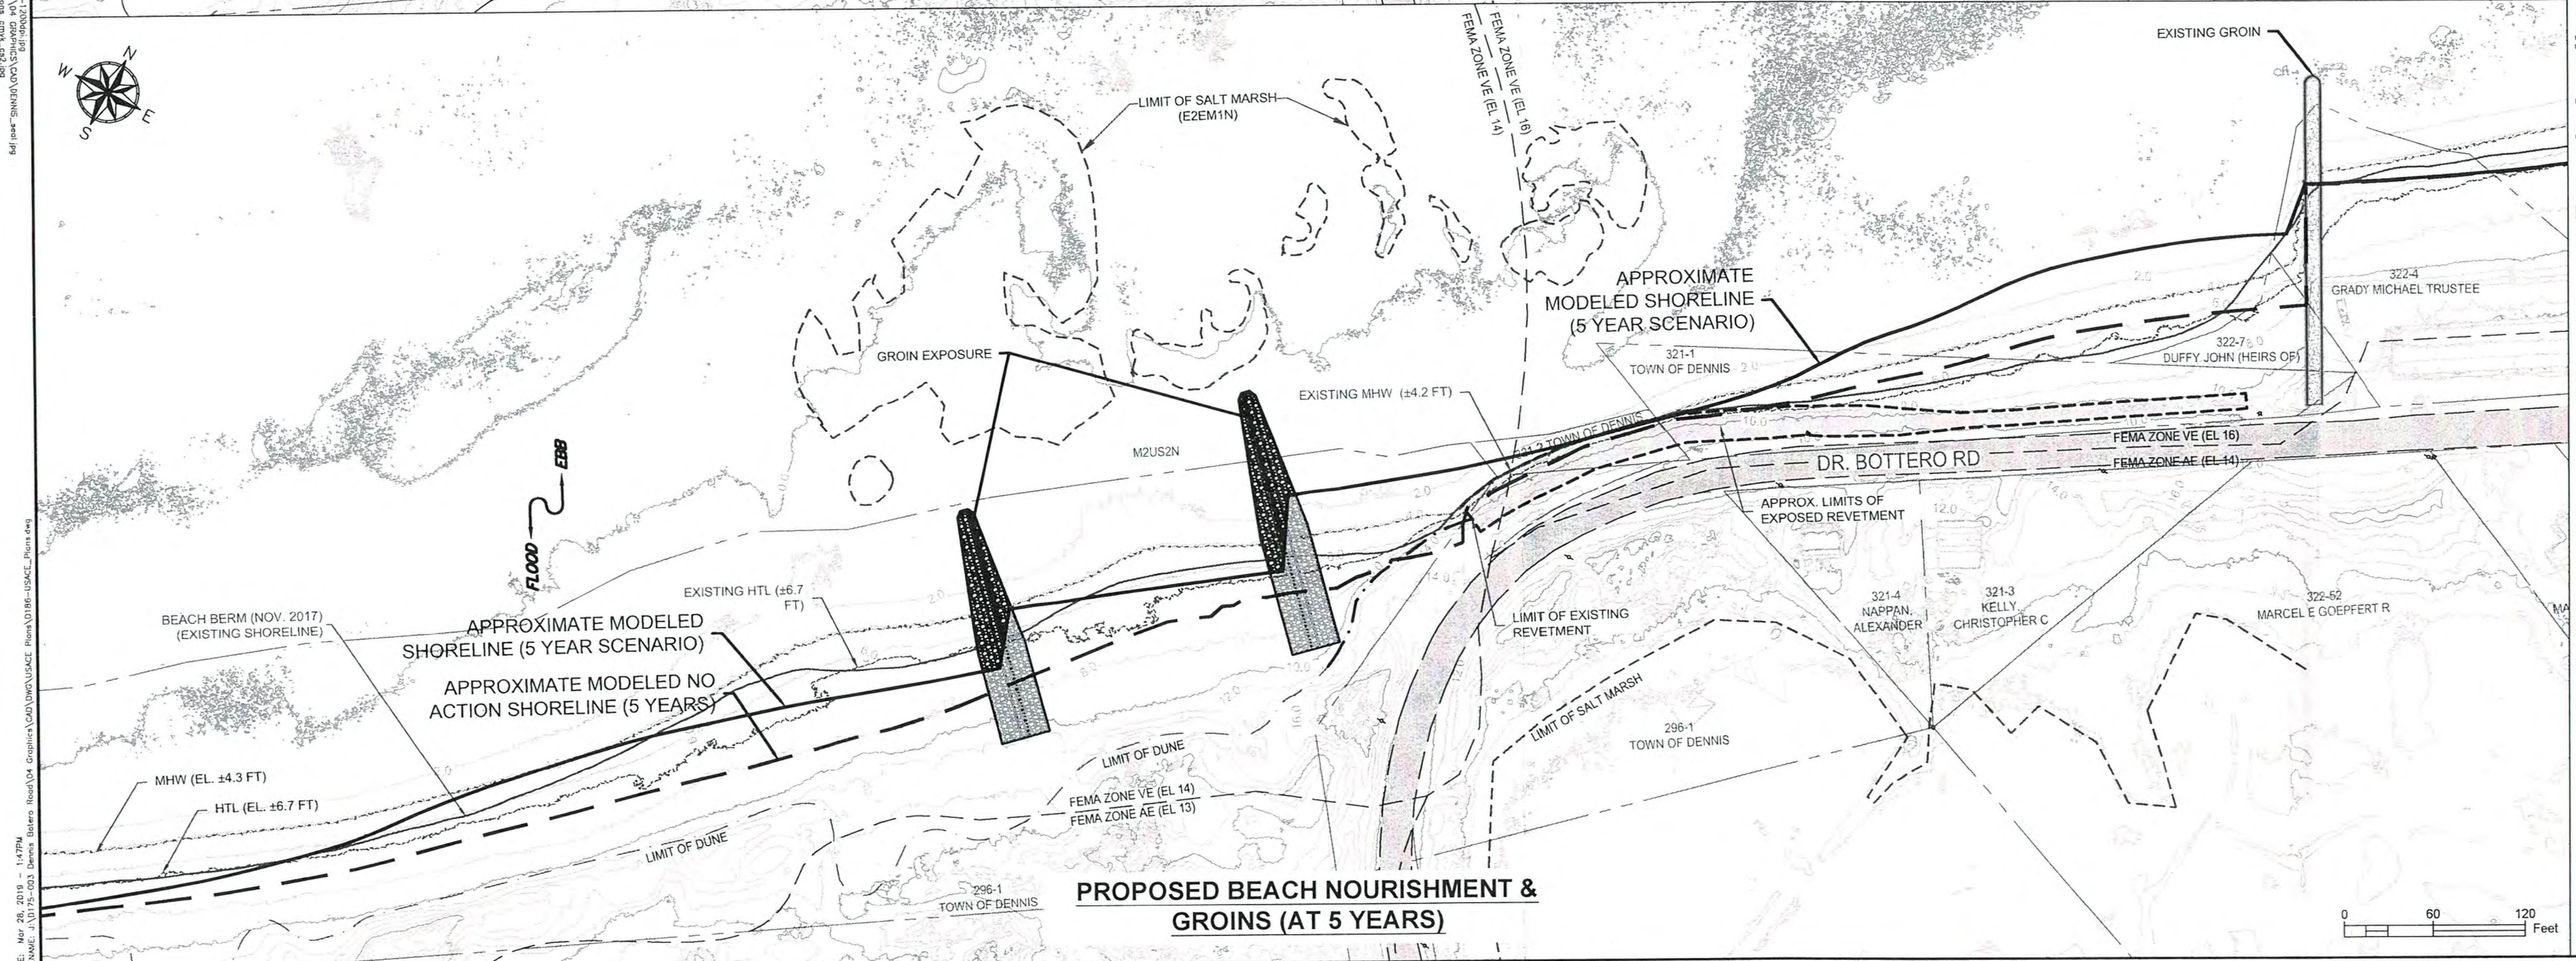



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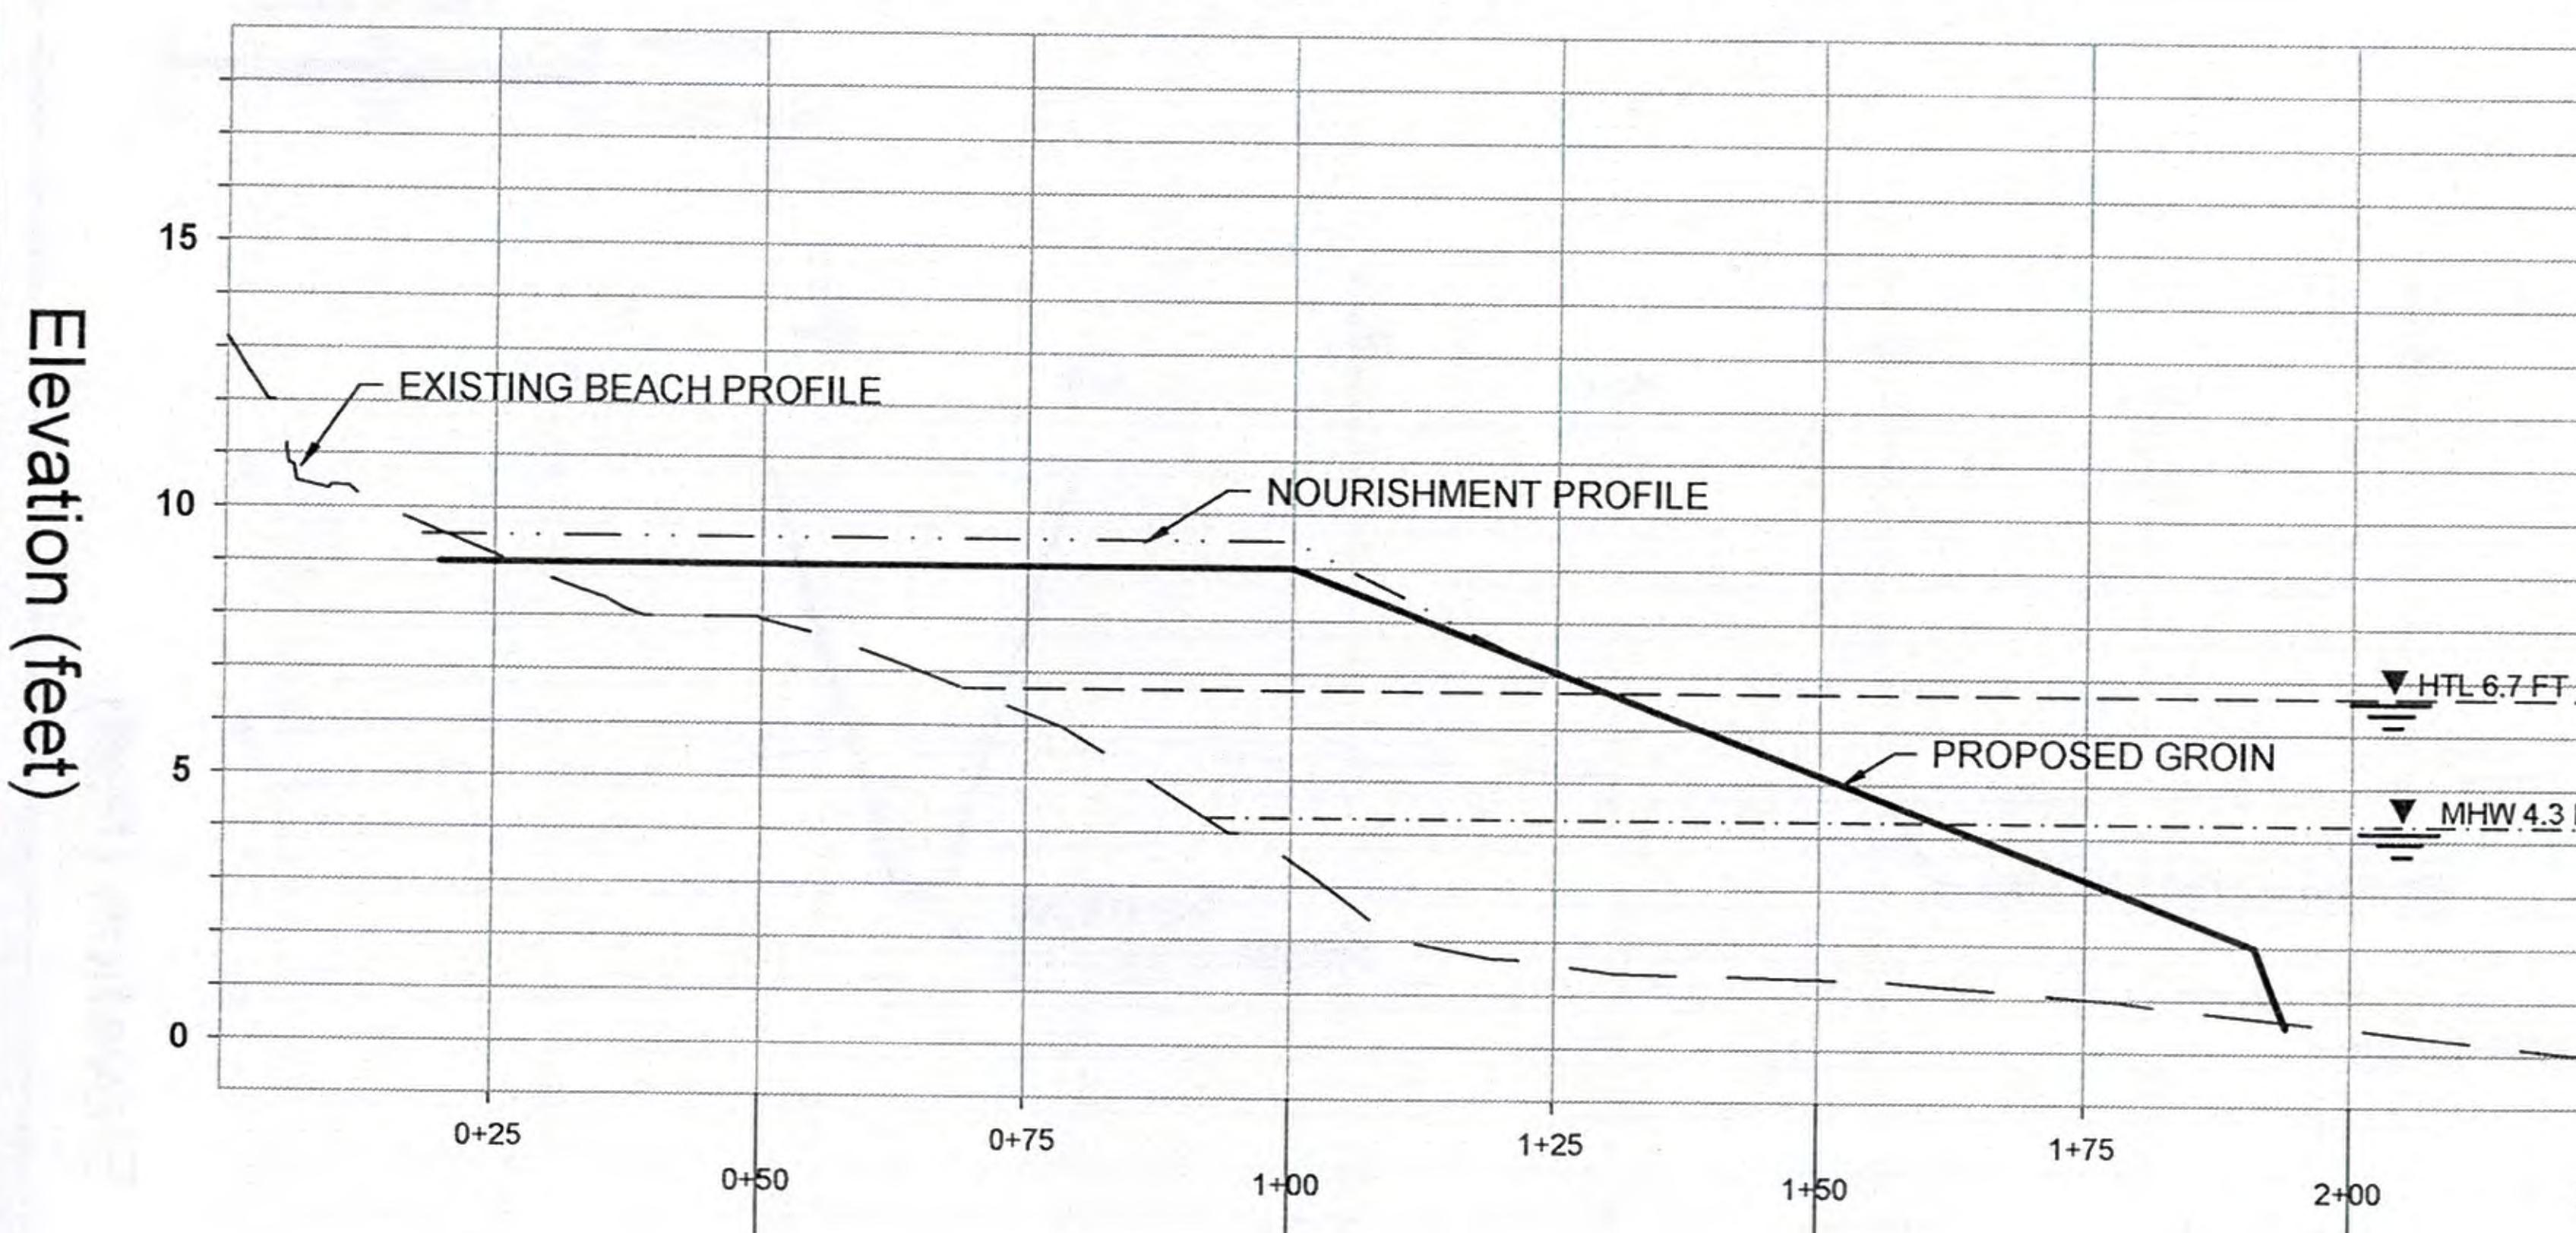
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Application by: <b>TOWN OF DENNIS</b>			
AT: DENNIS IN: CAPE COD BAY BARNSTABLE COUNTY COMMONWEALTH OF MASSACHUSETTS			
DR. BOTTERO ROAD & CHAPIN BEACH IMPROVING COASTAL RESILIENCY			
<b>PROPOSED CONDITIONS</b>			
PROJECT No.: D186-000.04		SHEET No.	
DATE OF ISSUE: MARCH 2019			
SHEET No.: 4 of 8			
SCALE: AS SHOWN			

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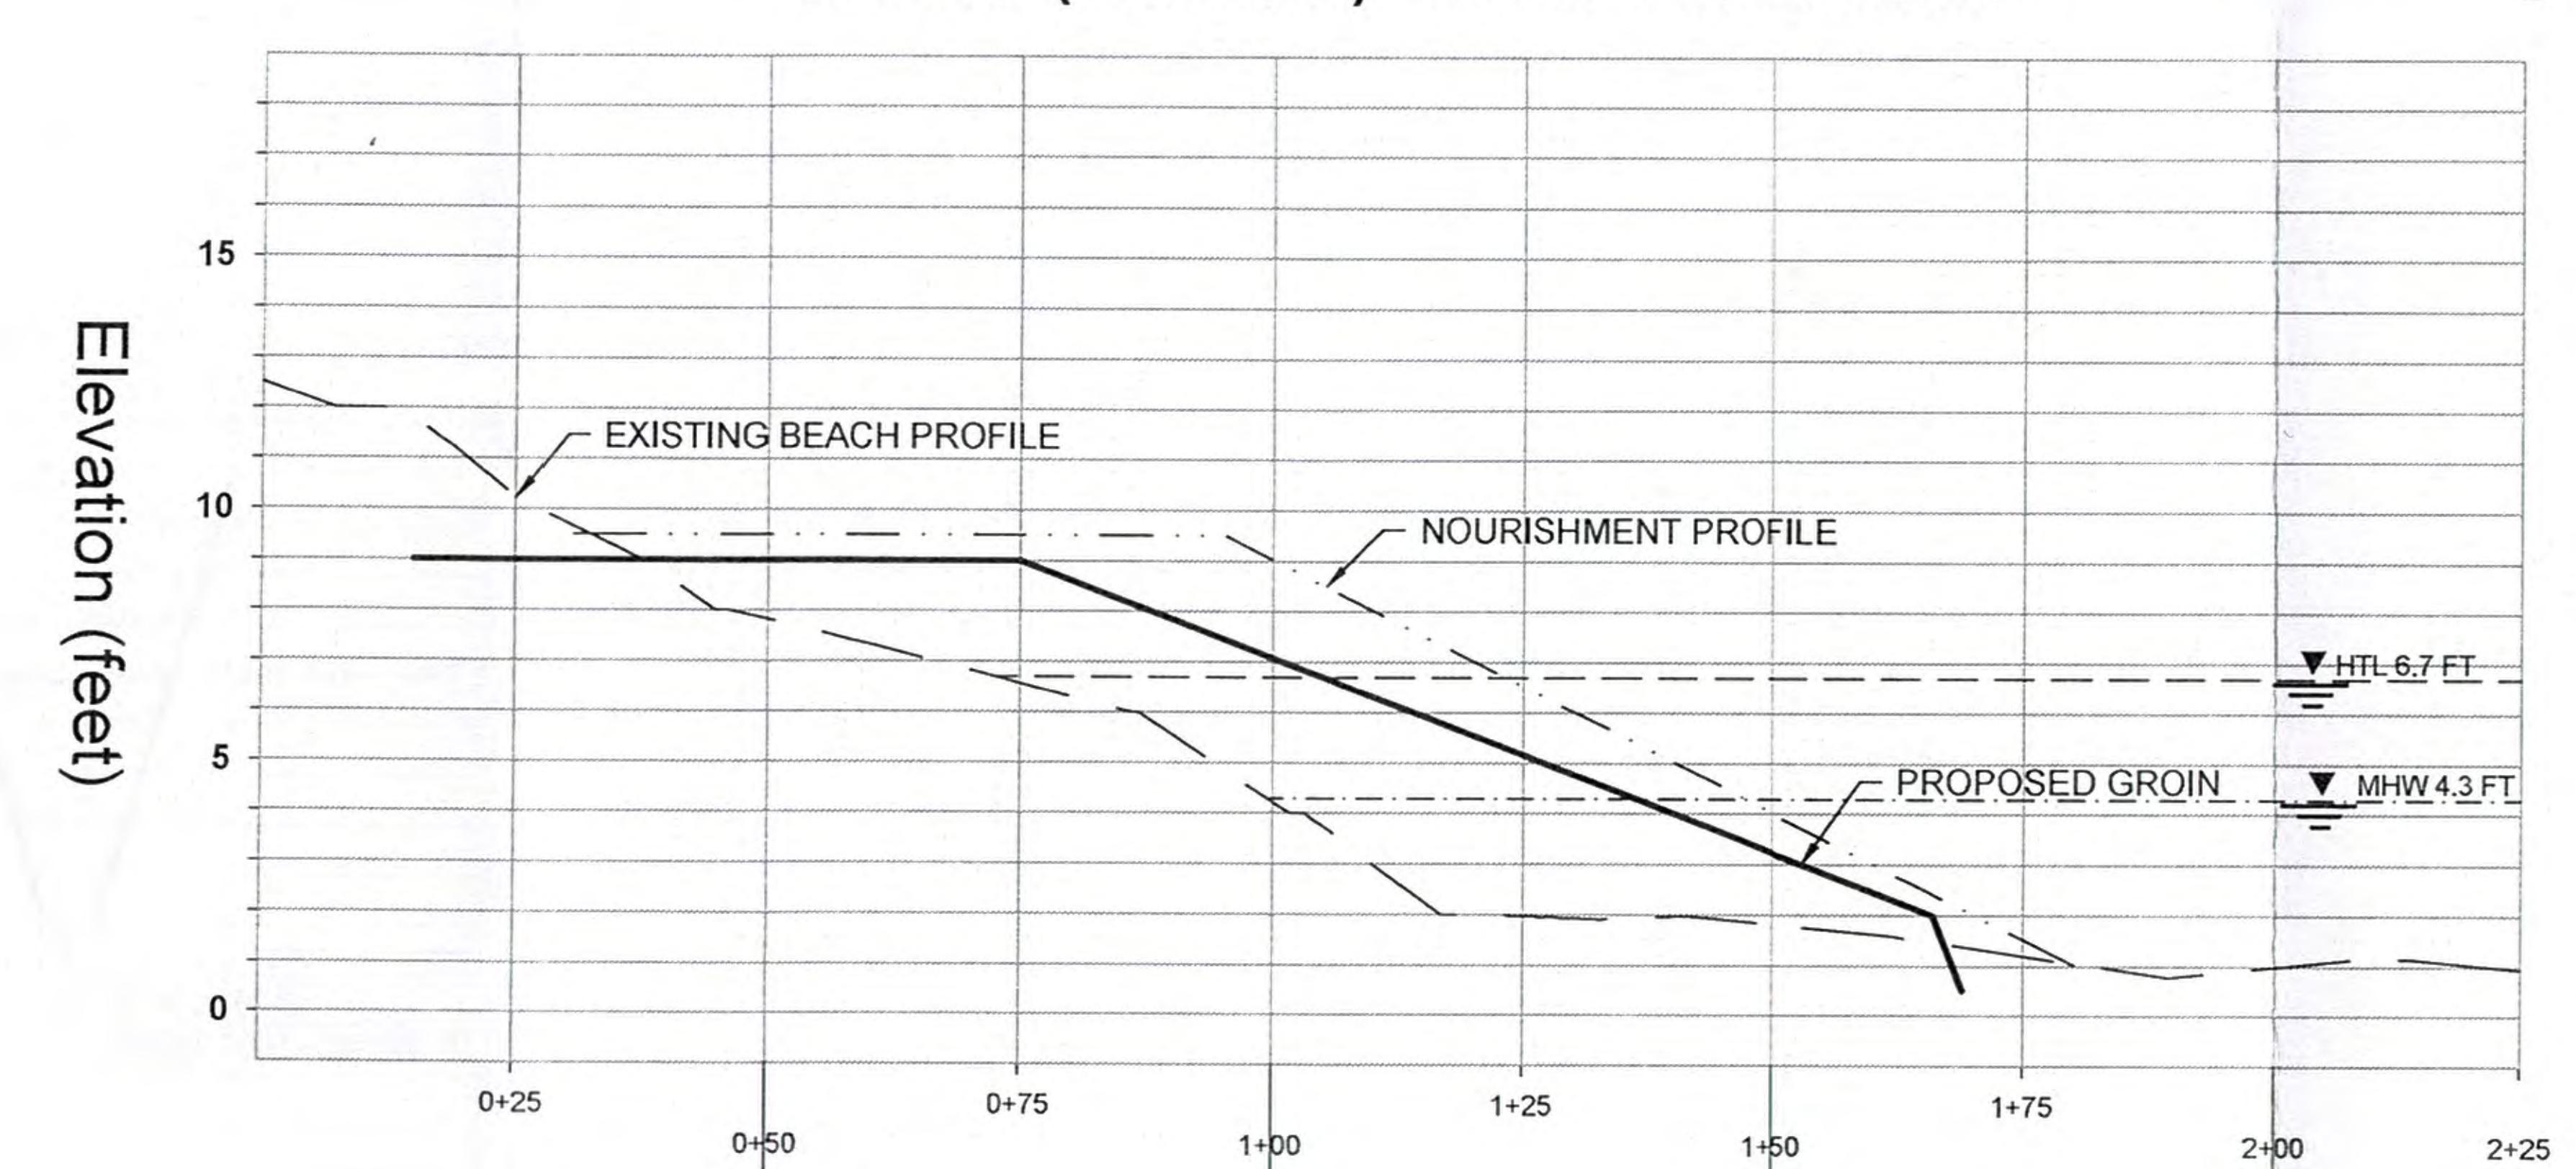





A Groin 1 (Eastern) Center Line Profile

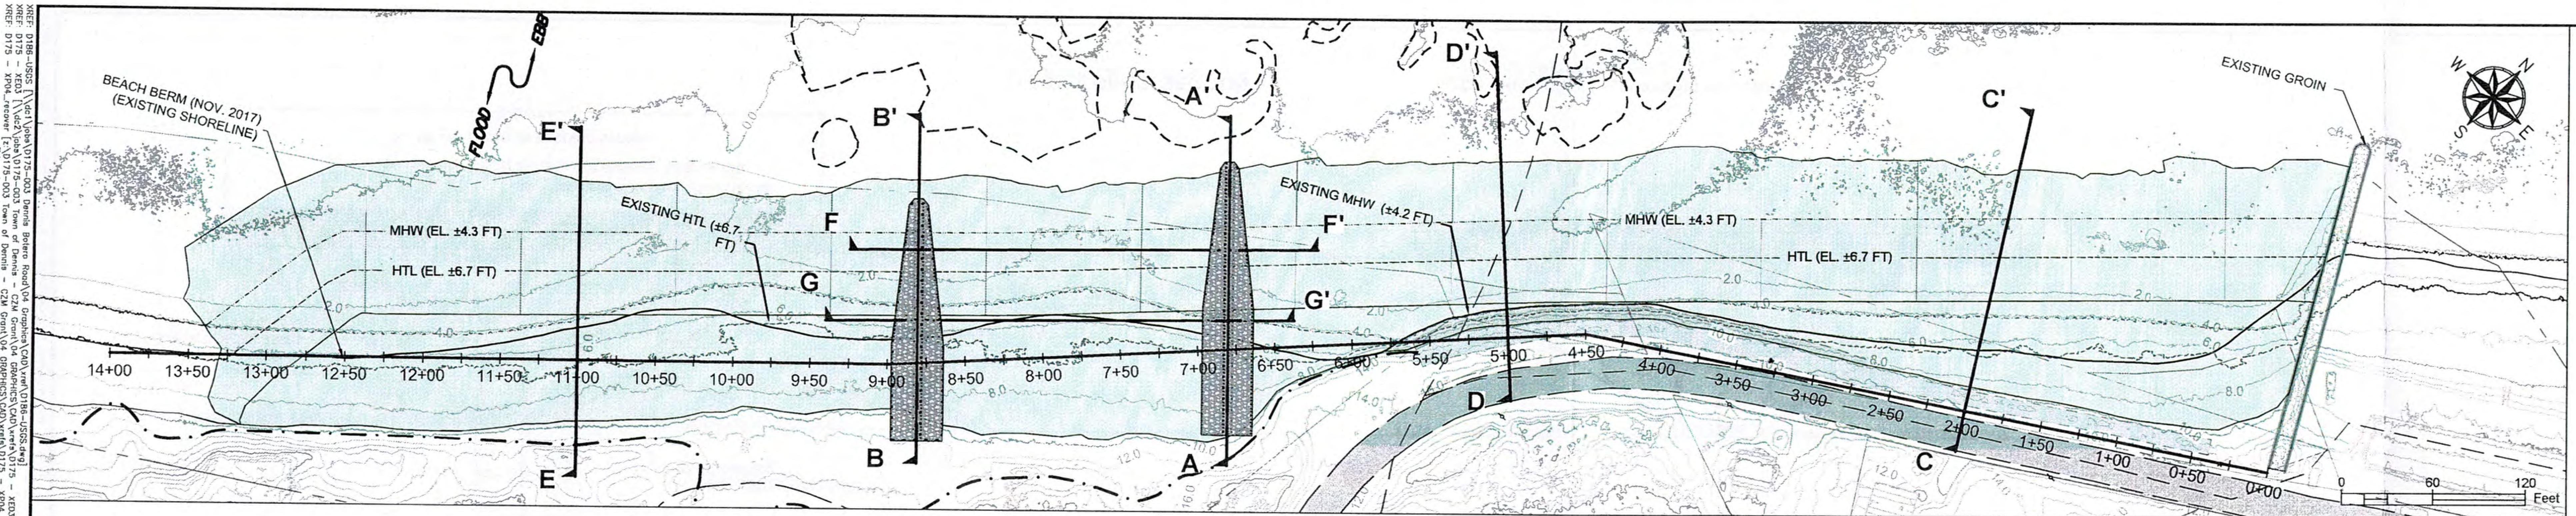


B Groin 2 (Western) Center Line Profile



C Transect 1 (East)

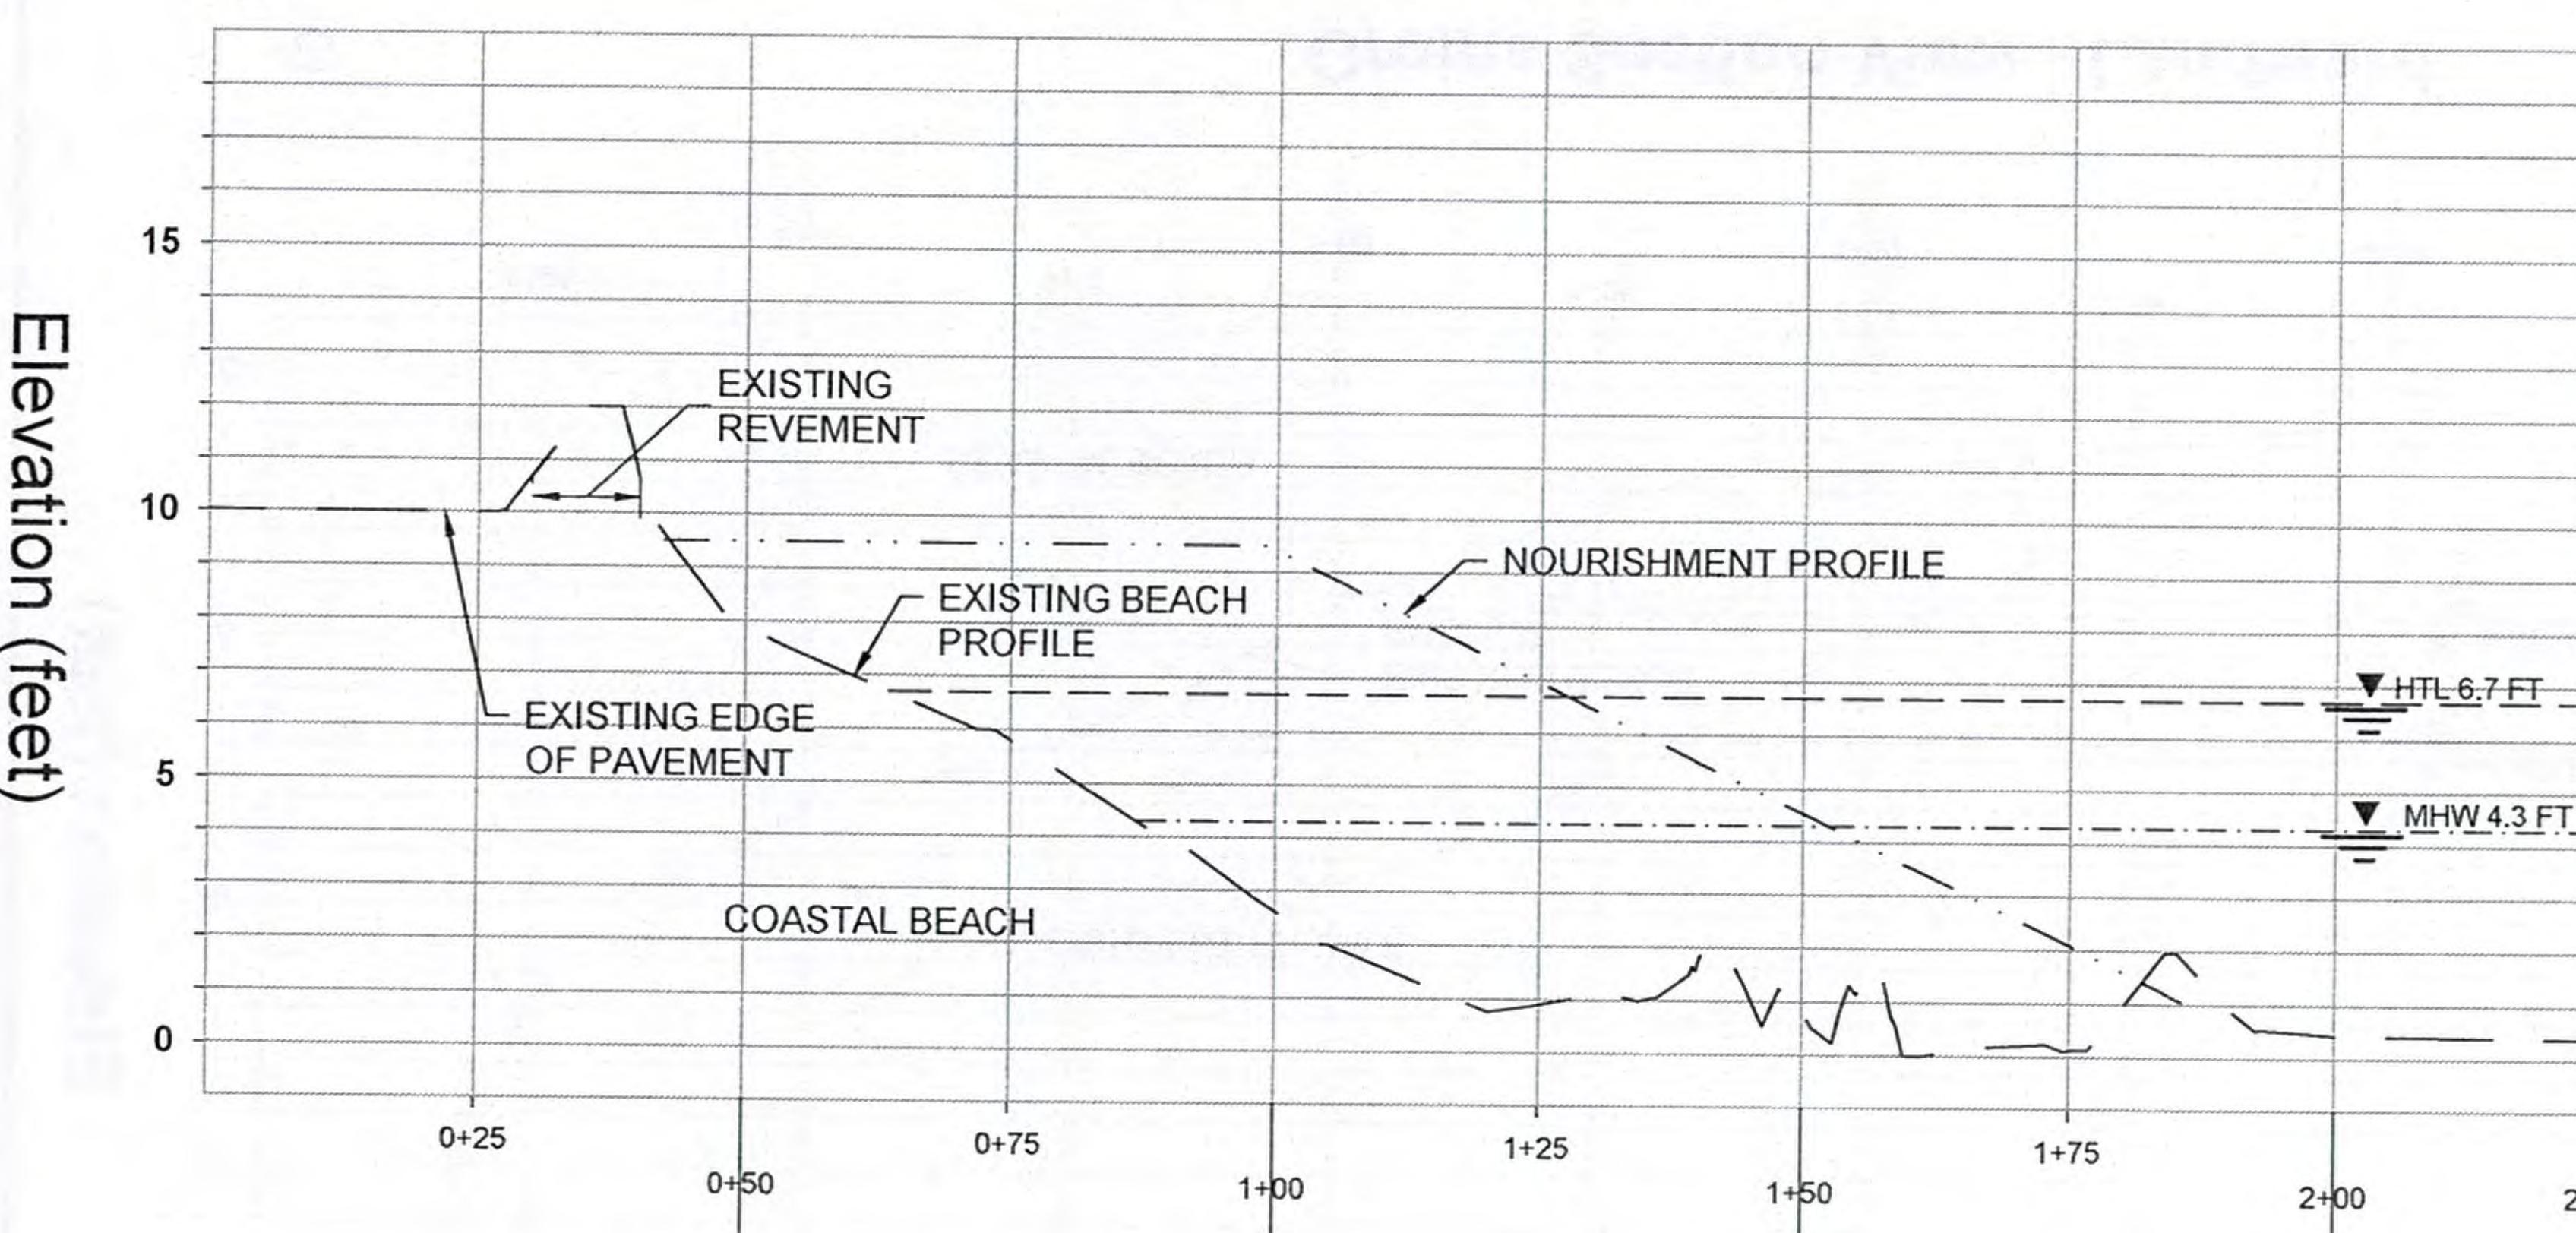

D Transect 2 (Middle)

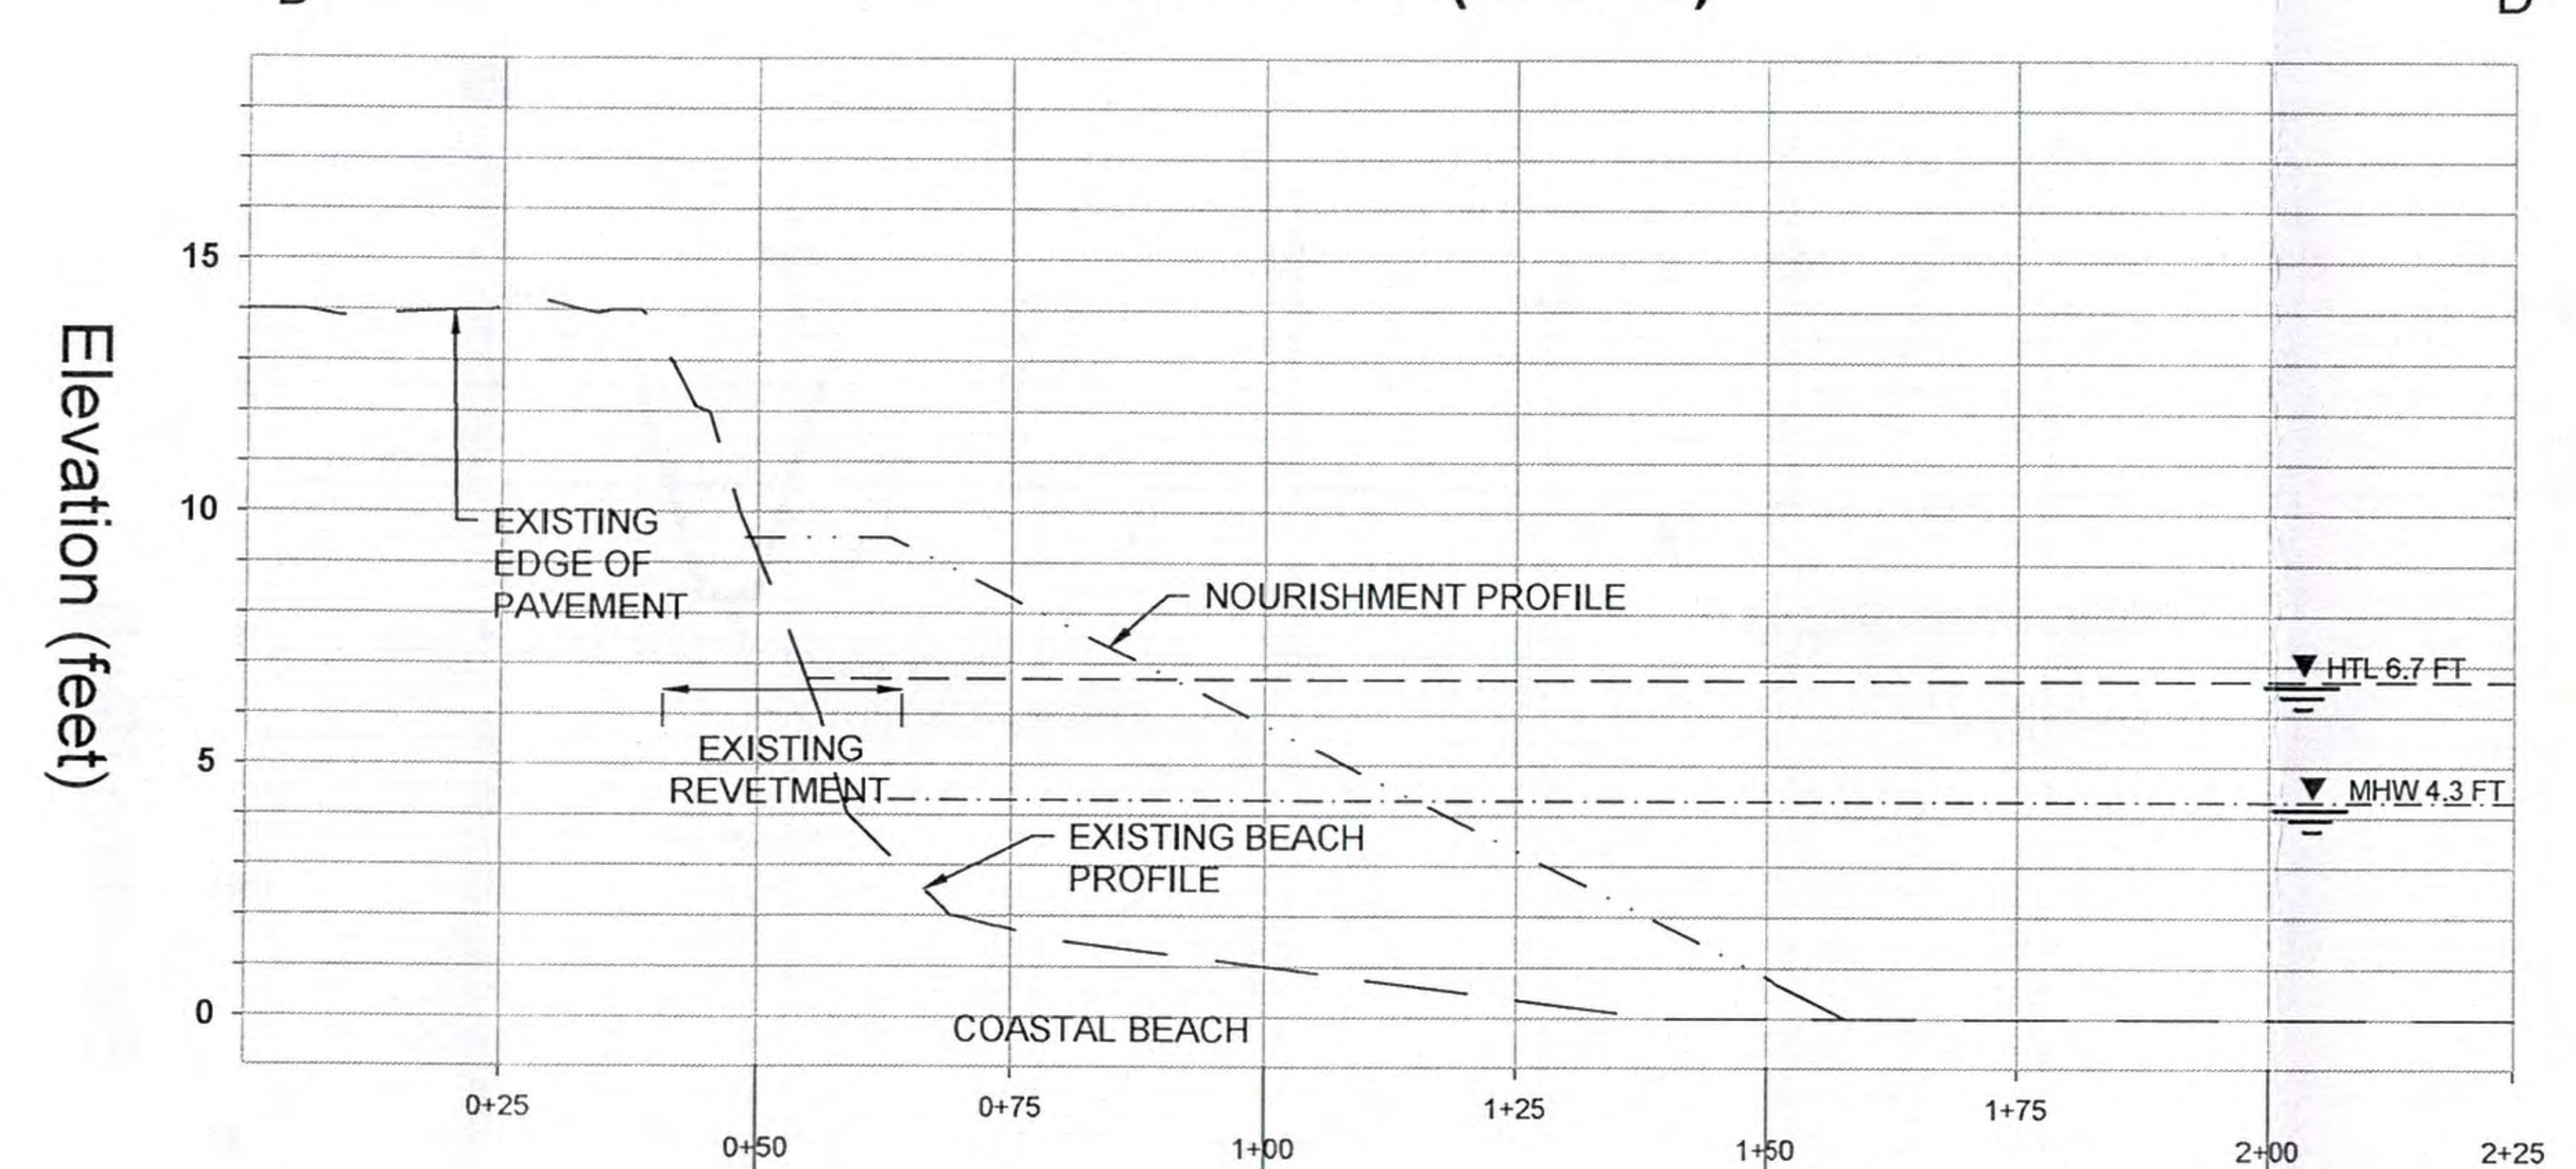

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Application by:  
TOWN OF DENNIS

AT: DENNIS  
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BARNSTABLE COUNTY  
COMMONWEALTH OF MASSACHUSETTS

DR. BOTTERO ROAD & CHAPIN BEACH  
IMPROVING COASTAL RESILIENCY

PROFILES & SECTIONS

PROJECT No.: D186-000.04	SHEET No.
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SHEET No.: 5 OF 8	
SCALE: AS SHOWN	

5 OF 8

XREF: D1B6-0004.DWG \\\\act\\V001\\D1B6-0004.DWG -> COO\_Dennis\_Route\\C2M\_Groin\\Groins\\Groin2\\Groin2.dwg - XREF.dwg

XREF: D1B6-0004.DWG \\\\act\\V001\\D1B6-0004.DWG -> COO\_Dennis\_Route\\C2M\_Groin\\Groins\\Groin1\\Groin1.dwg - XREF.dwg

XREF: D1B6-0004.DWG \\\\act\\V001\\D1B6-0004.DWG -> COO\_Dennis\_Route\\C2M\_Groin\\Groins\\Groin1\\Groin1.dwg - XREF.dwg


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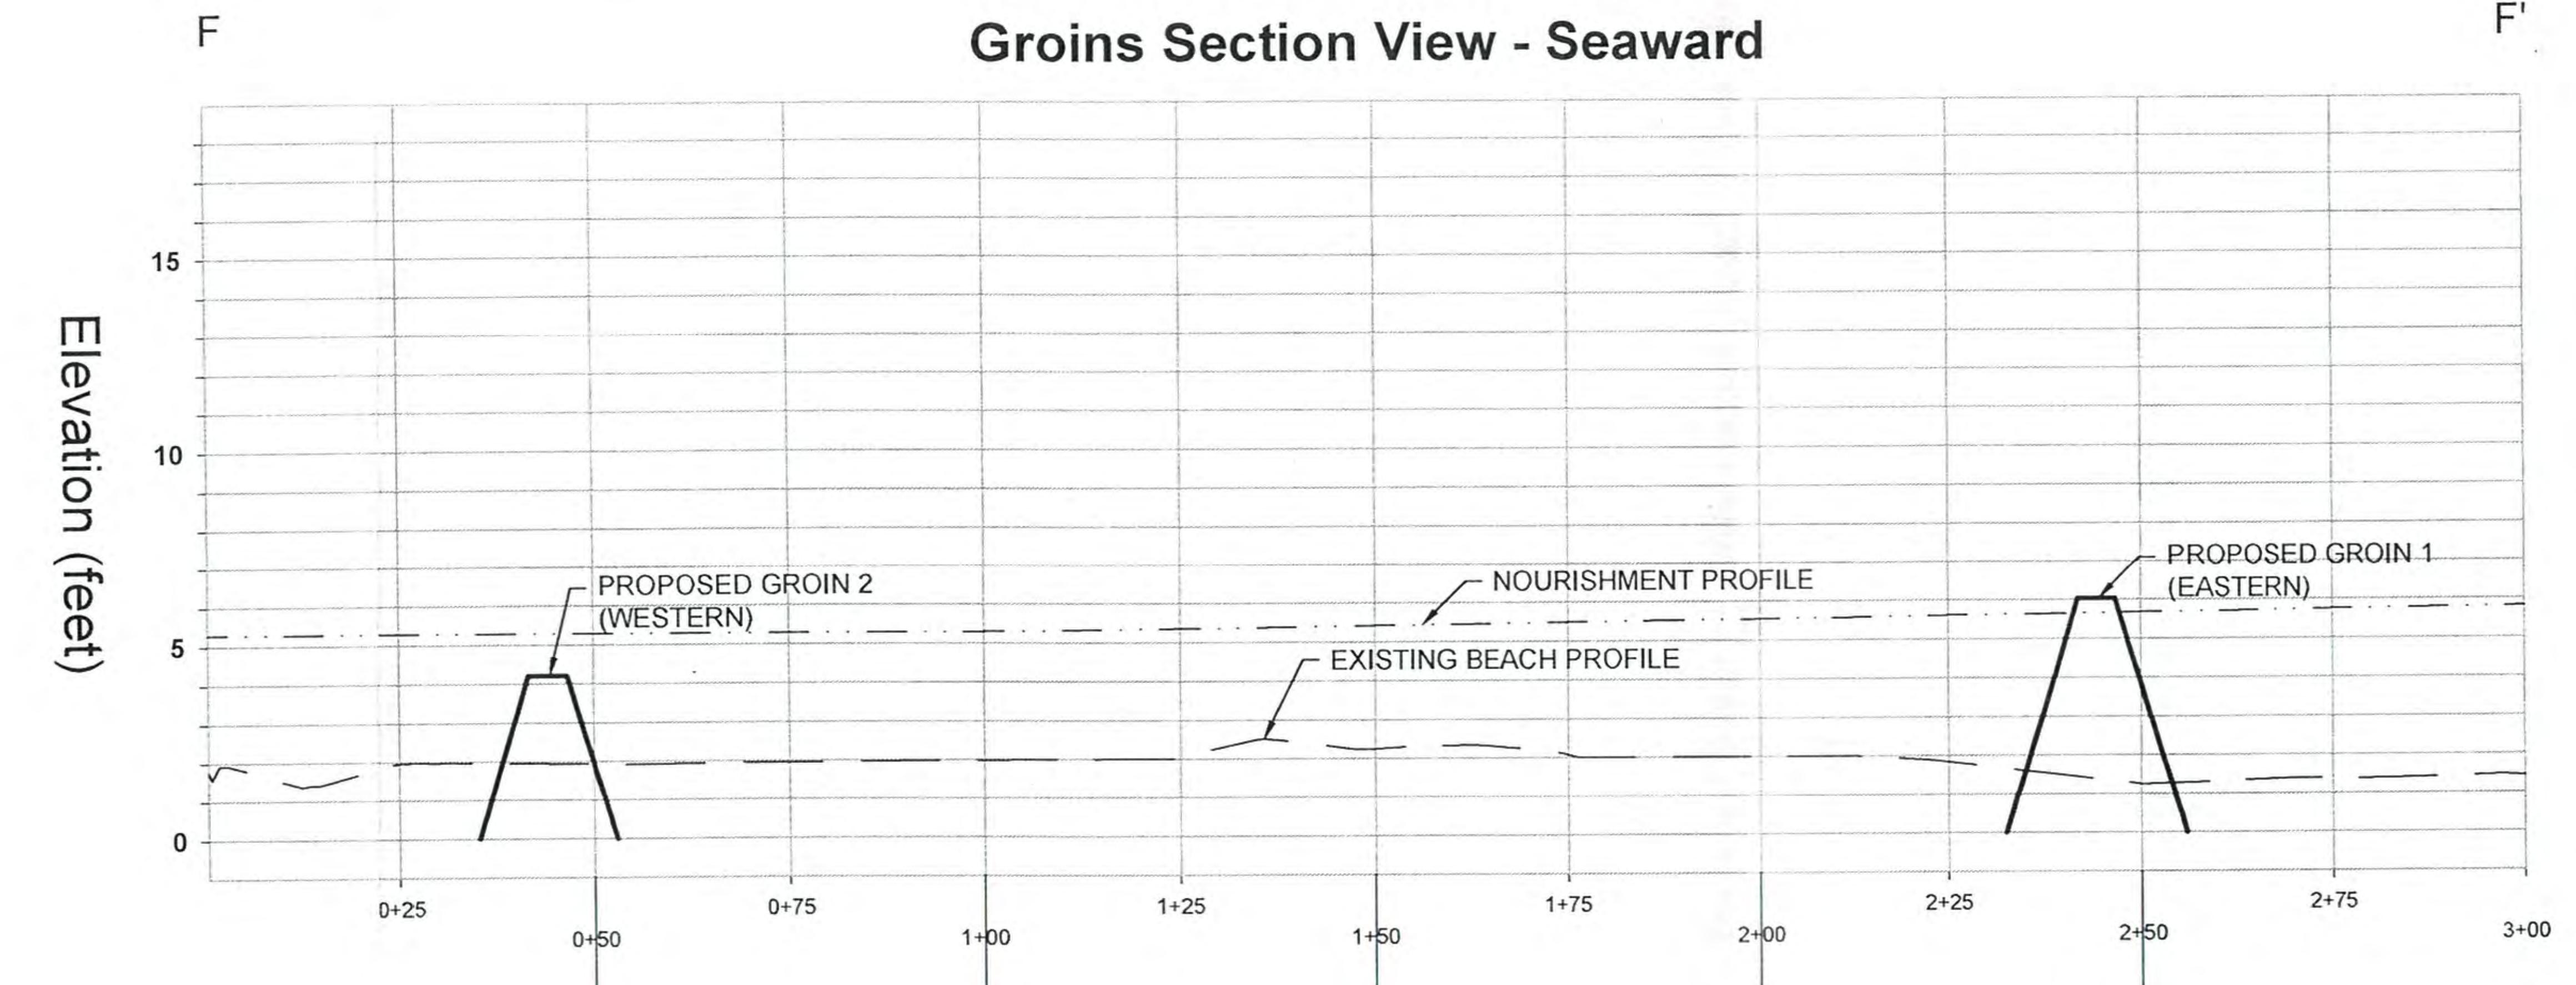
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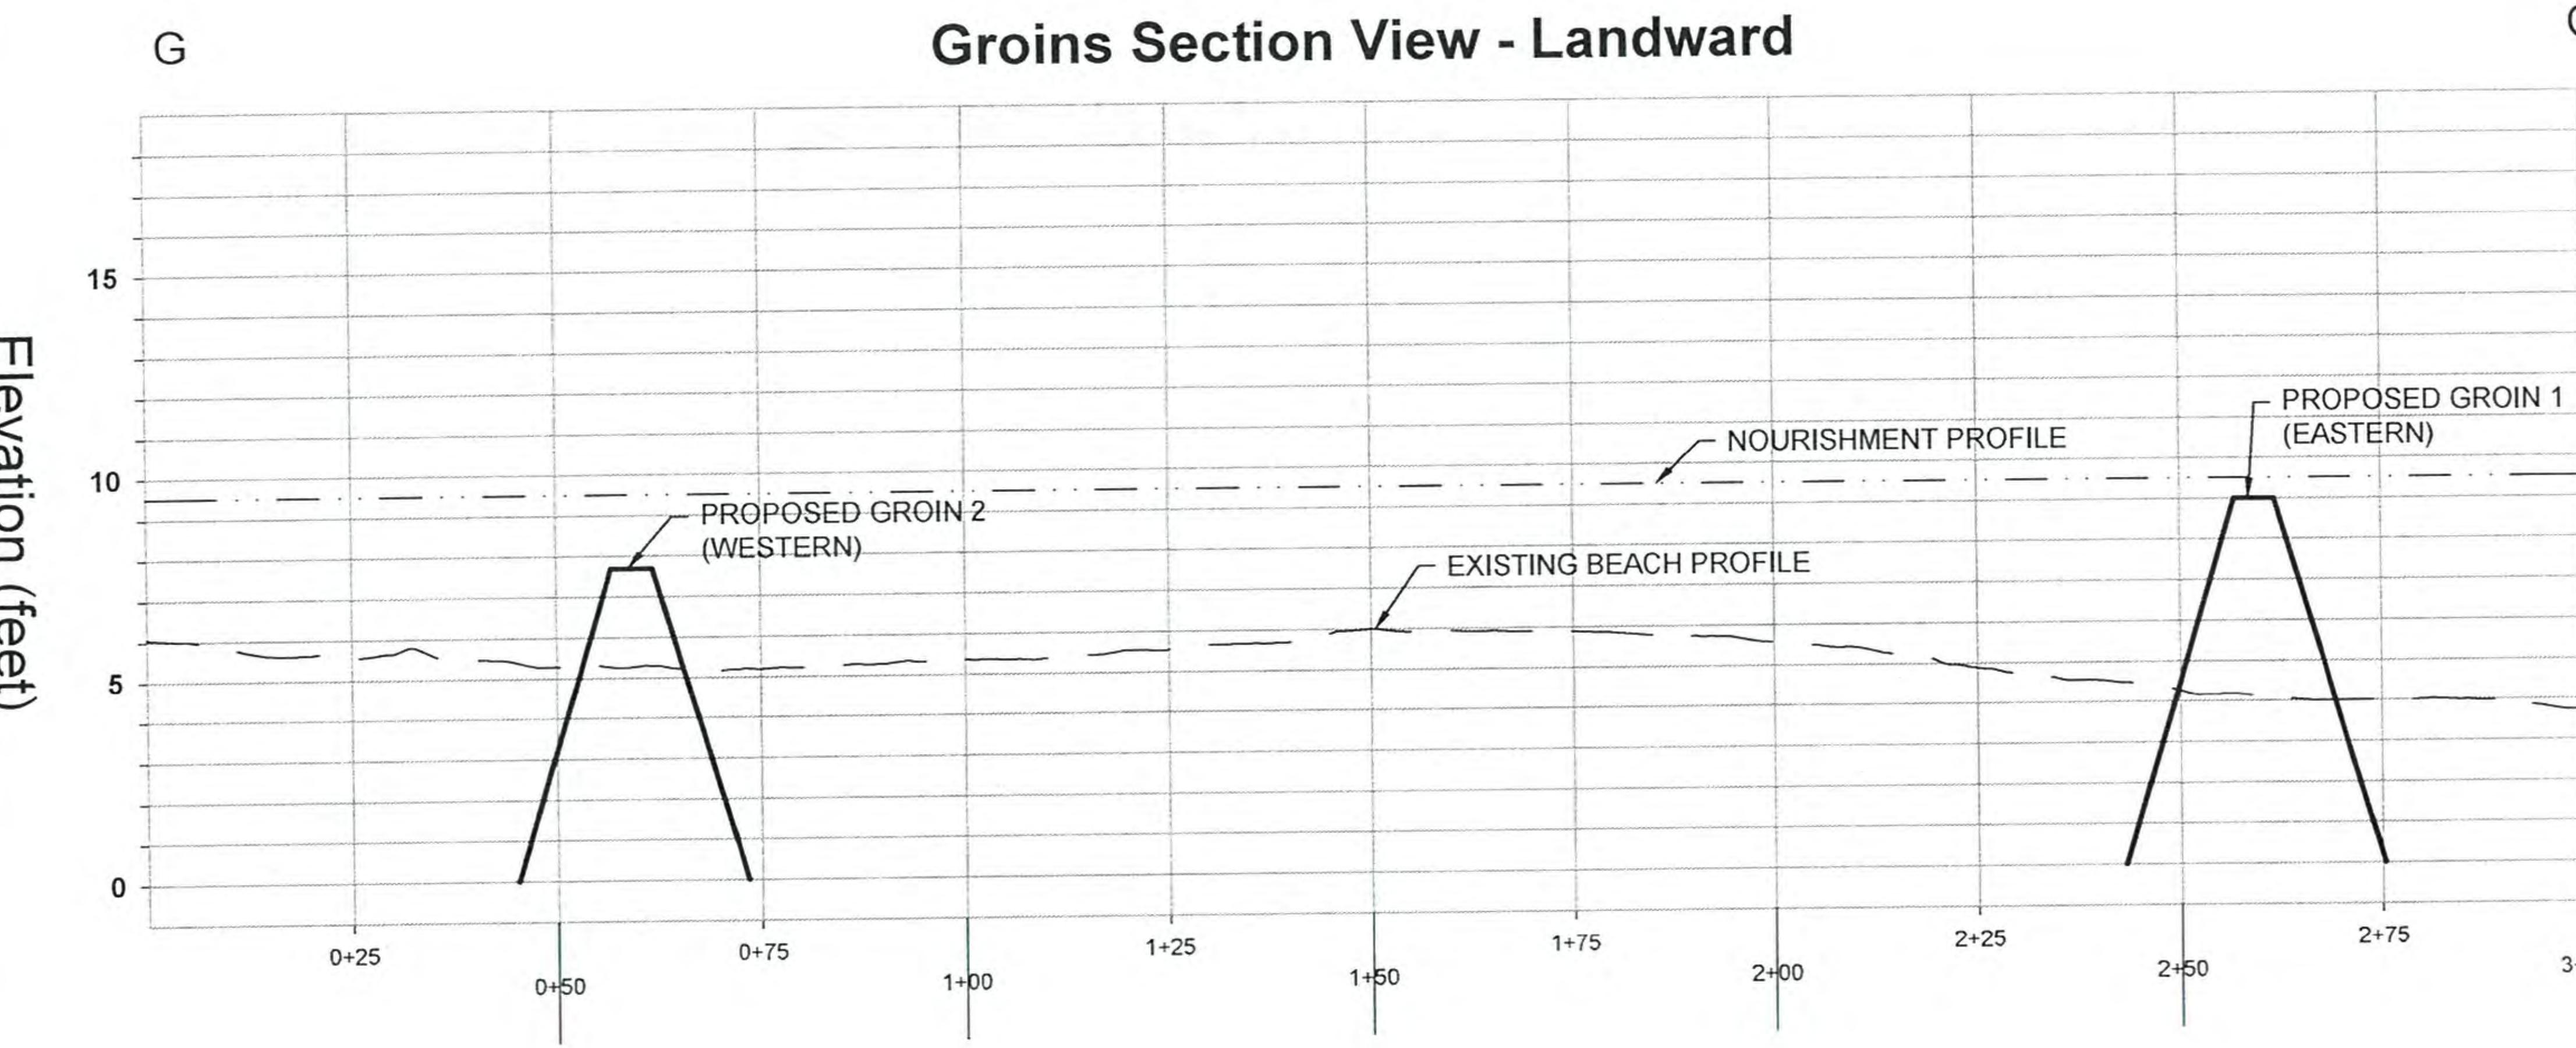
### Transect 3 (West)




### Groins Section View - Seaward



### Groins Section View - Landward

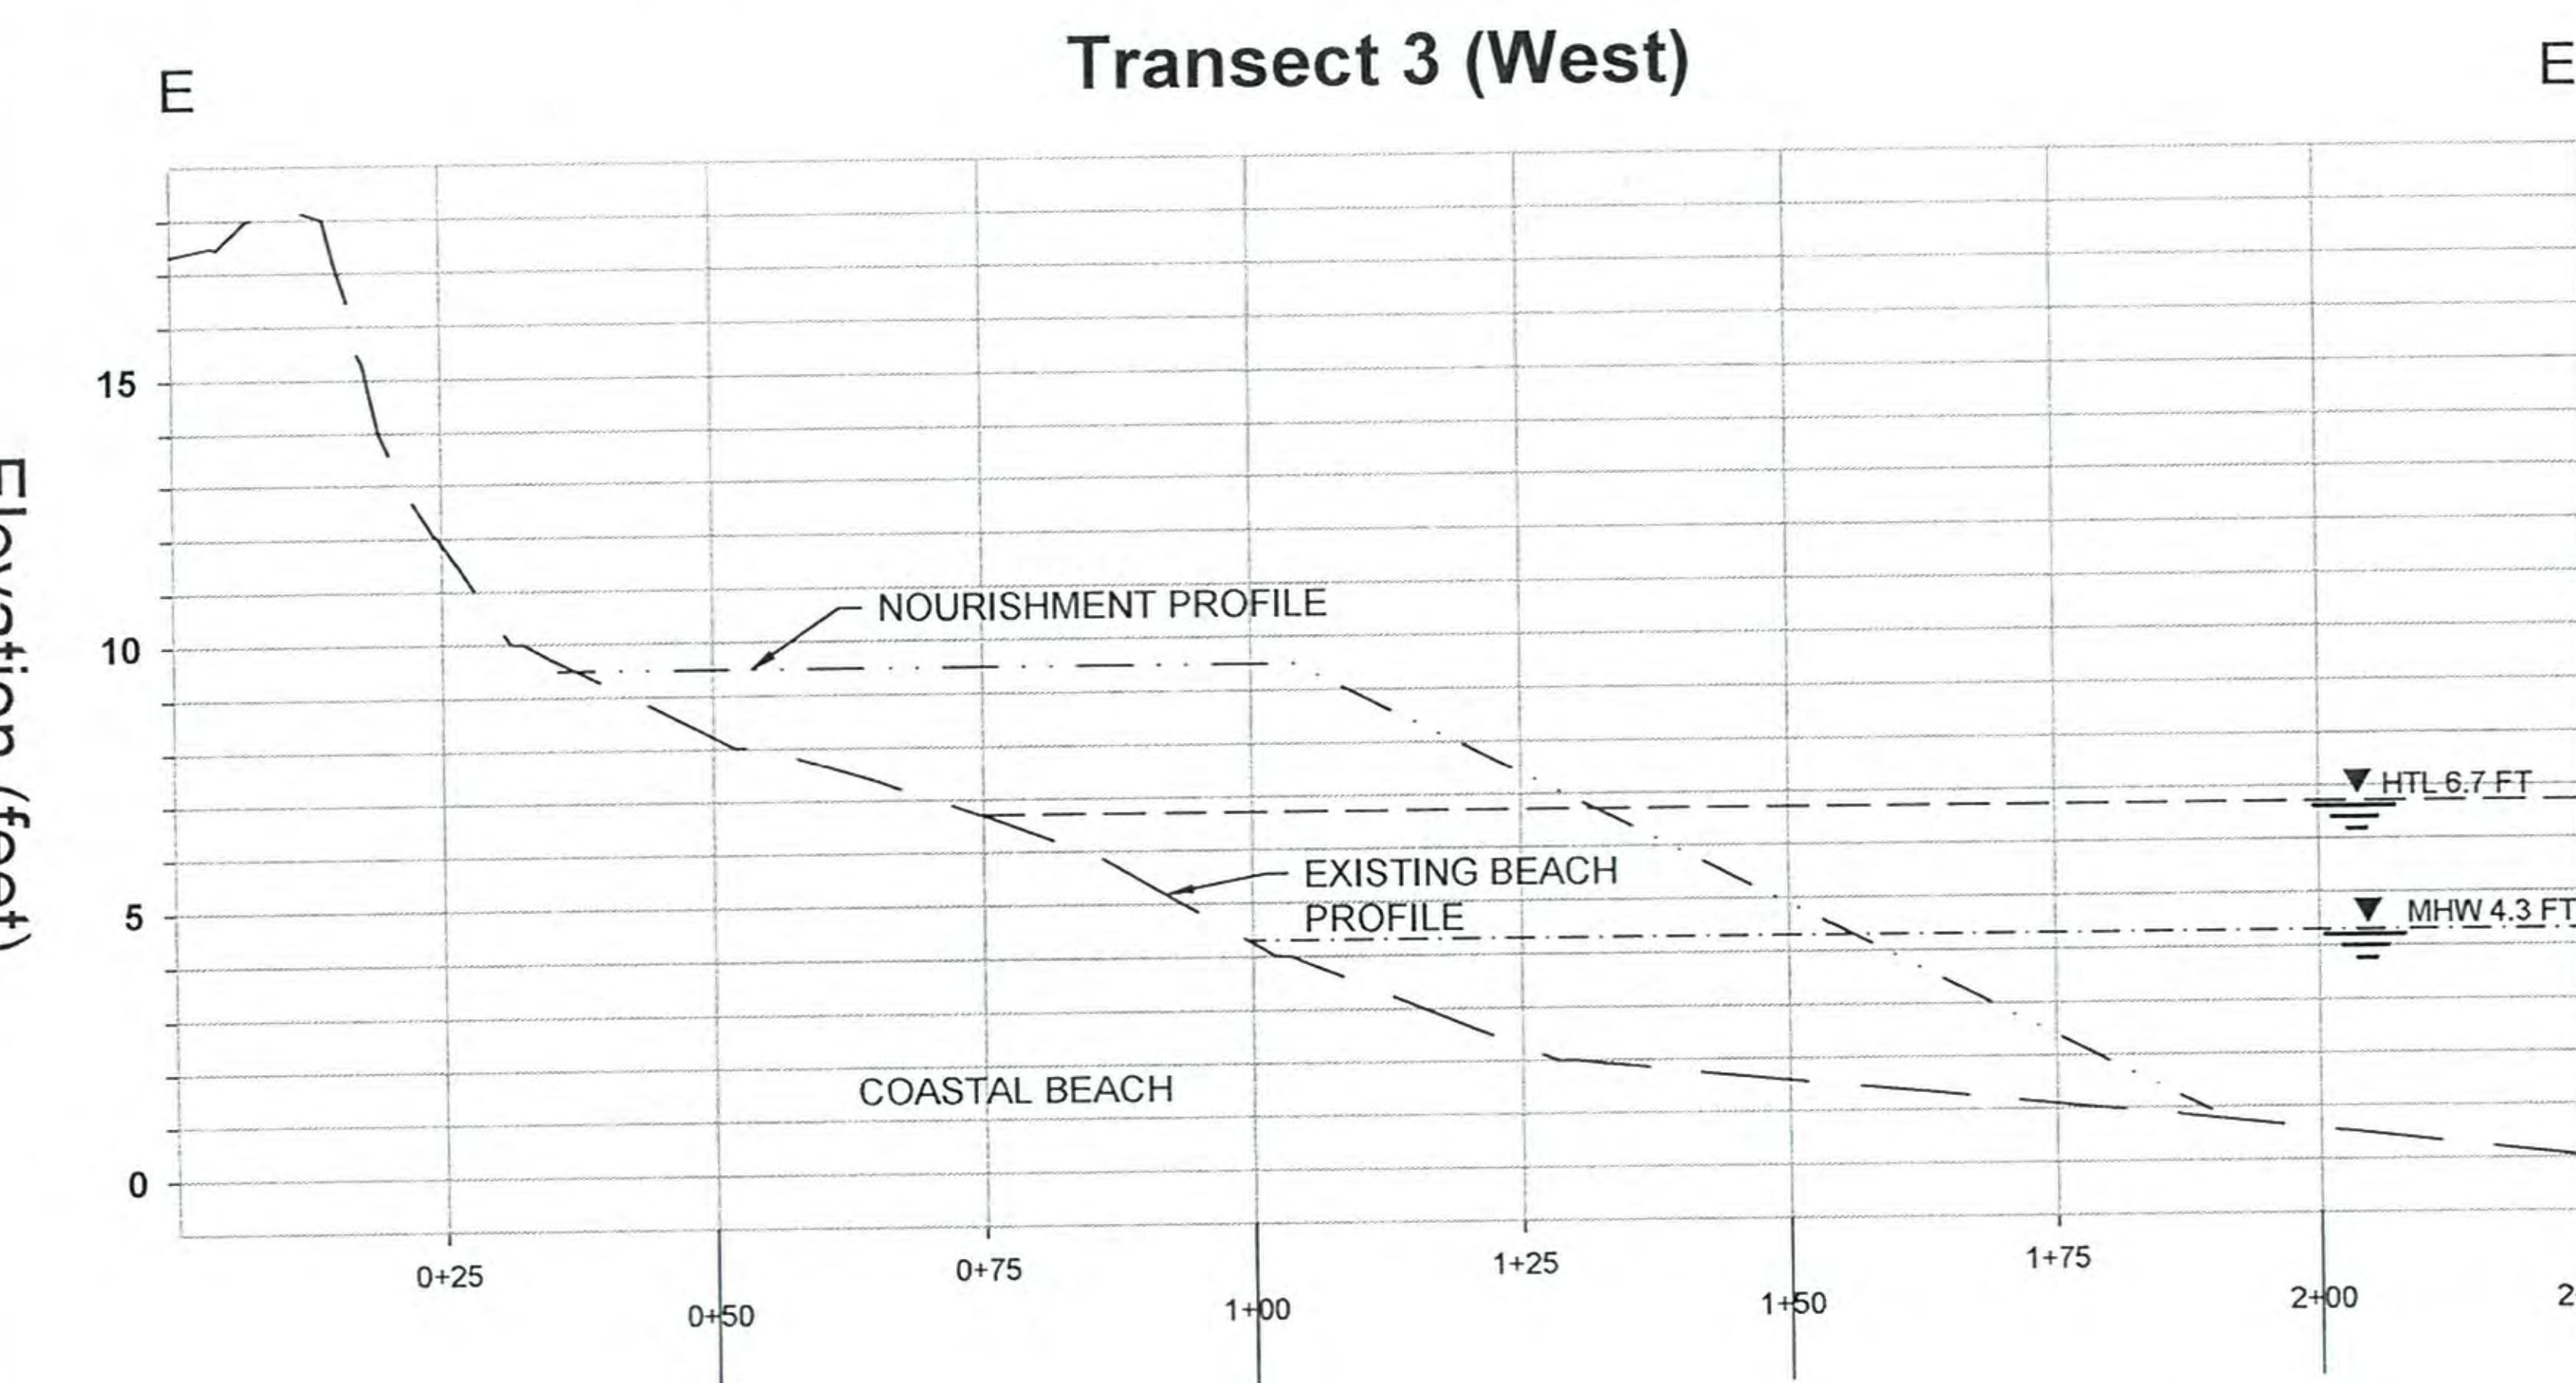

0 20 HORIZONTAL  
0 4 8 VERTICAL  
SCALE IN FEET

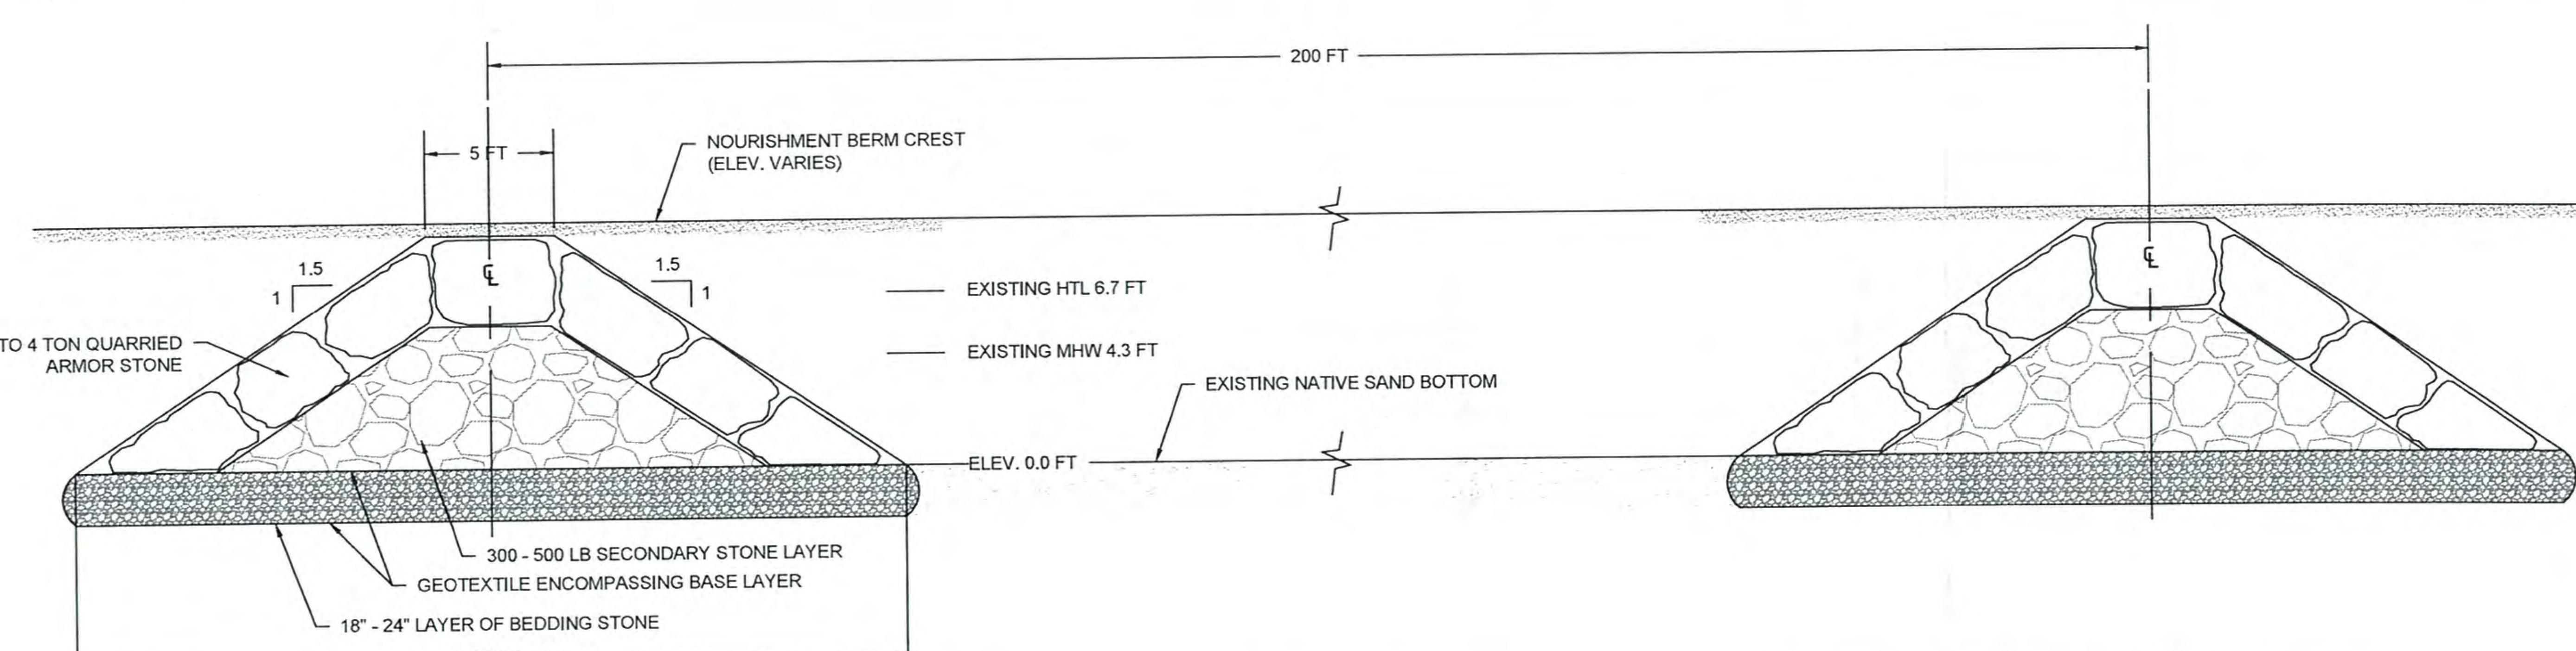

TYPICAL GROIN SECTION  
NOT TO SCALE

NOTE: GROIN CREST ELEVATIONS WILL VARY ALONG THE LENGTH OF THE STRUCTURES

For US Army Corps of Engineers Permit Application

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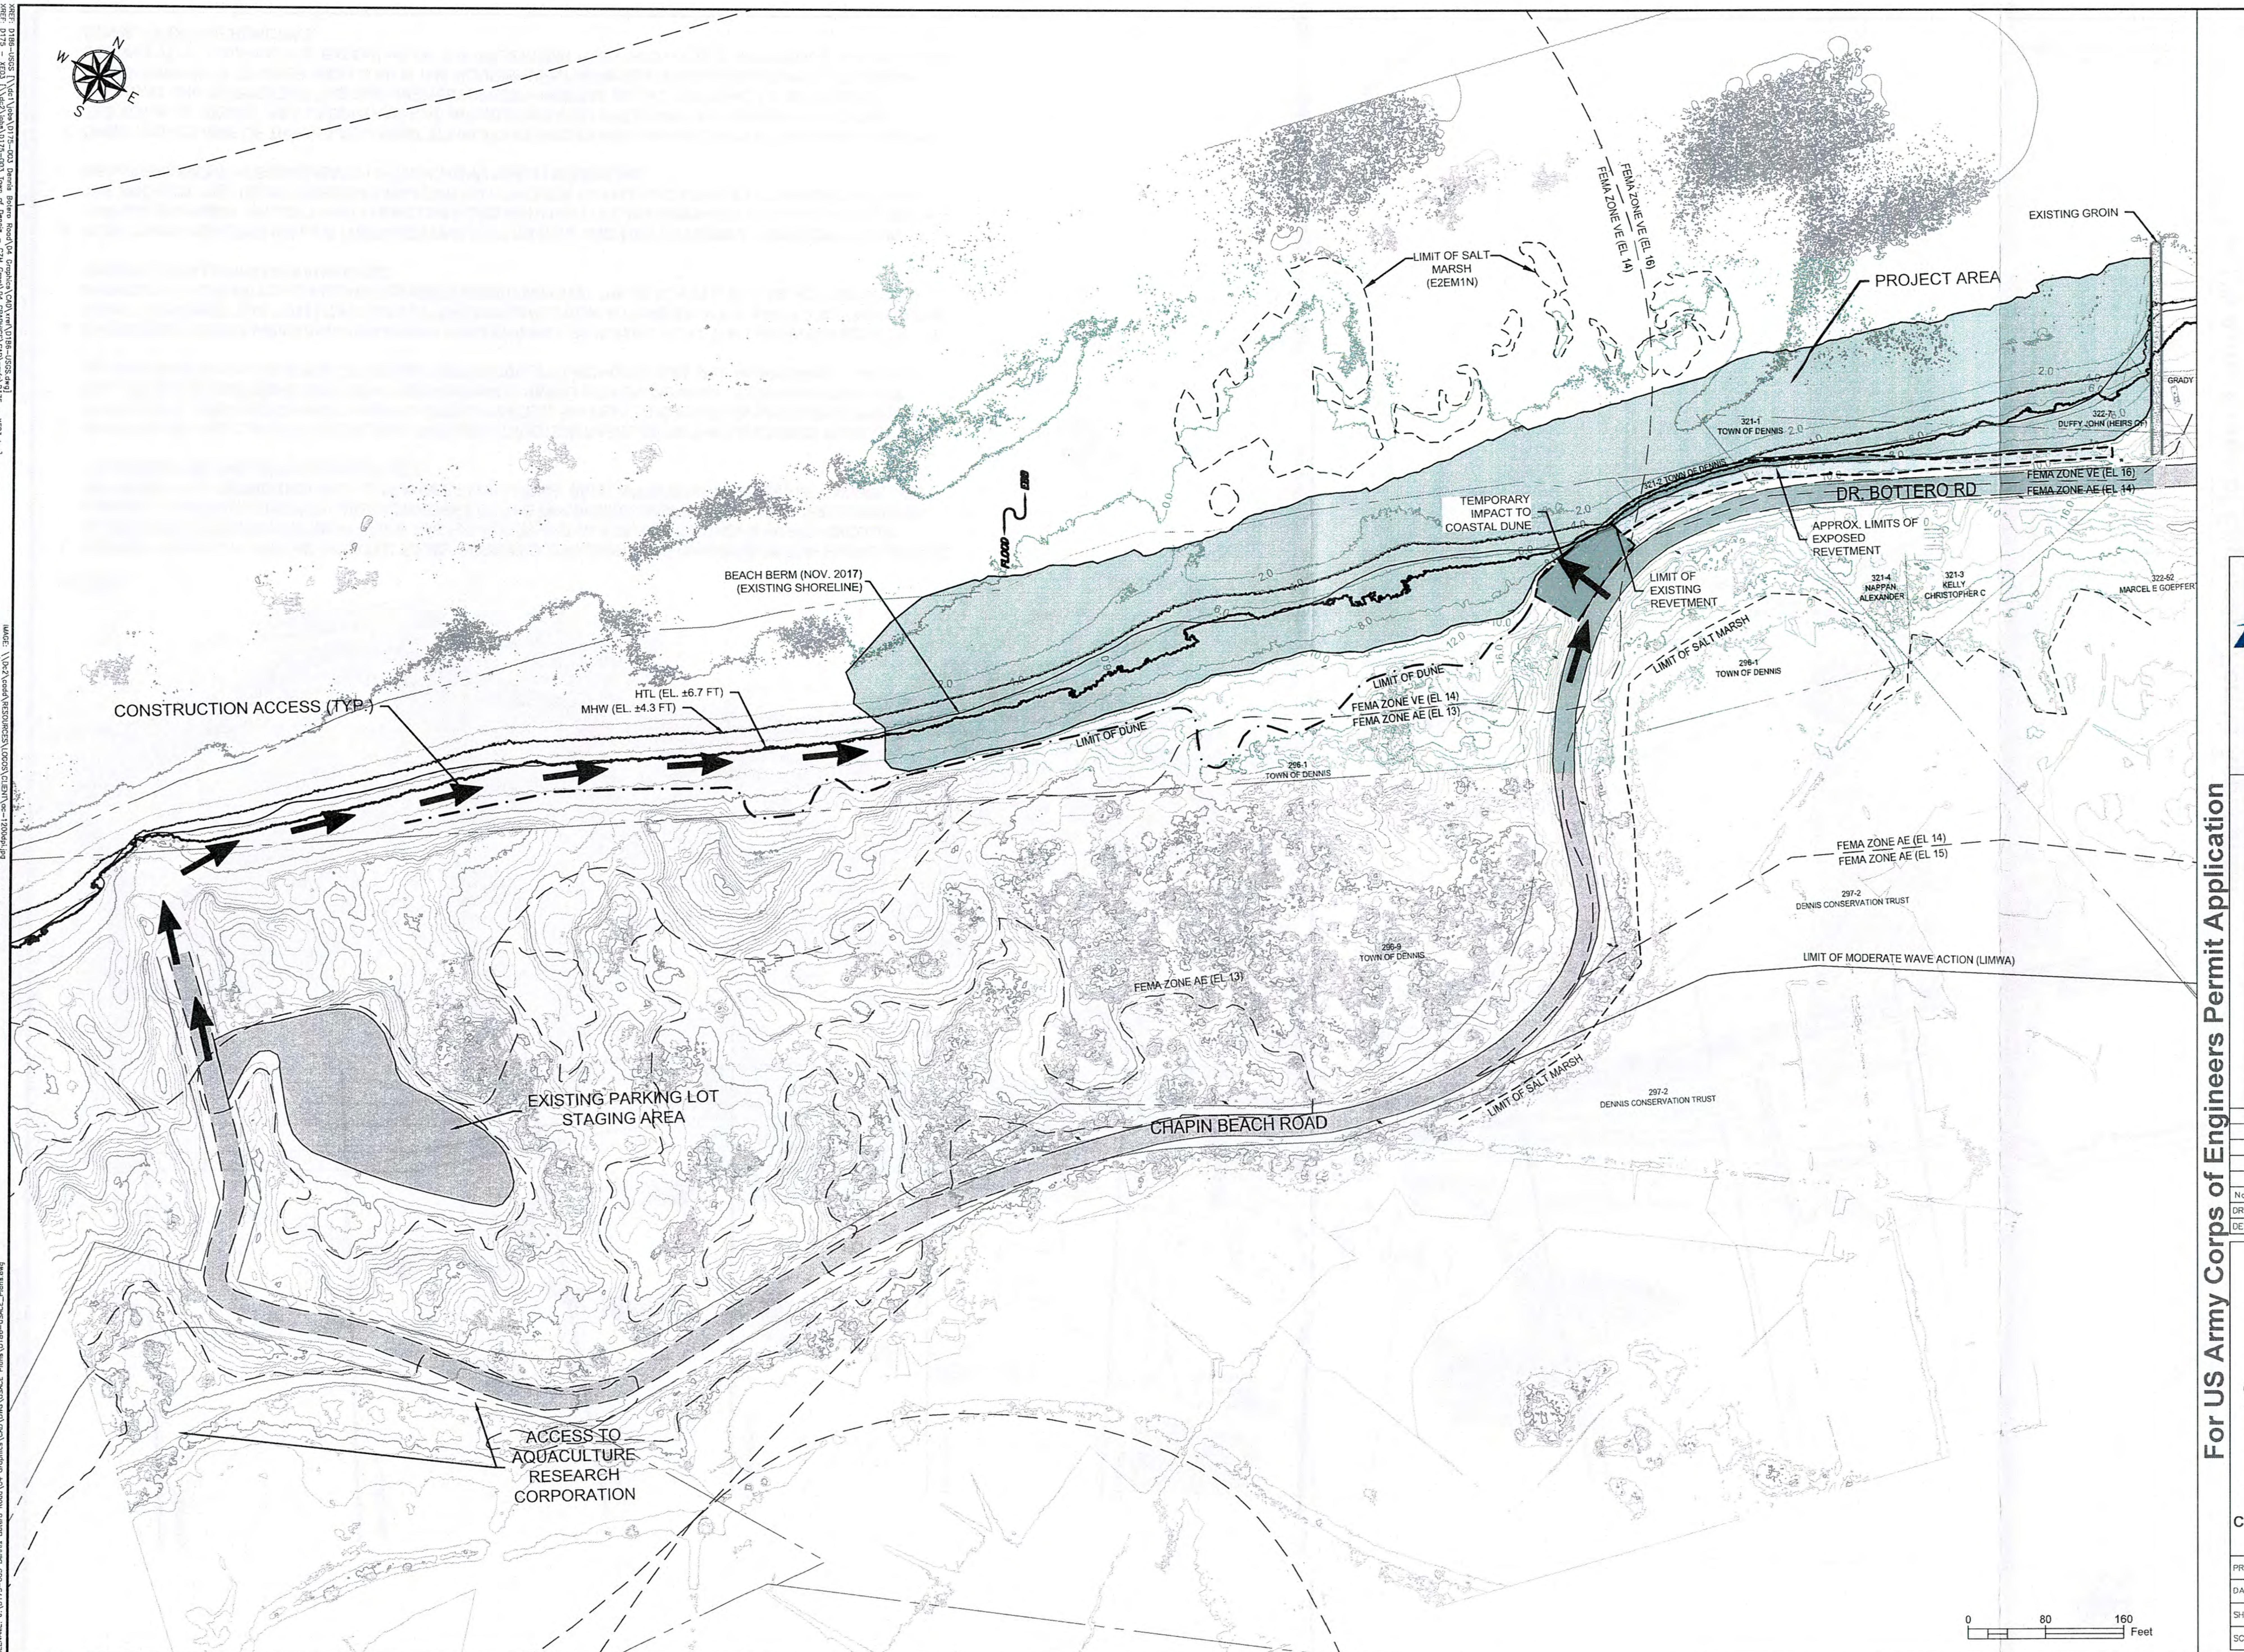
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#### SECTIONS

PROJECT No.: D1B6-0004 SHEET No.  
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SHEET No.: 6 OF 8  
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**6 OF 8**



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Application by:  
**TOWN OF DENNIS**


AT: DENNIS  
IN: CAPE COD BAY  
BARNSTABLE COUNTY

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## BOTTERO ROAD & CHAPIN BEACH IMPROVING COASTAL RESILIENCY

## **INSTRUCTION ACCESS & STAGING**

ECT No.:D186-000.04	SHEET No.
OF ISSUE:MARCH 2019	
T No.:7 OF 8	<b>7 OF 8</b>
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### For US Army Corps of Engineers Permit Application

No.	REVISION	DATE	APP BY
DRAWN BY: SJC	CHECKED BY: PRW		
DESIGNED BY: SJC	APPROVED BY: PRW		

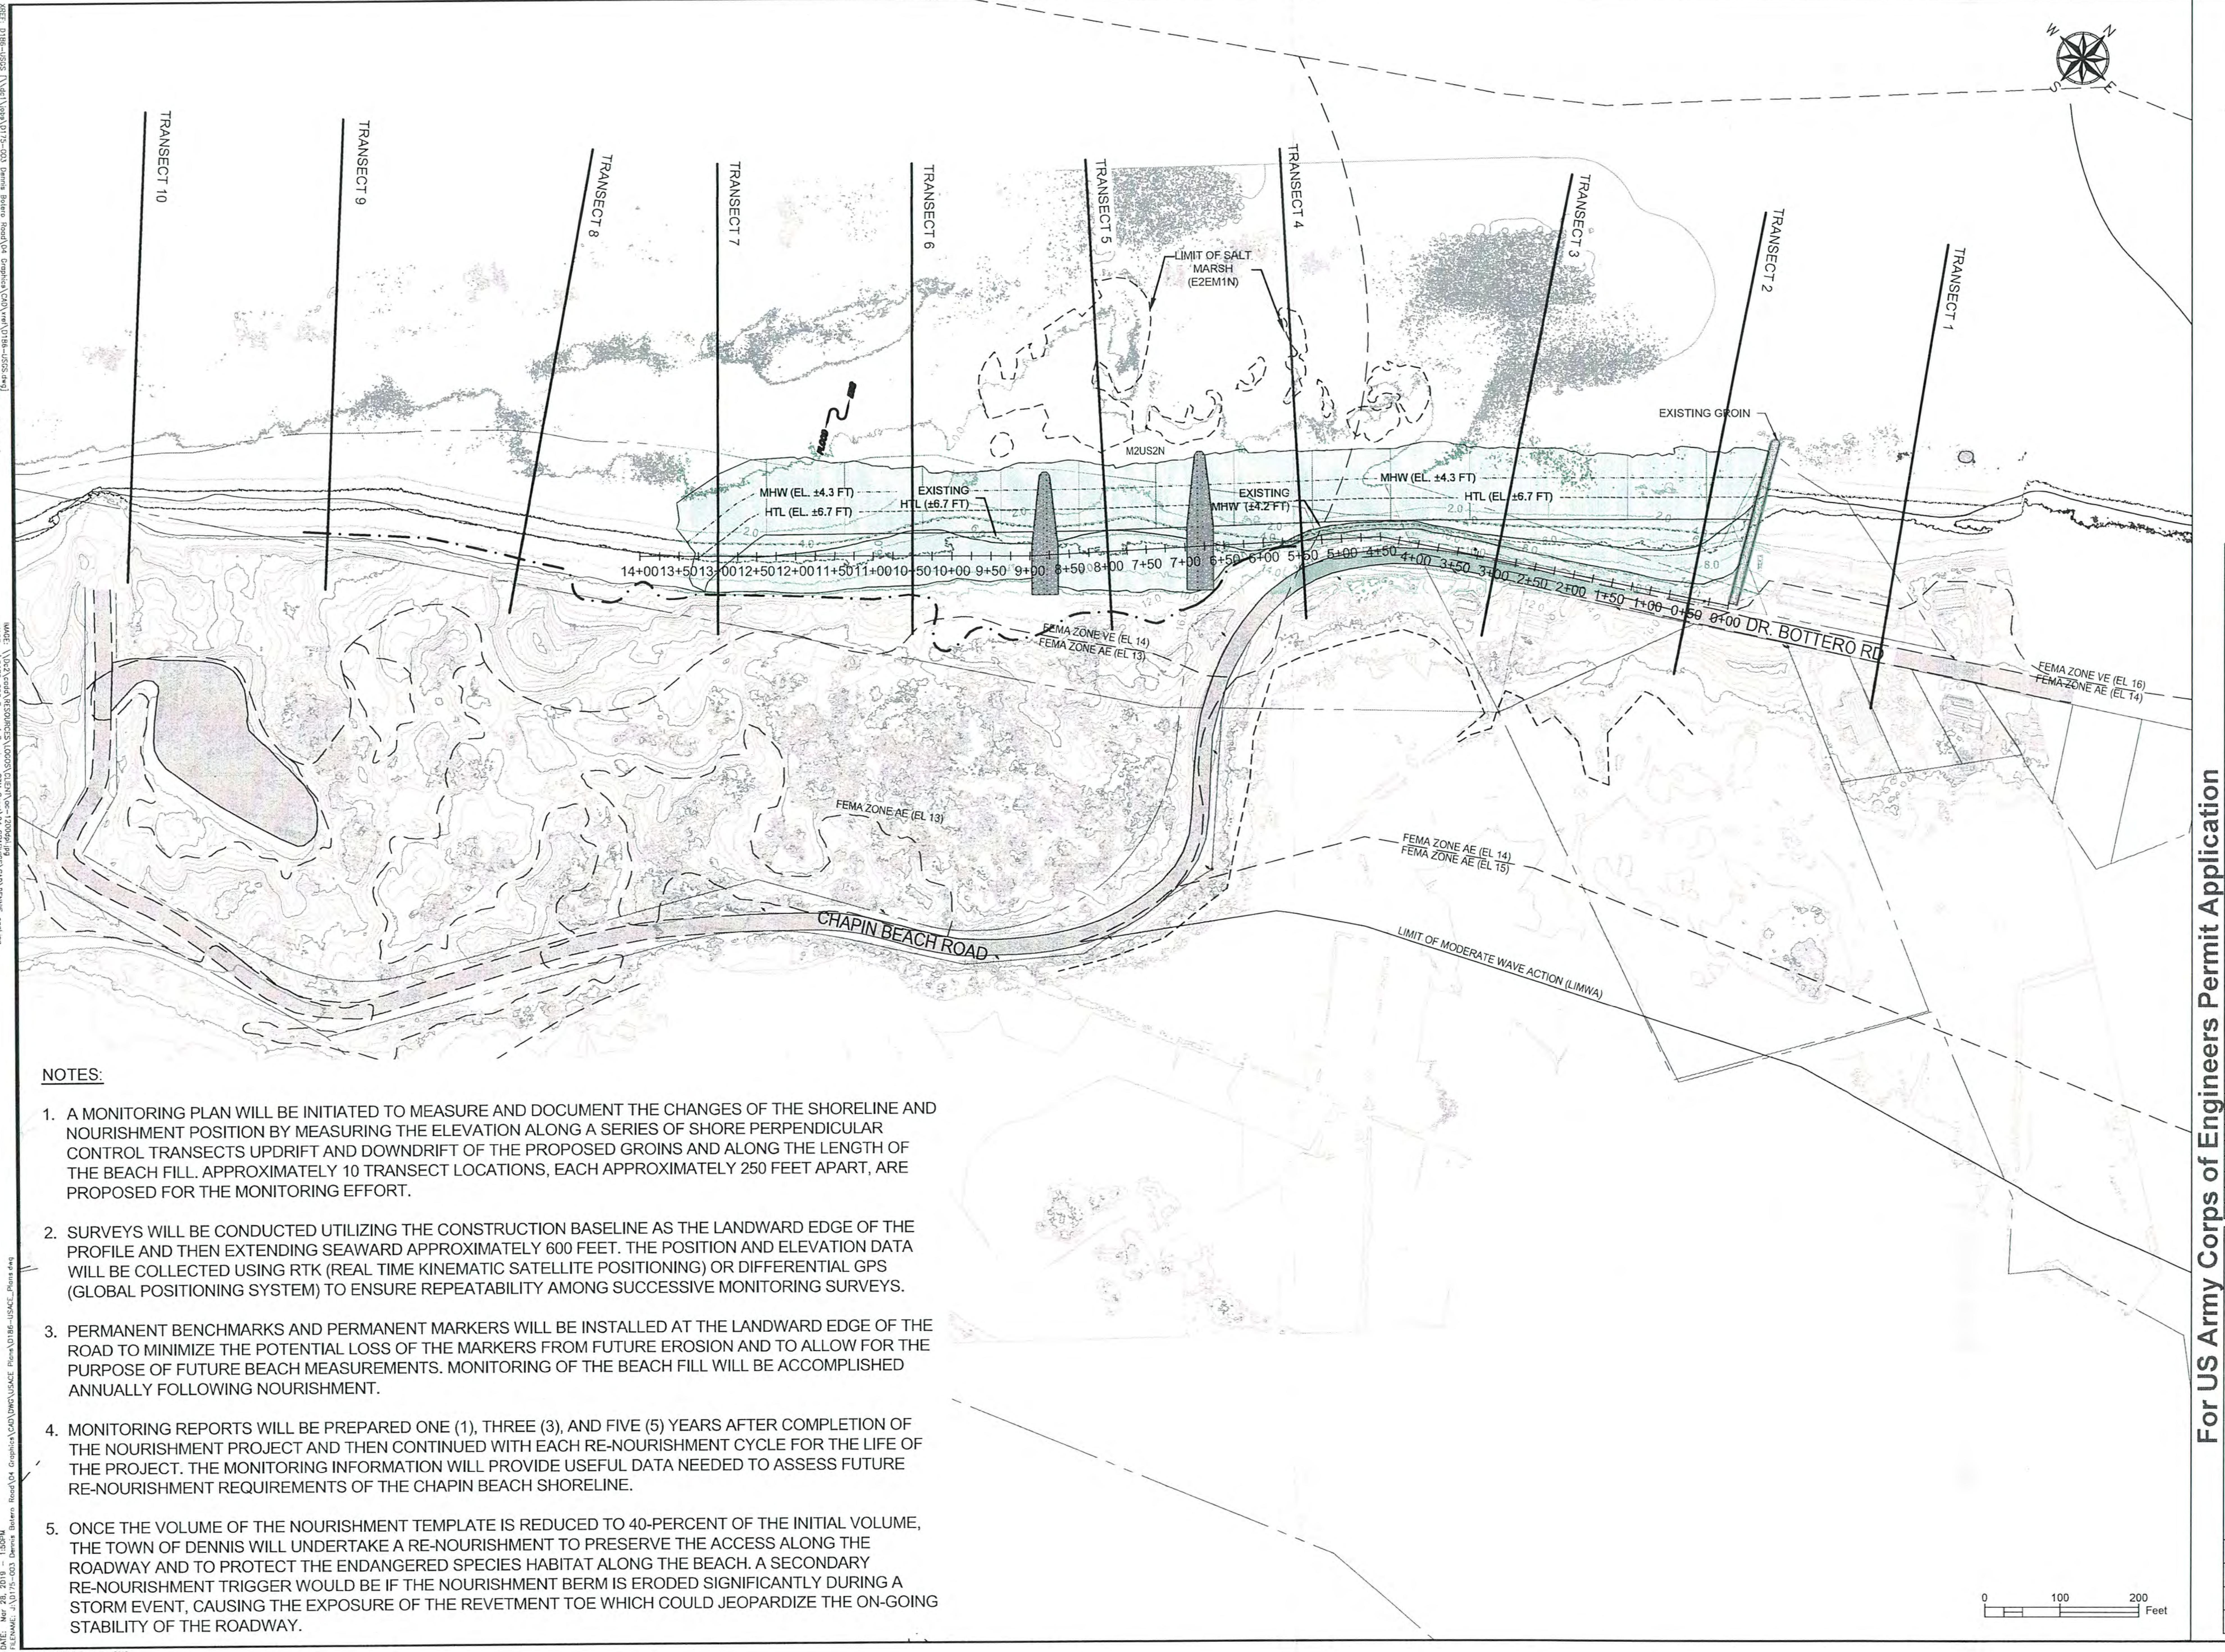Application by:  
**TOWN OF DENNIS**

AT: DENNIS  
IN: CAPE COD BAY  
BARNSTABLE COUNTY  
COMMONWEALTH OF MASSACHUSETTS

DR. BOTTERO ROAD & CHAPIN BEACH  
IMPROVING COASTAL RESILIENCY

#### MONITORING TRANSECTS

PROJECT No.: D186-000.04	SHEET No.
DATE OF ISSUE: MARCH 2019	
SHEET No.: 8 OF 8	
SCALE: AS SHOWN	

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