

PUBLIC NOTICE

Comment Period Begins: April 15, 2025 Comment Period Ends: May 15, 2025

File Number: NAE-2024-01243

In Reply Refer to: Paul Silva, Regulatory Division

Phone: (978) 318-8465

Email: paul.silva@usace.army.mil

The District Engineer, U.S. Army Corps of Engineers, New England District (USACE), has received a permit application, file number NAE-2024-01243, to conduct work in waters of the United States from Alan Rubacha, Wesleyan University, 170 Long Lane, Middletown Connecticut. This work is proposed in an unnamed stream and Long Lane Pond located north of Wadsworth Street, between Long Lane and Pine Street, Middletown, Connecticut. The site coordinates are latitude 41.545139 and longitude -72.662448.

The stream-fed pond has a footprint of approximately 1.13 acres and is impounded by an earthen berm and concrete dam. Some of the material within the berm contains coal ash from the coal-burning power plant that was on-site during the time of the Long Lane School operation.

Sediment samples from the pond and stream channel contain elevated concentrations of arsenic, lead, 4,4-DDT, 4,4-DDE, chlordane, and dieldrin, which are associated with historic agricultural uses in the area.

In accordance with the site Remedial Action Plan (RAP) Wesleyan University proposes to remediate and restore the pond and stream through encapsulation of the impacted bottom sediments beneath four feet of clean fill material and the construction of a new stream channel.

Proposed regulated work includes filling of the existing 1.13-acre pond to encapsulate impacted bottom sediments beneath four feet of clean material. A permanent sheeting wall will be installed on the pond-side of the dam to help retain the pond sediments and allow for removal of the existing dam structure. A new stream channel will be constructed through the pond footprint to connect the existing up- and downstream channels. An estimated volume of 800 cubic yards of pesticide-impacted surficial soil from other remediation areas on campus will be placed into the pond, followed by approximately 16,000 cubic yards (approximately 12,750 cubic yards in onsite pond/unnamed stream/inland wetlands) of clean fill material for construction of the cap and new channel.

The work is shown on the enclosed plans titled "Proposed Dam Removal and Restoration," on 11 sheets dated January 2024.

The project has been designed to restore the natural stream channel and encapsulate impacted bottom sediment. Construction activities have been designed to avoid and minimize impacts to surrounding inland wetlands to the greatest extent practicable

CENAE-R File No. NAE-2024-01243

AUTHORITY

through best management practices, including the installation of temporary erosion and sedimentation controls around the project site.

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Permits are required pursuant to:					
	Section 10 of the Rivers and Harbors Act of 1899				
Χ	Section 404 of the Clean Water Act				
	Section 103 of the Marine Protection, Research and Sanctuaries Act.				
	Section 14 of the Rivers and Harbors Act of 1899 (33 USC 408)				

The decision whether to issue a permit will be based on an evaluation of the probable impact of the proposed activity on the public interest. That decision will reflect the national concern for both protection and utilization of important resources. The benefit which may reasonably accrue from the proposal must be balanced against its reasonably foreseeable detriments. All factors which may be relevant to the proposal will be considered, including the cumulative effects thereof; among those are: conservation, economics, aesthetics, general environmental concerns, wetlands, cultural value, fish and wildlife values, flood hazards, flood plain value, land use, navigation, shoreline erosion and accretion, recreation, water supply and conservation, water quality, energy needs, safety, food production and, in general, the needs and welfare of the people.

The USACE is soliciting comments from the public; federal, state, and local agencies and officials; Indian Tribes; and other interested parties in order to consider and evaluate the impacts of this proposed activity. The USACE will consider all comments received to determine whether to issue, modify, condition or deny a permit for this proposal. To make this decision, comments are used to assess impacts on endangered species, historic properties, water quality, general environmental effects, and the other public interest factors listed above. Comments are used in the preparation of an environmental assessment and/or an environmental impact statement pursuant to the National Environmental Policy Act. Comments are also used to determine the need for a public hearing and to determine the overall public interest of the proposed activity.

Where the activity involves the discharge of dredged or fill material into waters of the United States or the transportation of dredged material for the purpose of disposing it in ocean waters, the evaluation of the impact of the activity in the public interest will also include application of the guidelines promulgated by the Administrator, U.S Environmental Protection Agency, under authority of Section 404(b) of the Clean Water Act, and/or Section 103 of the Marine Protection Research and Sanctuaries Act of 1972, as amended.

ESSENTIAL FISH HABITAT

The Magnuson-Stevens Fishery Conservation and Management Act, as amended by the Sustainable Fisheries Act of 1996 (Public Law 104-267), requires all federal agencies to consult with the National Marine Fisheries Service on all actions, or proposed actions, permitted, funded, or undertaken by the agency, that may adversely affect Essential Fish Habitat (EFH). EFH describes waters and substrate necessary for fish for spawning, breeding, feeding or growth to maturity.

This project will impact 1.13 acres of EFH. This habitat consists of a man-made pond and perennial watercourse and associated woody swamp and dense shrubby wetlands. Soil within the pond and wetlands consisted of poorly drained soil underlain by dense glacial till. Loss of this habitat may adversely affect species that use these waters and substrate. However, the District Engineer has made a preliminary determination that the site-specific adverse effect will not be substantial since the dam and earthen berm and the stream will be restored to its natural formation allowing upstream passage for present fish species. Further consultation with the National Marine Fisheries Service regarding EFH conservation recommendations is being conducted and will be concluded prior to the final decision.

NATIONAL HISTORIC PRESERVATION ACT

Based on our initial review of the proposed project (undertaking), there is no potential that the undertaking would affect historic properties. This conclusion is based upon the nature of the undertaking and site-specific conditions. Additional review and consultation to fulfill requirements under Section 106 of the National Historic Preservation Act of 1966, as amended, will be ongoing as part of the permit review process.

ENDANGERED SPECIES CONSULTATION

The USACE is reviewing the application for the potential impact on federally listed threatened or endangered species and their designated critical habitat pursuant to section 7 of the Endangered Species Act as amended. Our review will be concluded prior to the final decision.

The following authorizations have been applied for, or have been, or will be obtained:

- (X) Permit, license or assent from State.
- (X) Permit from local wetland agency or conservation commission.
- () Water Quality Certification in accordance with Section 401 of the Clean Water Act.

COMMENTS

The Corps of Engineers is soliciting comments from the public; Federal, state, and local agencies and officials; Indian Tribes; and other interested parties in order to consider and evaluate the impacts of this proposed activity. Any comments received will be considered by the Corps of Engineers to determine whether to issue, modify, condition or deny a permit for this proposal. To make this decision, comments are used to assess impacts on endangered species, historic properties, water quality, general environmental effects, and the other public interest factors listed above. Comments are used in the preparation of an Environmental Assessment and/or an Environmental Impact Statement pursuant to the National Environmental Policy Act. Comments are also used to determine the need for a public hearing and to determine the overall public interest of the proposed activity. People submitting comments are advised that all comments received will be available for public review in their entirety and will be considered a matter of public record.

Comments should be submitted in writing by the above date. If you have any questions, please contact Paul Silva, Regulatory Division, at paul.silva@usace.army.mil, (978) 318-8465, (800) 343-4789 or (800) 362-4367.

Any person may request, in writing, within the comment period specified in this notice, that a public hearing be held to consider the application. Requests for a public hearing shall specifically state the reasons for holding a public hearing. The USACE holds public hearings for the purpose of obtaining public comments when that is the best means for understanding a wide variety of concerns from a diverse segment of the public.

The initial determinations made herein will be reviewed in light of facts submitted in response to this notice. Copies of letters of objection will be forwarded to the applicant who will normally be requested to contact objectors directly in an effort to reach an understanding.


THIS NOTICE IS <u>NOT</u> AN AUTHORIZATION TO DO ANY WORK.

Kevin R Kotelly

Kevin R. Kotelly, P.E. Chief, CT/RI Section Regulatory Division

CEN	NAE	-R
File	No.	NAE-2024-01243

Please contact Ms. Tina Chaisson at bettina.m.chaisson@usace.army.mil or (978) 318-8058 if you would like to be removed from our public notice mailing list.

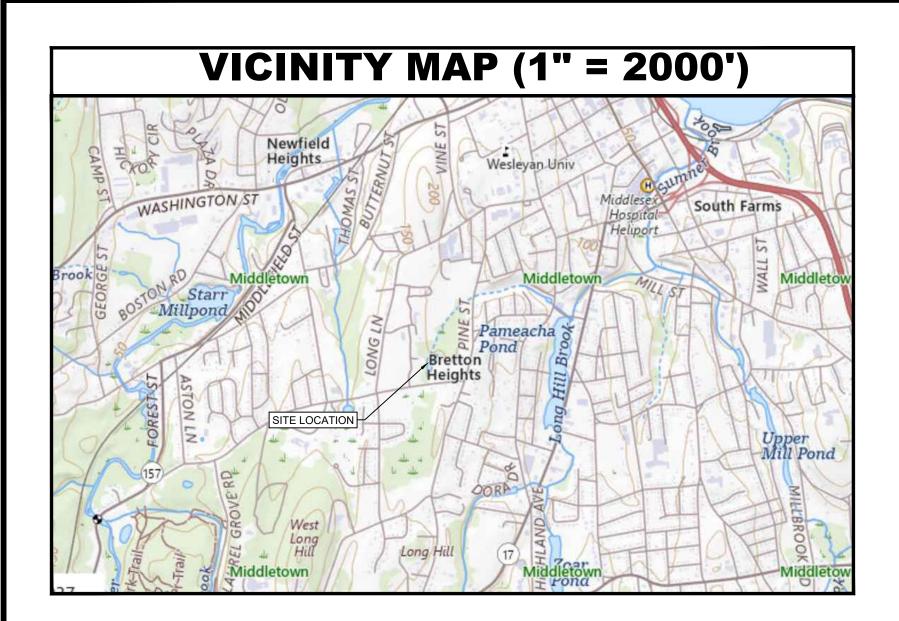

FOR PERMITTING PURPOSES ONLY

JANUARY 2024

PROPOSED DAM REMOVAL & RESTORATION

170 LONG LANE MIDDLETOWN, CT

HRP PROJECT NO. WES1757.RA

Prepared By:



197 SCOTT SWAMP ROAD FARMINGTON, CT 06032 (860) 674-9570 HRPASSOCIATES.COM

Prepared For:


WESLEYAN UNIVERSITY 170 LONG LANE MIDDLETOWN, CT



GENERAL NOTES

- 1. ALL DIMENSIONS, ELEVATIONS, AND EXISTING CONDITIONS SHALL BE FIELD VERIFIED BY TI CONTRACTOR PRIOR TO CONSTRUCTION. ANY DISCREPANCIES DISCOVERED DURING THE COURSE OF CONSTRUCTION SHALL BE PROMPTLY REPORTED TO THE ENGINEER.
- THE CONTRACTOR IS RESPONSIBLE FOR DETERMINING, PRIOR TO BIDDING, THE LOCATIONS OF ALL UTILITIES AND SHALL BE RESPONSIBLE FOR ALL DAMAGE TO SAID UTILITIES. THE CONTRACTOR SHALL CONTACT "CALL BEFORE YOU DIG" (1-800-922-4455), AT LEAST 72 HOURS PRIOR TO STARTING CONSTRUCTION. THE CONTRACTOR SHALL COORDINATE ACTIVITIES WITH INDIVIDUAL UTILITY COMPANIES.
- 3. THE CONTRACTOR IS RESPONSIBLE FOR ENSURING THAT PROPER STORM DRAINAGE IS MAINTAINED THROUGHOUT CONSTRUCTION.
- 4. ALL SOIL EROSION AND SEDIMENT CONTROL MEASURES SHALL BE INSPECTED AND MAINTAINED ON A REGULAR BASIS AS OUTLINED HEREIN. INSPECTION AND MAINTENANCE SHALL BE CARRIED OUT THROUGHOUT THE CONSTRUCTION PERIOD UNTIL ALL DISTURBED AREAS ARE STABILIZED WITH VEGETATION OR PAVING. THE MINIMUM INSPECTION PERIOD SHALL BE WEEKLY AND AFTER MAJOR STORMS.
- CONSTRUCTION ACTIVITIES SHALL CONFORM TO APPLICABLE SECTIONS OF THE TOWN OF MIDDLETOWN STANDARDS AND APPLICABLE SECTIONS OF THE CONNECTICUT DEPARTMEN OF TRANSPORTATION "STANDARD SPECIFICATIONS FOR ROADS, BRIDGES, AND INCIDENTAL CONSTRUCTION," FORM 819, AS AMENDED.

SHEET INDEX						
SHEET	TITLE / DESCRIPTION	CREATED	REVISED			
	TITLE	12/13/2024				
E-2	EXISTING CONDITIONS	09/12/2024	10/28/2024			
ES1.0	EROSION & SEDIMENTATION CONTROL PLAN	12/13/2024				
C0.0	SITE PREPARATION & CONSTRUCTION SEQUENCE	12/13/2024				
C0.1	BUFFER ZONE CONSTRUCTION & REMEDIAL EXCAVATION ACCESS PLAN	01/24/2025				
C1.0	GRADING & DRAINAGE - PHASE 1	01/24/2025				
C1.1	GRADING & DRAINAGE - PHASE 2	01/24/2025				
C2.0	SITE RESTORATION PLAN	01/24/2025				
D1.0	DETAILS	12/13/2024				
D1.1	DETAILS	12/13/2024				
D1.2	DETAILS	12/13/2024				
D1.2	DETAILS	12/13/2024				

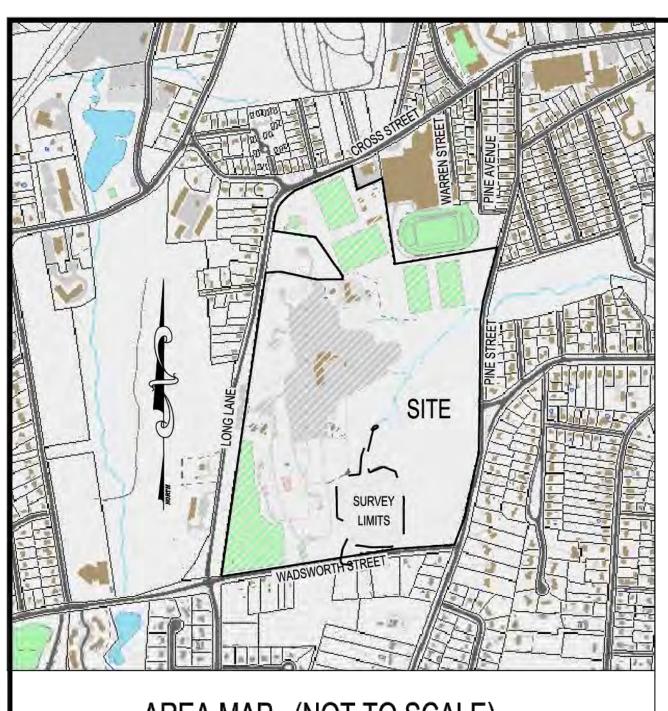

AREA MAP (NOT TO SCALE)

NOTES:

1. PARCEL OWNER: WESLEYAN UNIVERSITY

- SEE VOL 1224 AT PG 898 OF CITY OF MIDDLETOWN LAND RECORDS FOR A QUIT-CLAIM DEED DATED

FEBUARY 2, 2000 2. ADDRESS: 170 LONG LANE, MIDDLETOWN, CT

3. AREA: 91.7± AC (FROM MIDDLETOWN TAX ASSESSOR)

4. ZONE: RESIDENTIAL (R-15)

5. THE SUBJECT PARCEL MAY BE SUBJECT TO OR BENEFIT BY THE EASEMENTS, RIGHTS OF WAY, AND/OR AGREEMENTS AS MAY APPEAR ON RECORD:

A. 25'X30' DRAINAGE EASEMENT — SEE MAP REF. A — OUTSIDE SUVREY LIMITS (PLOTTED)

B. 30'X30' DRAINAGE EASEMENT — SEE MAP REF. A — WITHIN SURVEY LIMITS (PLOTTED)

C. 145'X30' DRAINAGE EASEMENT — SEE MAP REF. A — OUTSIDE SUVREY LIMITS (PLOTTED)

6. BEARINGS ARE REFERENCED TO NORTH AMERICAN DATUM OF 1983 (NAD83).

7. ELEVATIONS ARE REFERENCED TO NORTH AMERICAN VERTICAL DATUM OF 1988 (NAVD88).

— CONTOUR INTERVAL IS 1—FOOT

8. THIS PLAN REPRESENTS THE LOCATION OF THE BOUNDS AND SITE CONDITIONS DETERMINED BY FIELD SURVEY AUGUST—SEPTEMBER 2024. RECORD TITLE AND ADJOINER INFORMATION WAS OBTAINED FROM

TAX ASSESSOR AND LAND EVIDENCE RECORDS SEPTEMBER 2024.

9. UNDERGROUND UTILITY, STRUCTURE, AND FACILITY LOCATIONS DEPICTED HEREON HAVE BEEN COMPILED, IN PART, FROM RECORD MAPPING AND OTHER DATA SUPPLIED BY RESPECTIVE UTILITY COMPANIES, GOVERNMENTAL AGENCIES, AND/OR OTHER SOURCES. THESE LOCATIONS MUST BE CONSIDERED

APPROXIMATE IN NATURE. ADDITIONALLY, OTHER SUCH FEATURES MAY EXIST ON SITE. THE EXISTENCE, SIZE, AND LOCATION OF ALL SUCH FEATURES MUST BE DETERMINED AND VERIFIED IN THE FIELD BY THE APPROPRIATE AUTHORITIES PRIOR TO BEGINNING CONSTRUCTION. CALL "CALL BEFORE YOU DIG" AT 811 OR 1-800-922-4455.

MAP REFERENCES:

A. "MAP OF SURVEY SHOWING PROPERTY TO BE ACQUIRED BY WESLEYAN UNIVERSITY, FORMERLY CONNECTICUT INDUSTRIAL SCHOOL FOR GIRLS, EAST SIDE OF LONG LANE, NORTH SIDE OF WADSWORTH STREET, AND WEST SIDE OF PINE STREET, MIDDLETOWN, CONNECTICUT"; SCALE 1"=100 FT.; 01 NOV 1999; MAP BY: BASCOM MAGNOTTA, INC.

B. "SITE DRAINAGE — PHYSICAL EDUCATION CENTER, WESLEYAN UNIVERSITY, MIDDLETOWN, CT"; SCALE 1"=40'-0"; DATE: MAY 14, 1988, REV 5-1-89; MAP BY: NEWMANS ARCHITECTS

HRP ASSOCIATES, INC. NOTES:

Ex. 25'x30' Drainage Easement In Favor of City of Middletown

A. WETLAND DELINEATION/FLAGGING IN FIELD PROVIDED BY "ON-SITE SOIL INVESTIGATION REPORT, WESLEYAN UNIVERSITY POND PROJECT, MIDDLETOWN, CONNECTICUT," PREPARED BY JMM WETLAND CONSULTING SERVICES, LLC., DATED OCTOBER 3, 2024, FIELD INVESTIGATION DATED AUGUST 2 & AUGUST 15, 2024





Disclaimer:
The underground utilities shown have been located from limited field survey information and existing drawings. The surveyor makes no guarantee that the underground utilities shown comprise all such utilities in the area either in service or abandoned. To meet the requirements of our professional liability insurance, the terms CERTIFICATE, CERTIFY, AND CERTIFICATION mean to the best information, knowledge, and belief of the engineer; and are not an unconditional certification, warranty or guarantee which are not covered under the policy.

REVISIONS TO THESE PLANS BY ANYONE OTHER THAN KJA SHALL MAKE THESE PLANS NULL AND VOID. KJA SHALL TAKE NO RESPONSIBILITY FOR SAID REVISIONS.

REVISION-7: REVISION-6: REVISION-5: REVISION-4: REVISION-3: REVISION-2: REVISION-1:10-28-24 ADD'L TOPO SURVEY NOTES: THIS MAP HAS BEEN PREPARED IN ACCORDANCE WITH THE "MINIMUM STANDARDS OF ACCURACY, CONTENT AND CERTIFICATION FOR SURVEYS AND MAPS IN THE STATE OF CONNECTICUT" AS REVISED 2018-10-26 FOR USE BY THE REGULATIONS OF CONNECTICUT STATE AGENCIES. (CT SECTIONS 20-300b-1 TO 20-300b-20). THE TYPE OF SURVEY PERFORMED IS AN IMPROVEMENT LOCATION SURVEY. BOUNDARY DETERMINATION IS BASED UPON A THIS SURVEY CONFORMS TO CLASS A-2/T-2. TO MY KNOWLEDGE AND BELIEF THIS MAP IS SUBSTANTIALLY CORRECT AS NOTED HEREON. CT P.E. & L.S. #11302 kratzert, jones & associates, inc. CIVIL ENGINEERS . LAND SURVEYORS

1755 MERIDEN-WATERBURY RD.
MILLDALE, CT 06467-0337

PHONE: (860) 621-3638

FAX: (860) 621-9609

EMAIL: INFO@KRATZERTJONES.COM

SITE PLANNERS • BUILDING ENGINEERS

P.O. BOX 337

EXISTING CONDITIONS
MAP SHOWING
POND & WATERCOURSE
AT WESLEYAN
UNIVERSITY

for

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HRP ASSOCIATES, INC.

170 LONG LANE MIDDLETOWN, CT

SCALE: 1" = 50'

DATE: SEPTEMBER 12, 2024

HALF ONE INCH TWO INCH

KJA FILE NO. : DRAWING NO. :

23-107 E-2



MAP REFERENCE:

- 1. "EXISTING CONDITIONS MAP SHOWING POND & WATERCOURSE AT WESLEYAN UNIVERSITY, 170 LONG LANE, MIDDLETOWN, CT," PREPARED BY KRATZERT, JONES & ASSOCIATES, INC., SCALE 1" = 50', DATED SEPTEMBER 12, 2024, LAST REVISED OCTOBER 28, 2024
- 2. 2023 LIDAR-DERIVED CONTOURS PROVIDED BY THE CONNECTICUT ENVIRONMENTAL CONDITIONS ONLINE DATABASE SUPPLEMENT THE EXISTING CONDITIONS MAP, WITH THE SURVEY BOUNDARY DEPICTED ON THE

SEDIMENTATION AND EROSION CONTROL PLAN

THE PLAN PROPOSES EROSION CONTROL MEASURES TO ADEQUATELY CONTROL ACCELERATED EROSION AND SEDIMENTATION AND REDUCE THE DANGER FROM STORM WATER RUNOFF AT THE SITE. THE RUNOFF SHALL BE CONTROLLED BY THE INTERCEPTION, DIVERSION, AND SAFE DISPOSAL OF PRECIPITATION. RUNOFF SHALL ALSO BE CONTROLLED BY STAGING CONSTRUCTION ACTIVITY AND PRESERVING NATURAL VEGETATION WHENEVER POSSIBLE.

EXISTING VEGETATION SHALL BE PROTECTED AND ONLY THAT CLEARING AND GRUBBING ABSOLUTELY NECESSARY FOR THE PROPOSED CONSTRUCTION SHALL BE PERFORMED. ALL DISTURBED AREAS SHALL BE RESTORED TO THEIR ORIGINAL CONDITION AND CONTOUR, UNLESS OTHERWISE INDICATED ON THE PLANS. THE CONTRACTOR SHALL TAKE A SPECIAL CARE WITH HIS CONSTRUCTION METHODS AND SHALL COMPLY WITH THE FOLLOWING GUIDELINES.

REFERENCE IS MADE TO THE "CONNECTICUT GUIDELINES FOR SOIL EROSION AND SEDIMENT CONTROL", PUBLISHED SEPTEMBER 30, 2024, AS AMENDED. THE GUIDELINES ARE OBTAINABLE FROM THE CONNECTICUT COUNCIL ON SOIL AND WATER CONSERVATION, STATE OFFICE BUILDING, HARTFORD, CONNECTICUT, AND SHOULD BE USED AS A REFERENCE IN CONSTRUCTING THE EROSION AND SEDIMENT CONTROLS INDICATED ON THESE PLANS.

THIS PROJECT WILL BE SUBJECT TO THE CONNECTICUT DEPARTMENT OF ENERGY AND ENVIRONMENTAL PROTECTION GENERAL PERMIT FOR THE DISCHARGE OF STORMWATER AND DEWATERING WASTEWATERS FROM CONSTRUCTION ACTIVITIES. A PROJECT-SPECIFIC STORMWATER POLLUTION CONTROL PLAN (SWPCP) WILL BE DEVELOPED AND COVERAGE UNDER THE GENERAL PERMIT WILL BE ACQUIRED BEFORE CONSTRUCTION BEGINS.

SEDIMENTATION CONTROL

ALL AREAS SHALL BE PROTECTED FROM SEDIMENTATION DURING AND AFTER CONSTRUCTION, PARTICULARLY THE STORAGE OF EXCAVATED OR STOCKPILED MATERIAL. THE CONTRACTOR SHALL CAREFULLY STRIP ALL TOPSOIL, LOAM, OR ORGANIC MATTER PRIOR TO TRENCHING OR OTHER OPERATION, AND SHALL STORE THEM SEPARATELY FROM ALL OTHER MATERIALS DURING EXCAVATION. EACH STOCKPILE MUST BE ADEQUATELY RINGED WITH SEDIMENT CONTROL MATERIAL (I.E. STRAW BALES AND/OR GEOTEXTILE).

STABILIZING OF SLOPES SHALL BE DONE IMMEDIATELY AFTER CONSTRUCTION OF SLOPES. SLOPES STEEPER THAN 2:1 SHALL BE PROTECTED WITH JUTE MESH EROSION PROTECTION. ALL OTHER AREAS SHALL BE MULCHED WITH STRAW AS REQUIRED UNDER TURF ESTABLISHMENT.

EROSION CONTROL PLAN

SEDIMENTATION CONTROL SYSTEM - THE SEDIMENTATION CONTROL SYSTEM SHALL CONSIST OF GEOTEXTILE BARRIER FENCE OR STACKED STRAW BALES/WATTLES.

GEOTEXTILE BARRIER FENCE - THE SEDIMENTATION CONTROL SYSTEM SHALL BE INSTALLED IMMEDIATELY AFTER A CUT SLOPE HAS BEEN GRADED, BEFORE A FILL SLOPE HAS BEEN CREATED AND AS INDICATED ON THE PLANS. THE SYSTEM IS DESIGNED TO INTERCEPT SILT AND SEDIMENT BEFORE IT REACHES THE WETLAND AREAS, OR WATERCOURSES. DEPOSITS OF SEDIMENT AND SILT ARE TO BE PERIODICALLY REMOVED FOR THE UPSTREAM SIDE OF THE FENCE. THIS MATERIAL IS TO BE SPREAD AND STABILIZED IN AREAS NOT SUBJECT TO EROSION, OR IN AREAS WHICH ARE NOT TO BE PAVED OR BUILT ON. THE SEDIMENTATION CONTROL SYSTEM AREAS IS TO BE REPLACED AS NECESSARY TO PROVIDE PROPER FILTERING ACTION. THE SYSTEM IS TO REMAIN IN PLACE AND BE MAINTAINED TO INSURE EFFICIENT SILTATION CONTROL UNTIL ALL AREAS ABOVE THE FENCE ARE STABILIZED AND VEGETATION HAS BEEN ESTABLISHED.

STACKED STRAW BALES/WATTLES - STRAW BALES/WATTLES USED FOR EROSION CONTROL SHALL BE PLACED AS INDICATED ON THE PLANS, STACKED AT CATCH BASINS WHERE SEDIMENT MAY ENTER THE CATCH BASINS, OR AS DIRECTED BY THE RESIDENT ENGINEER. DEPOSITS OF SEDIMENT AND SILT ARE TO BE PERIODICALLY REMOVED FROM THE UPSTREAM SIDE OF THE EROSION CHECKS. THIS MATERIAL IS TO BE SPREAD AND STABILIZED IN AREAS NOT SUBJECT TO EROSION, OR IN AREAS WHICH ARE NOT TO BE BUILT OR PAVED ON. STRAW BALES/WATTLES ARE TO BE REPLACED AS NECESSARY TO PROVIDE PROPER FILTERING ACTION. EROSION CHECKS ARE TO REMAIN IN PLACE AND MAINTAINED TO ENSURE EFFICIENT SILTATION CONTROL UNTIL ALL AREAS ABOVE THE EROSION CHECKS ARE STABILIZED AND VEGETATION HAS BEEN

IN ALL AREAS, REMOVAL OF TREES, BUSHES AND OTHER VEGETATION, AND DISTURBANCE OF THE SOIL, IS TO BE KEPT TO AN ABSOLUTE MINIMUM WHILE ALLOWING PROPER DEVELOPMENT OF THE SITE.

DURING CONSTRUCTION, AS SMALL AN AREA OF SOIL AS POSSIBLE SHOULD BE EXPOSED FOR AS SHORT A TIME AS POSSIBLE. AFTER CONSTRUCTION, GRADE, RESPREAD TOPSOIL, AND STABILIZE SOIL BY SEEDING AND MULCHING SO AS TO PREVENT EROSION.

SEDIMENTATION AND EROSION CONTROL MAINTENANCE PROCEDURES

ALL SEDIMENTATION AND EROSION CONTROL DEVICES SHALL BE INSPECTED DURING CONSTRUCTION ON A WEEKLY BASIS, AND FOLLOWING ALL STORMS, BY THE ENGINEER. THE CONTRACTOR SHALL MAINTAIN AND MAKE REPAIRS AND REMOVE SEDIMENT AS REQUESTED BY THE ENGINEER. THIS WORK SHALL BE PERFORMED WITH 24 HOURS OF THE REQUEST AND THERE SHALL BE NO SEPARATE PAYMENT FOR THIS WORK.


THE CONTRACTOR SHALL CLEAN SEDIMENT AND DEBRIS FROM ALL DRAINAGE STRUCTURES AND PIPES AT THE COMPLETION OF CONSTRUCTION, AND AS REQUESTED BY THE ENGINEER TO KEEP THE SYSTEM FUNCTIONING PROPERLY DURING CONSTRUCTION. THE CONTRACTOR SHALL SWEEP ADJACENT ROADWAYS AS REQUIRED OR REQUESTED BY THE ENGINEER. FOLLOWING COMPLETION OF CONSTRUCTION, THE CONTRACTOR SHALL REPAIR ALL ERODED AREAS AND ENSURE A GOOD STAND OF TURF IS ESTABLISHED THROUGHOUT. THE CONTRACTOR SHALL REPAIR ALL ERODED OR DISPLACED RIPRAP, AND CLEAN SEDIMENT COVERED STONES.


197 SCOTT SWAMP ROAD FARMINGTON, CT 06032

HRPASSOCIATES.COM

(860) 674-9570



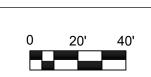

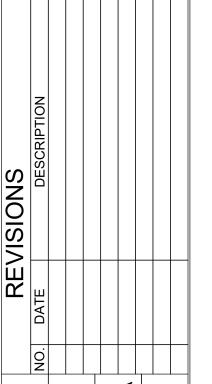




PROPOSED | REST SL

SHEET NO.

ES1.0

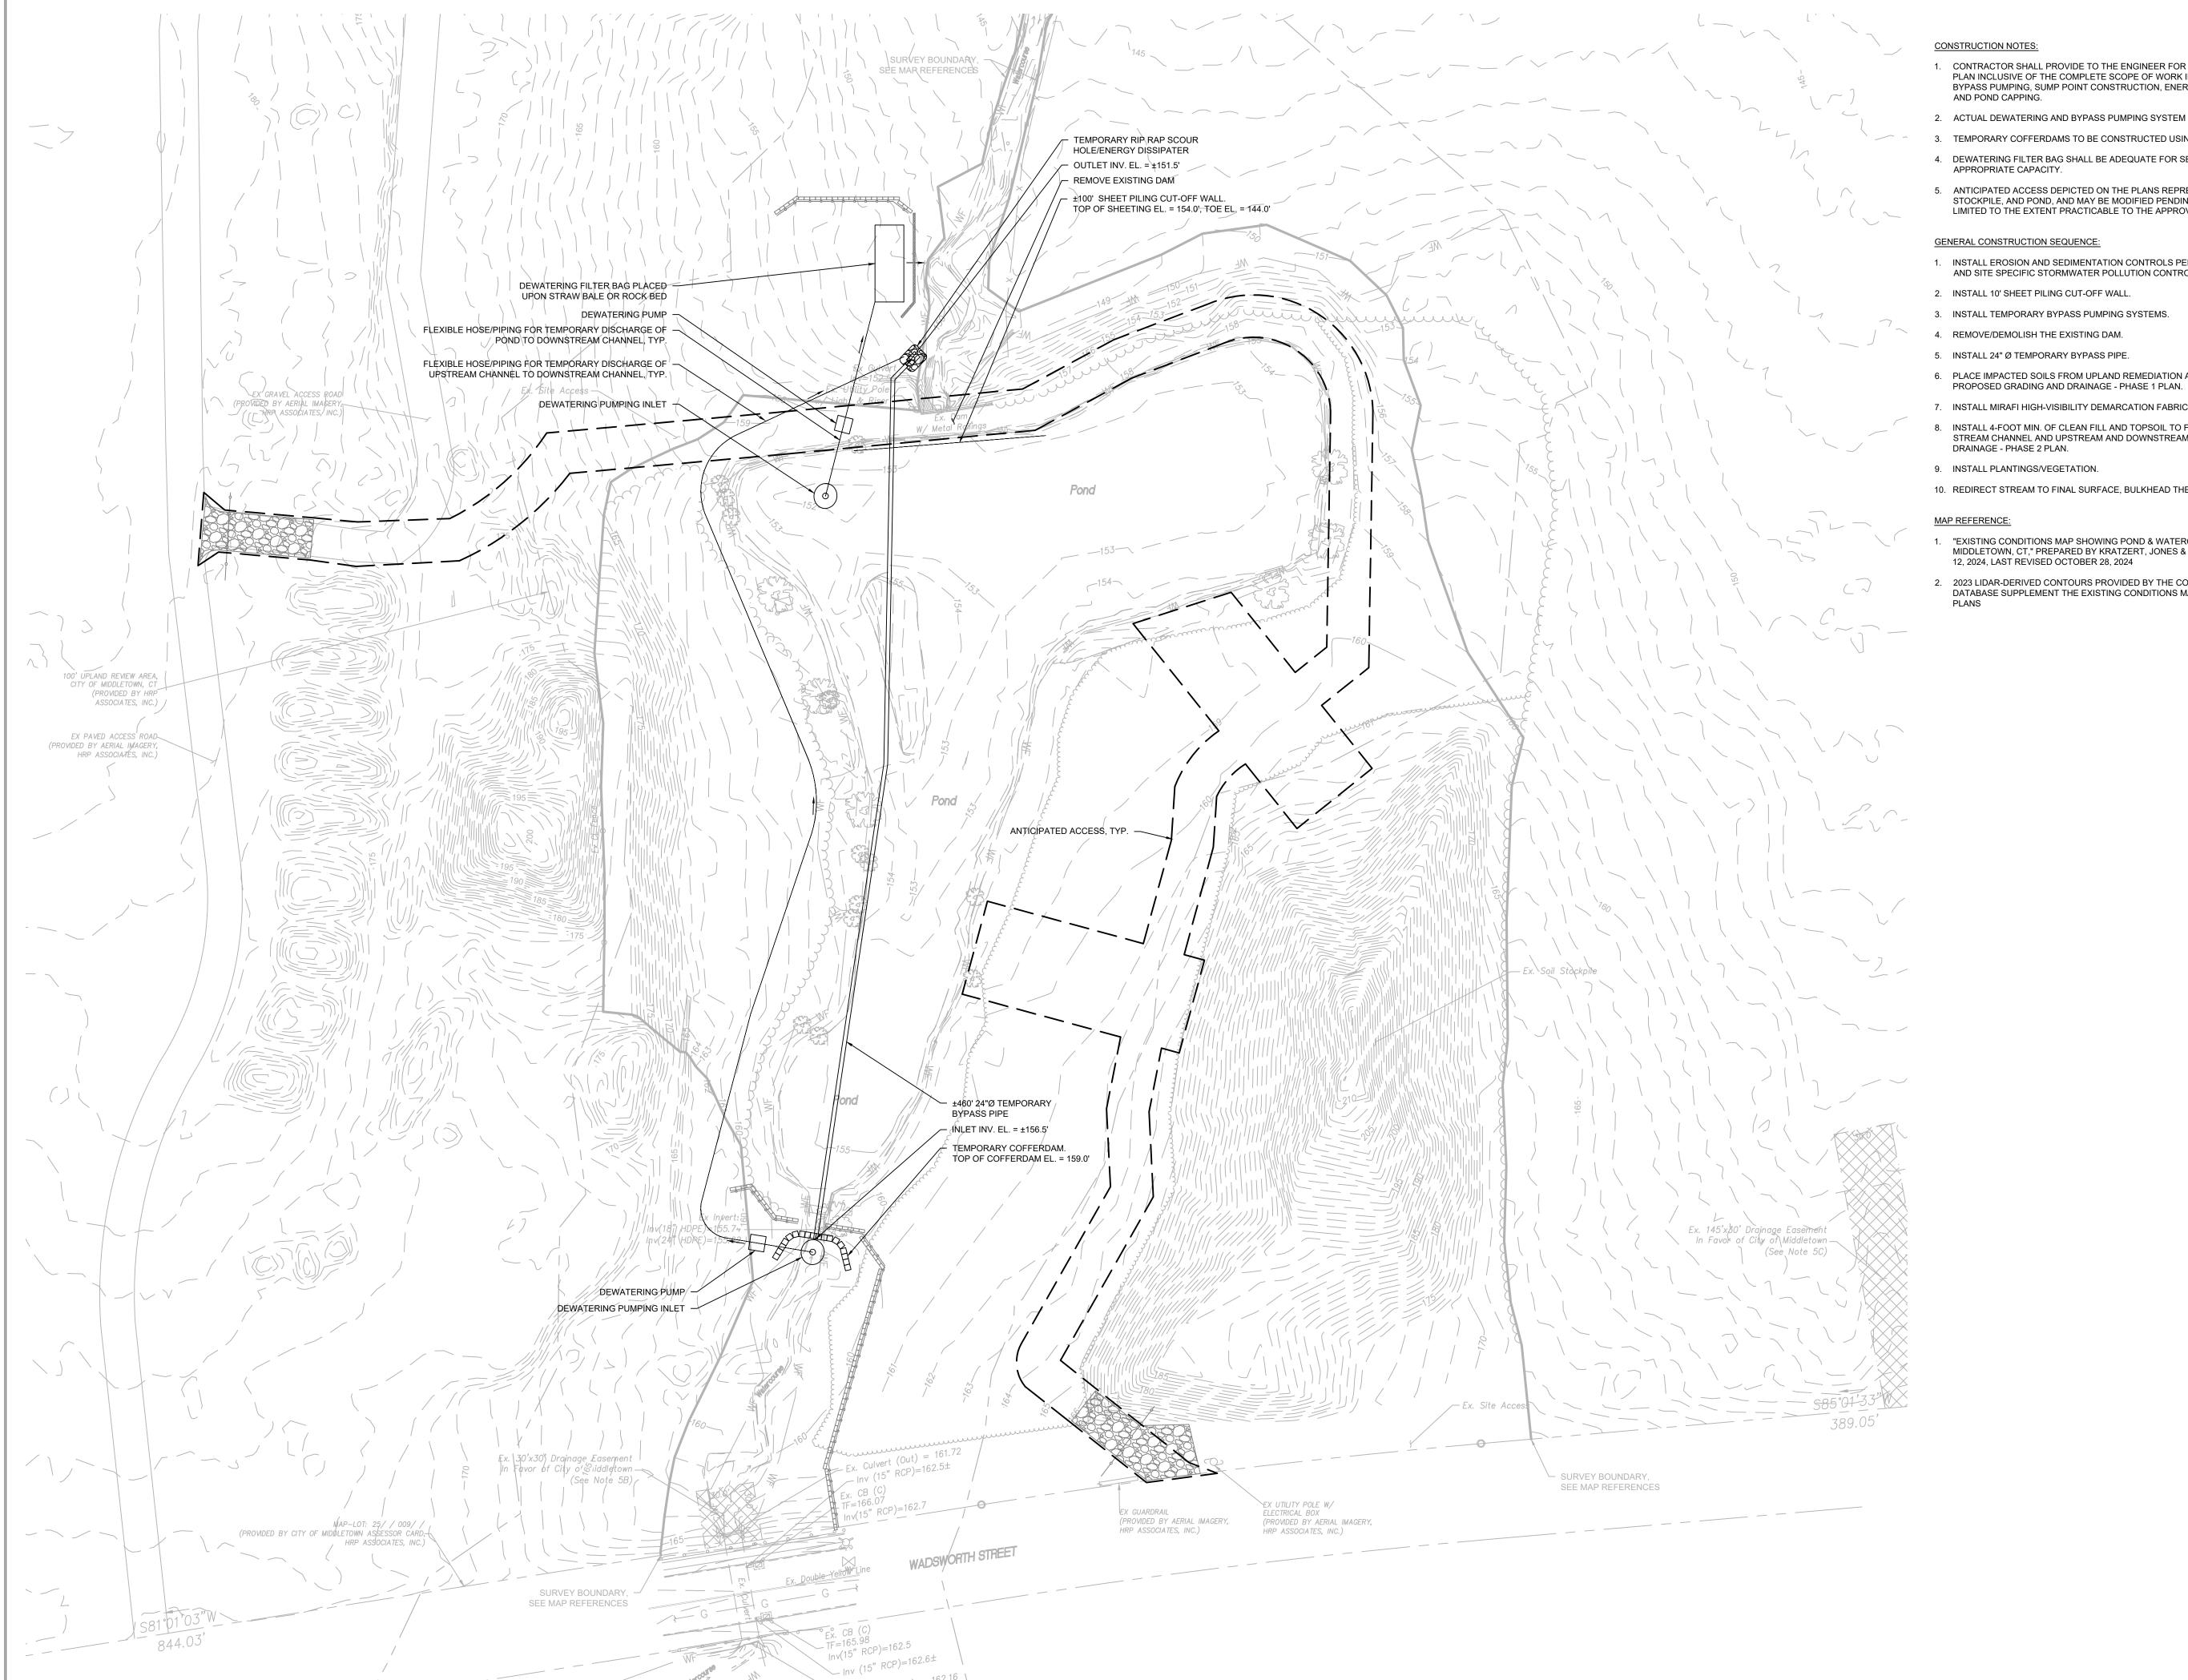

CONSTRUCTION NOTES:

- 1. CONTRACTOR SHALL PROVIDE TO THE ENGINEER FOR REVIEW AND APPROVAL A WRITTEN SEQUENCING PLAN INCLUSIVE OF THE COMPLETE SCOPE OF WORK INCLUDING BUT NOT LIMITED TO THE DEWATERING, BYPASS PUMPING, SUMP POINT CONSTRUCTION, ENERGY DISSIPATER, PIPE INSTALLATION, DAM REMOVAL, AND POND CAPPING.
- 2. ACTUAL DEWATERING AND BYPASS PUMPING SYSTEM SIZING TO BE DETERMINED BY THE CONTRACTOR.
- 3. TEMPORARY COFFERDAMS TO BE CONSTRUCTED USING 1 CY BAGS FILLED WITH CLEAN SOIL.
- 4. DEWATERING FILTER BAG SHALL BE ADEQUATE FOR SEDIMENT TREATMENT, ANTICIPATED FLOW RATES, AND APPROPRIATE CAPACITY.
- 5. ANTICIPATED ACCESS DEPICTED ON THE PLANS REPRESENTS APPROXIMATE ACCESS TO THE SITE, STOCKPILE, AND POND, AND MAY BE MODIFIED PENDING APPROVAL BY THE ENGINEER. CLEARING TO BE LIMITED TO THE EXTENT PRACTICABLE TO THE APPROVED ACCESS AREAS.

GENERAL CONSTRUCTION SEQUENCE:


- 1. INSTALL EROSION AND SEDIMENTATION CONTROLS PER THE EROSION AND SEDIMENTATION CONTROL PLAN AND SITE SPECIFIC STORMWATER POLLUTION CONTROL PLAN.
- 2. INSTALL 10' SHEET PILING CUT-OFF WALL.
- 3. INSTALL TEMPORARY BYPASS PUMPING SYSTEMS.
- 4. REMOVE/DEMOLISH THE EXISTING DAM.
- 5. INSTALL 24" Ø TEMPORARY BYPASS PIPE.
- 6. PLACE IMPACTED SOILS FROM UPLAND REMEDIATION AREAS AND REGRADE POND SEDIMENTS PER THE
- 7. INSTALL MIRAFI HIGH-VISIBILITY DEMARCATION FABRIC.
- 8. INSTALL 4-FOOT MIN. OF CLEAN FILL AND TOPSOIL TO FINISH GRADE, INCLUDING CONSTRUCTING PROPOSED STREAM CHANNEL AND UPSTREAM AND DOWNSTREAM REACHES, PER THE PROPOSED GRADING AND DRAINAGE - PHASE 2 PLAN.
- 9. INSTALL PLANTINGS/VEGETATION.
- 10. REDIRECT STREAM TO FINAL SURFACE, BULKHEAD THE TEMPORARY BYPASS PIPE IN PLACE.
- 1. "EXISTING CONDITIONS MAP SHOWING POND & WATERCOURSE AT WESLEYAN UNIVERSITY, 170 LONG LANE, MIDDLETOWN, CT," PREPARED BY KRATZERT, JONES & ASSOCIATES, INC., SCALE 1" = 50', DATED SEPTEMBER 12, 2024, LAST REVISED OCTOBER 28, 2024
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197 SCOTT SWAMP ROAD

FARMINGTON, CT 06032

(860) 674-9570

HRPASSOCIATES.COM




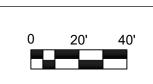


PROPOSED DAM REMOVAL RESTORATION WESLEYAN UNIVERSITY

SHEET NO.


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CONSTRUCTION NOTES:

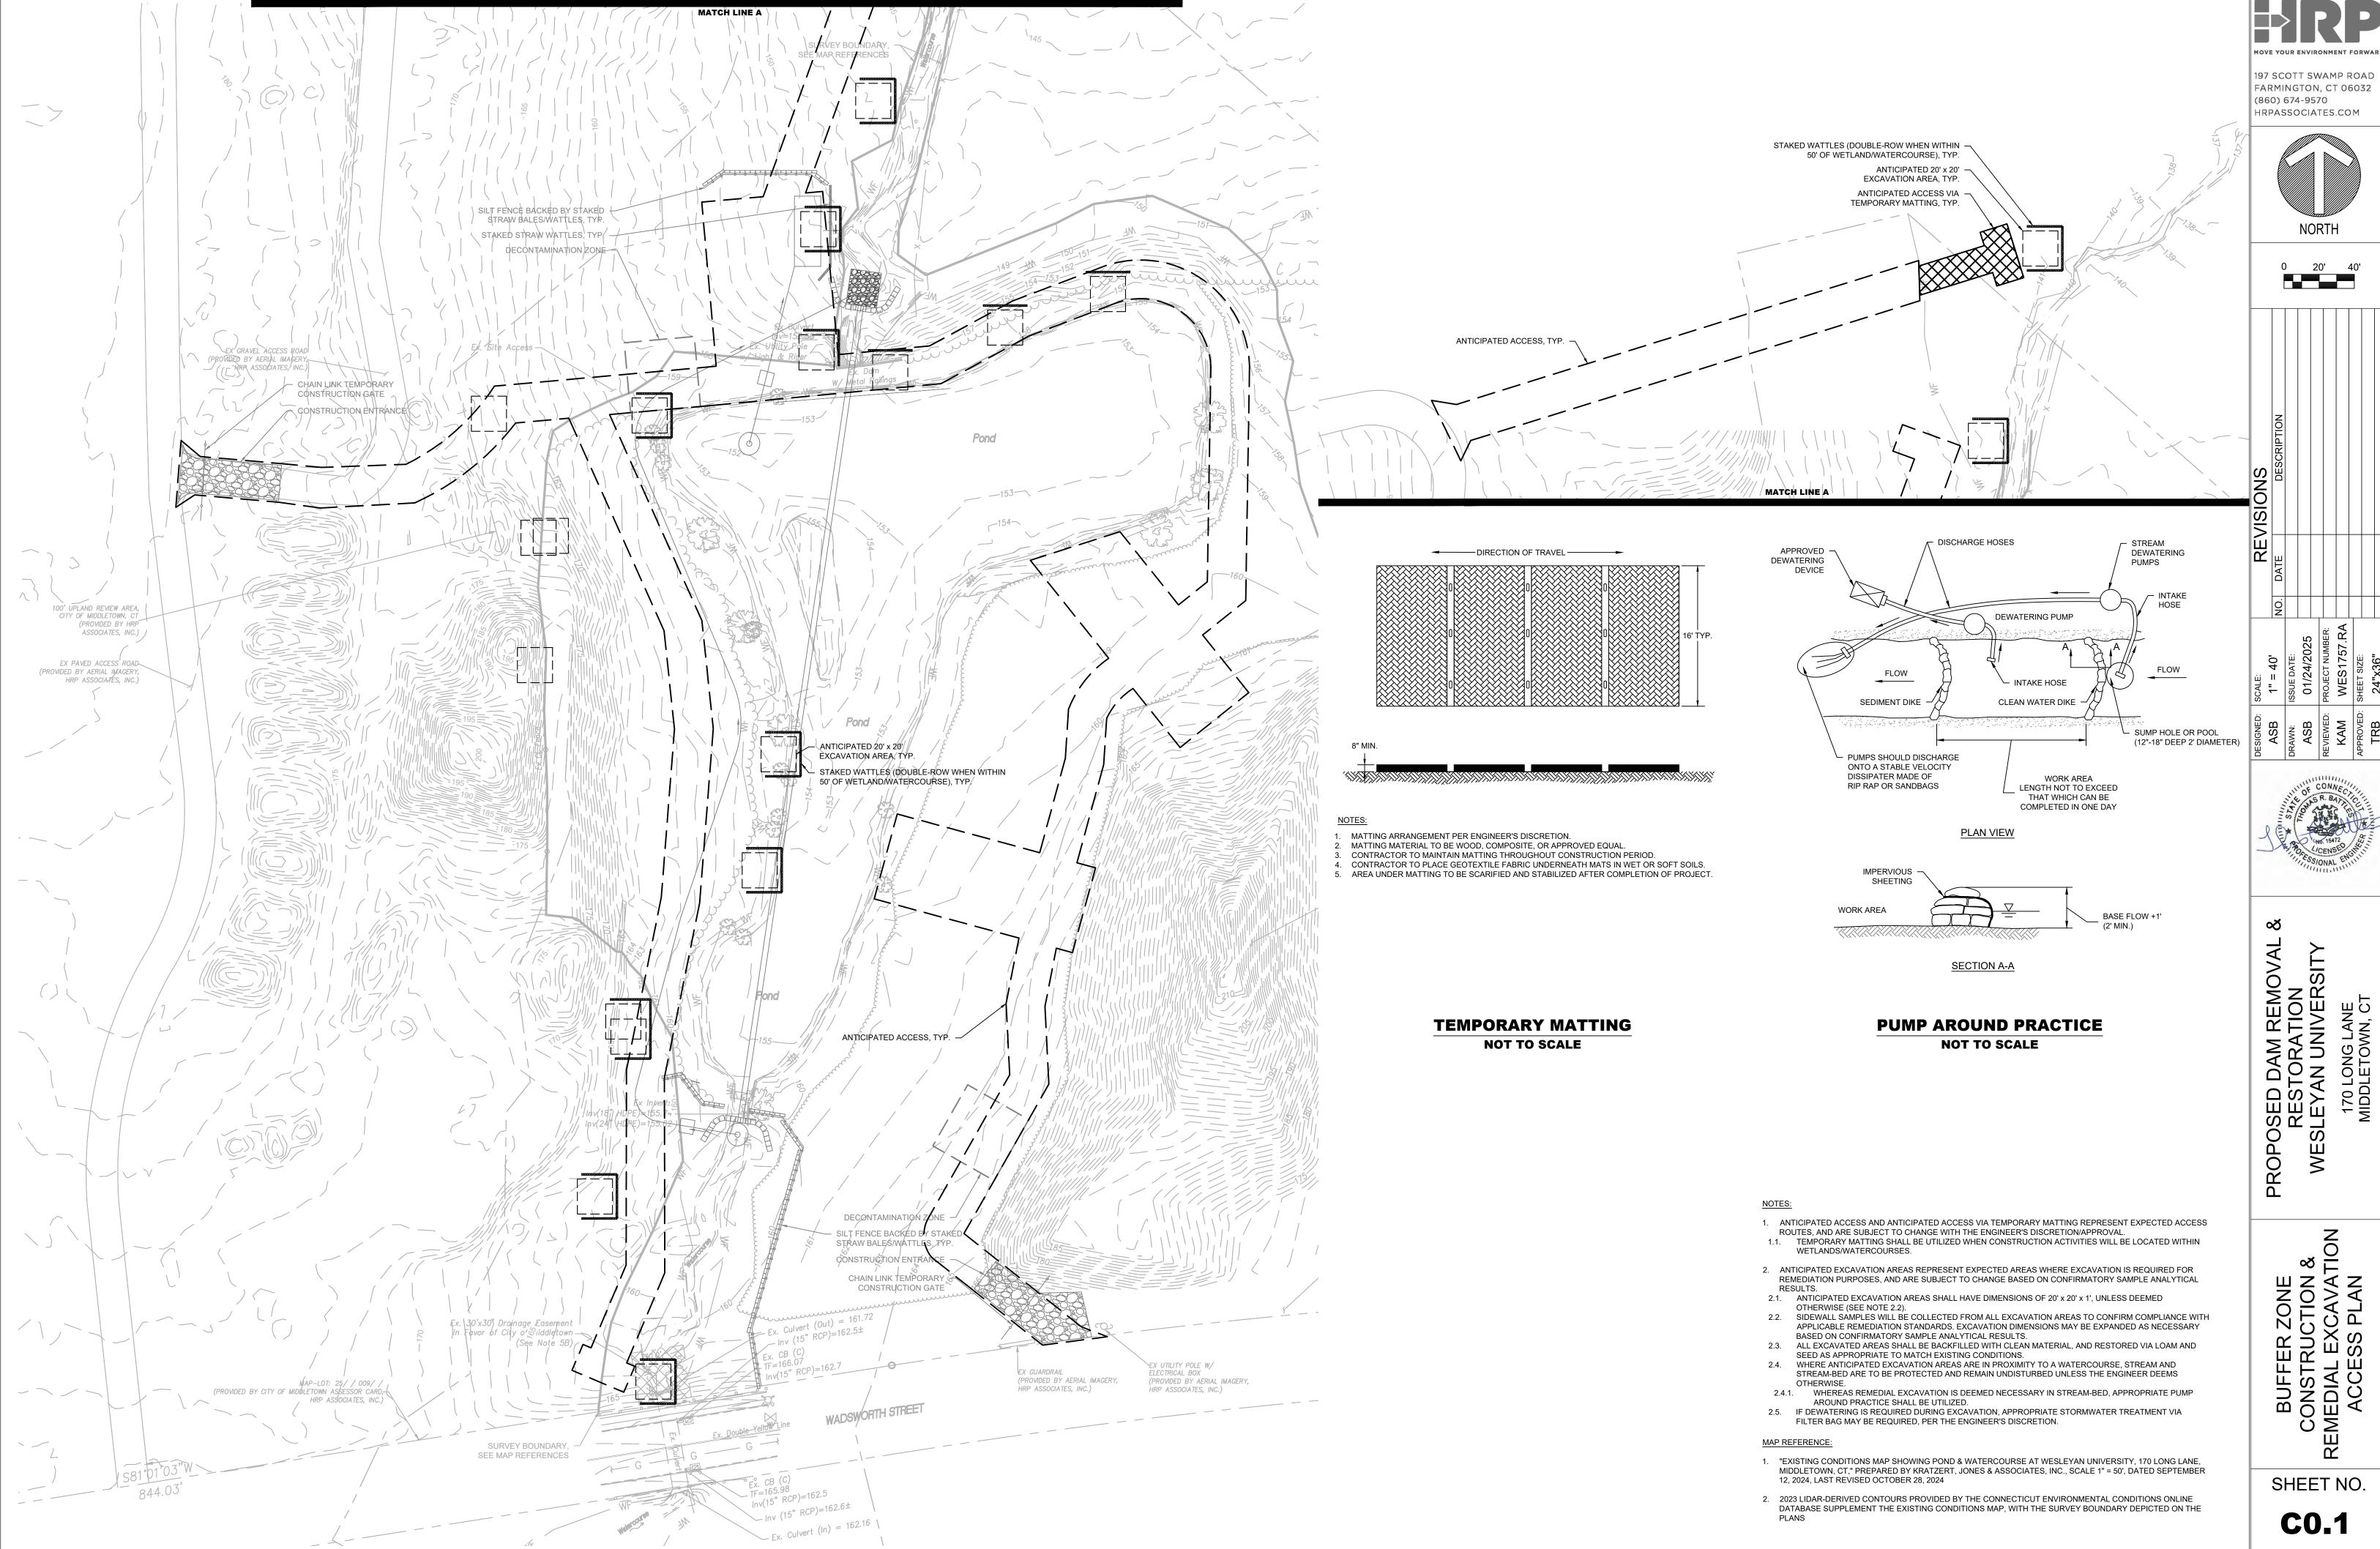
- 1. CONTRACTOR SHALL CLEAR WOODY DEBRIS FROM POND PRIOR TO GRADING, STOCKPILE TO DEWATER, AND DISPOSE OF OFF-SITE AT AN APPROPRIATELY PERMITTED FACILITY.
- 2. CONTRACTOR SHALL GRADE TO THE POND LIMITS AS DEPICTED TO PROVIDE THE NECESSARY GRADES FOR CONSTRUCTION OF THE CAP AND STREAM INCLUDED ON THE PROPOSED GRADING AND DRAINAGE PLAN -
- 3. HOTSPOT SPOILS AND POND SEDIMENTS REQUIRING RELOCATION SHALL BE PLACED WHERE FILL IS REQUIRED AS PER THE PROPOSED GRADING AND DRAINAGE PLAN PHASE 1.

- 1. "EXISTING CONDITIONS MAP SHOWING POND & WATERCOURSE AT WESLEYAN UNIVERSITY, 170 LONG LANE, MIDDLETOWN, CT," PREPARED BY KRATZERT, JONES & ASSOCIATES, INC., SCALE 1" = 50', DATED SEPTEMBER 12, 2024, LAST REVISED OCTOBER 28, 2024
- 2. 2023 LIDAR-DERIVED CONTOURS PROVIDED BY THE CONNECTICUT ENVIRONMENTAL CONDITIONS ONLINE DATABASE SUPPLEMENT THE EXISTING CONDITIONS MAP, WITH THE SURVEY BOUNDARY DEPICTED ON THE
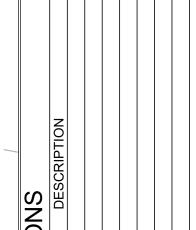
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HRPASSOCIATES.COM



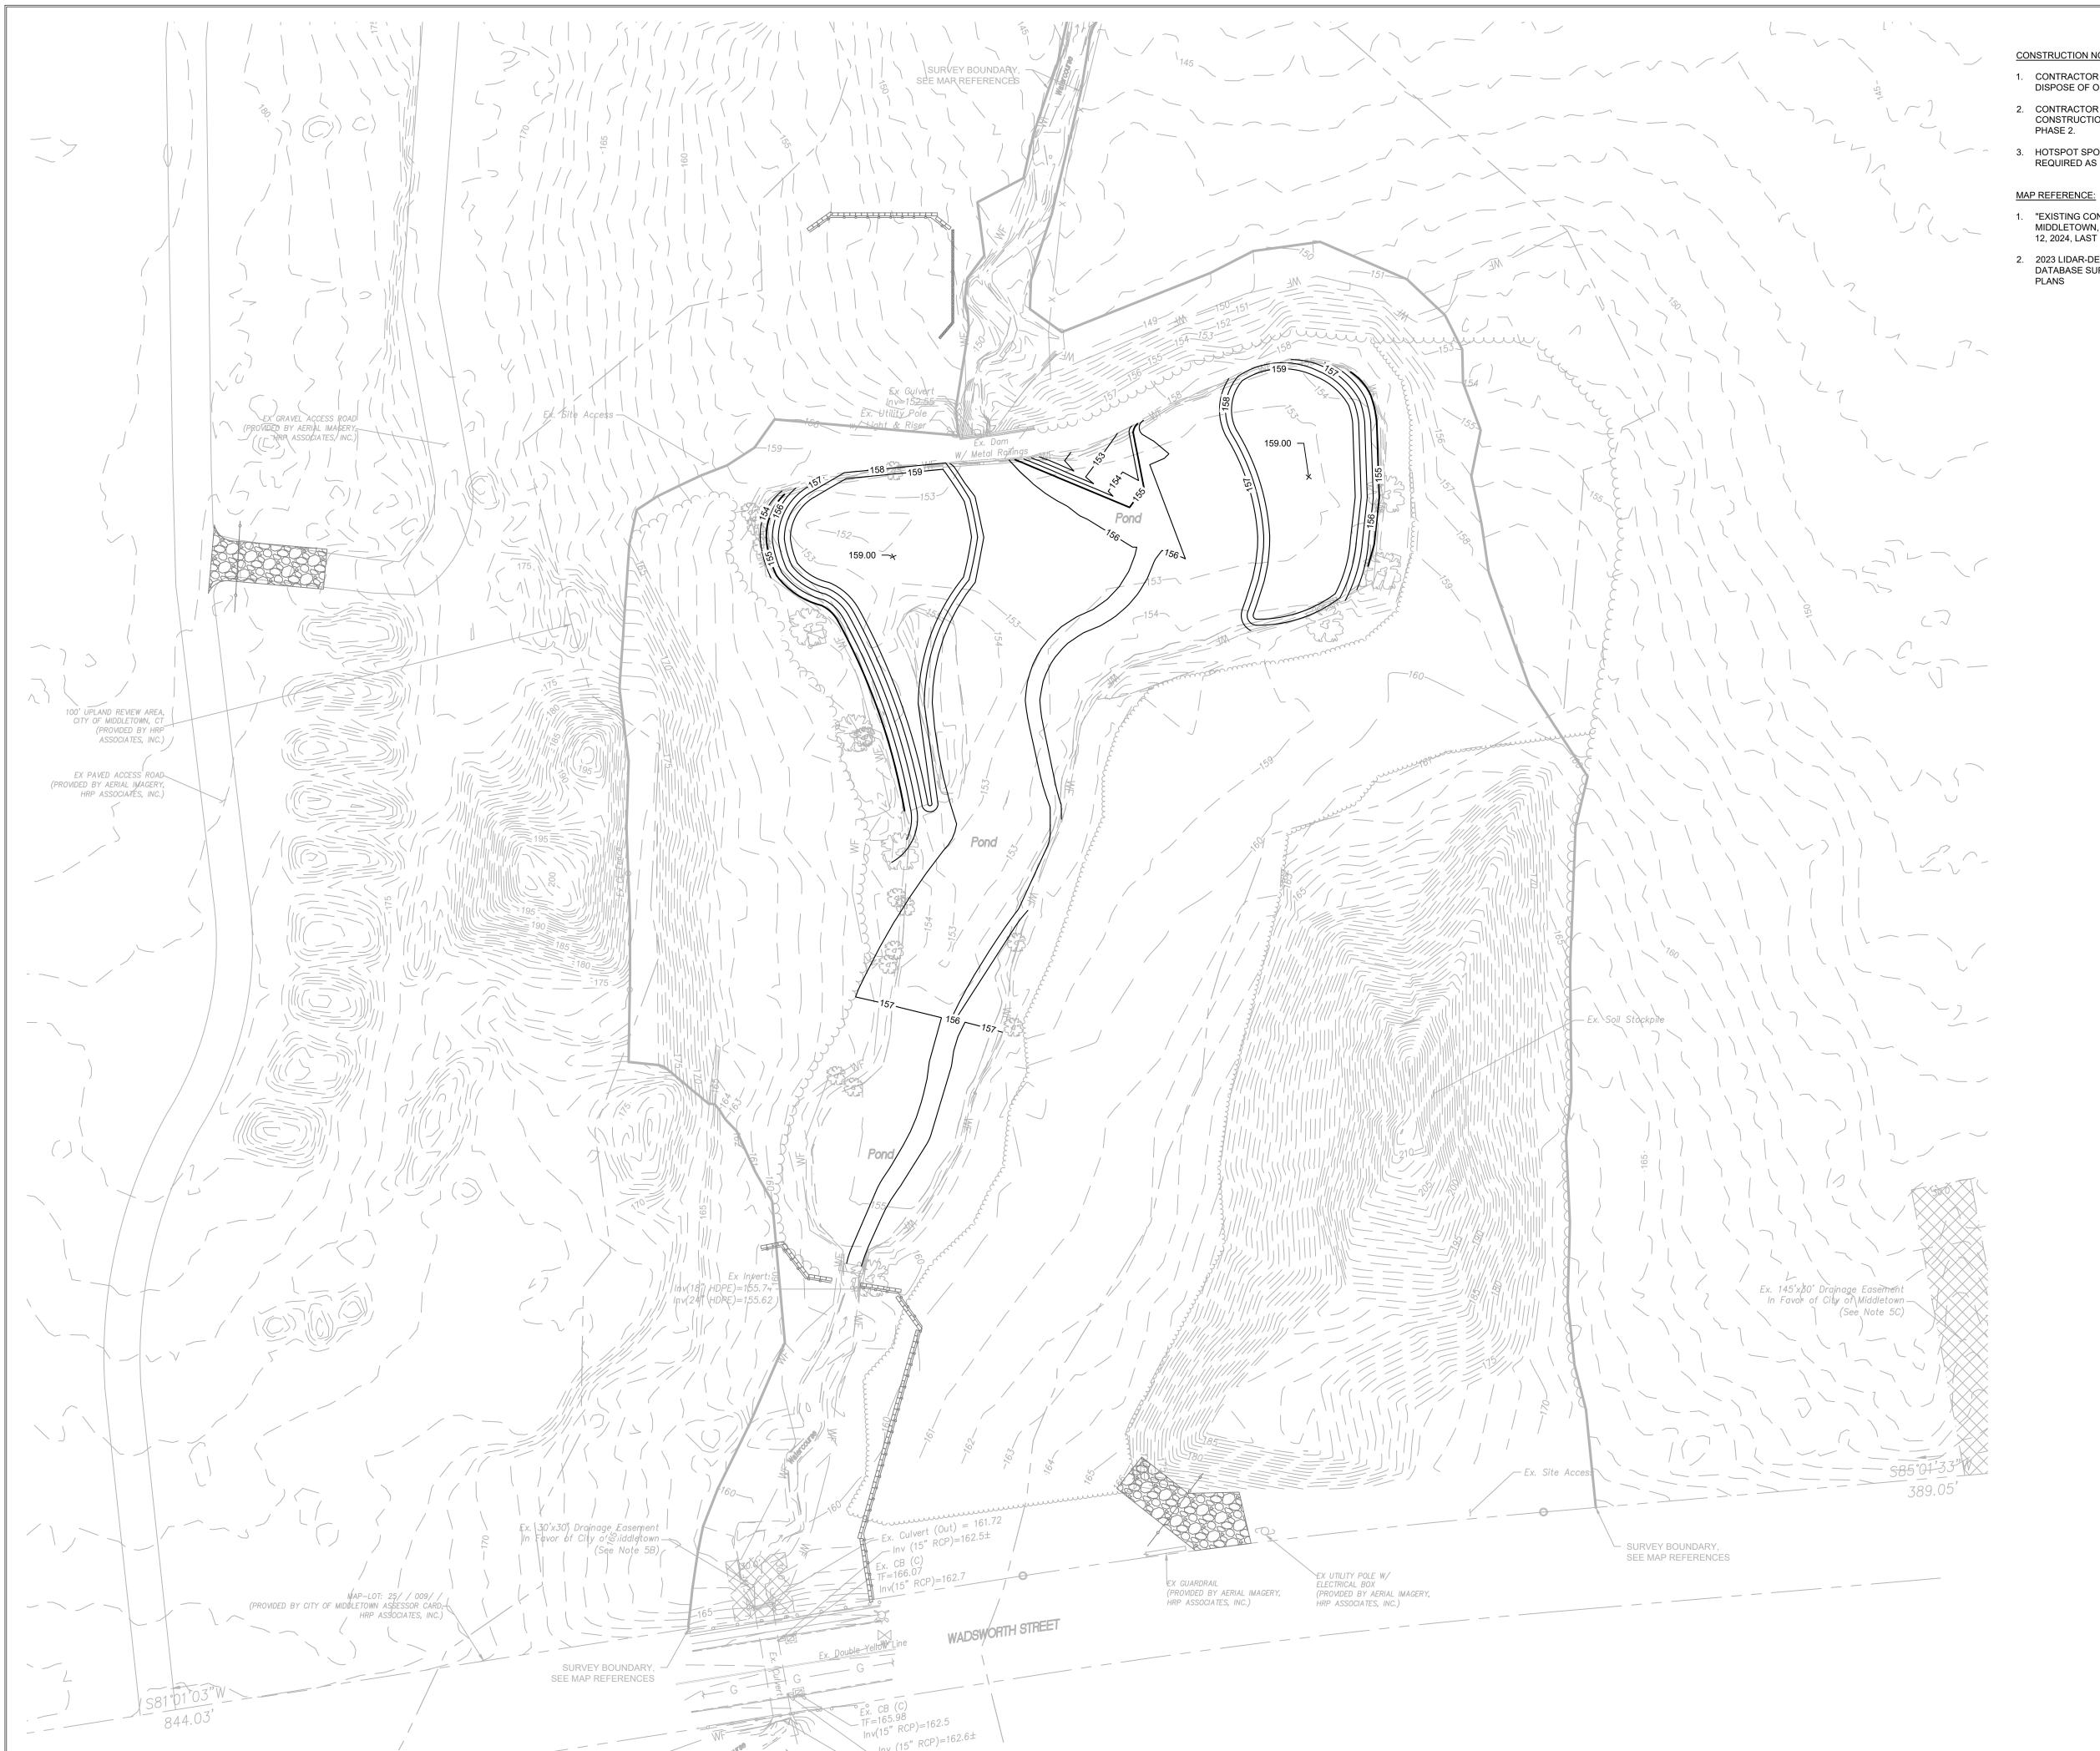


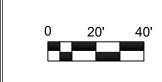PROPOSED DAM REMOVAL RESTORATION WESLEYAN UNIVERSITY

GRADING & DRAINAGE PHASE 1

SHEET NO.

C1.0

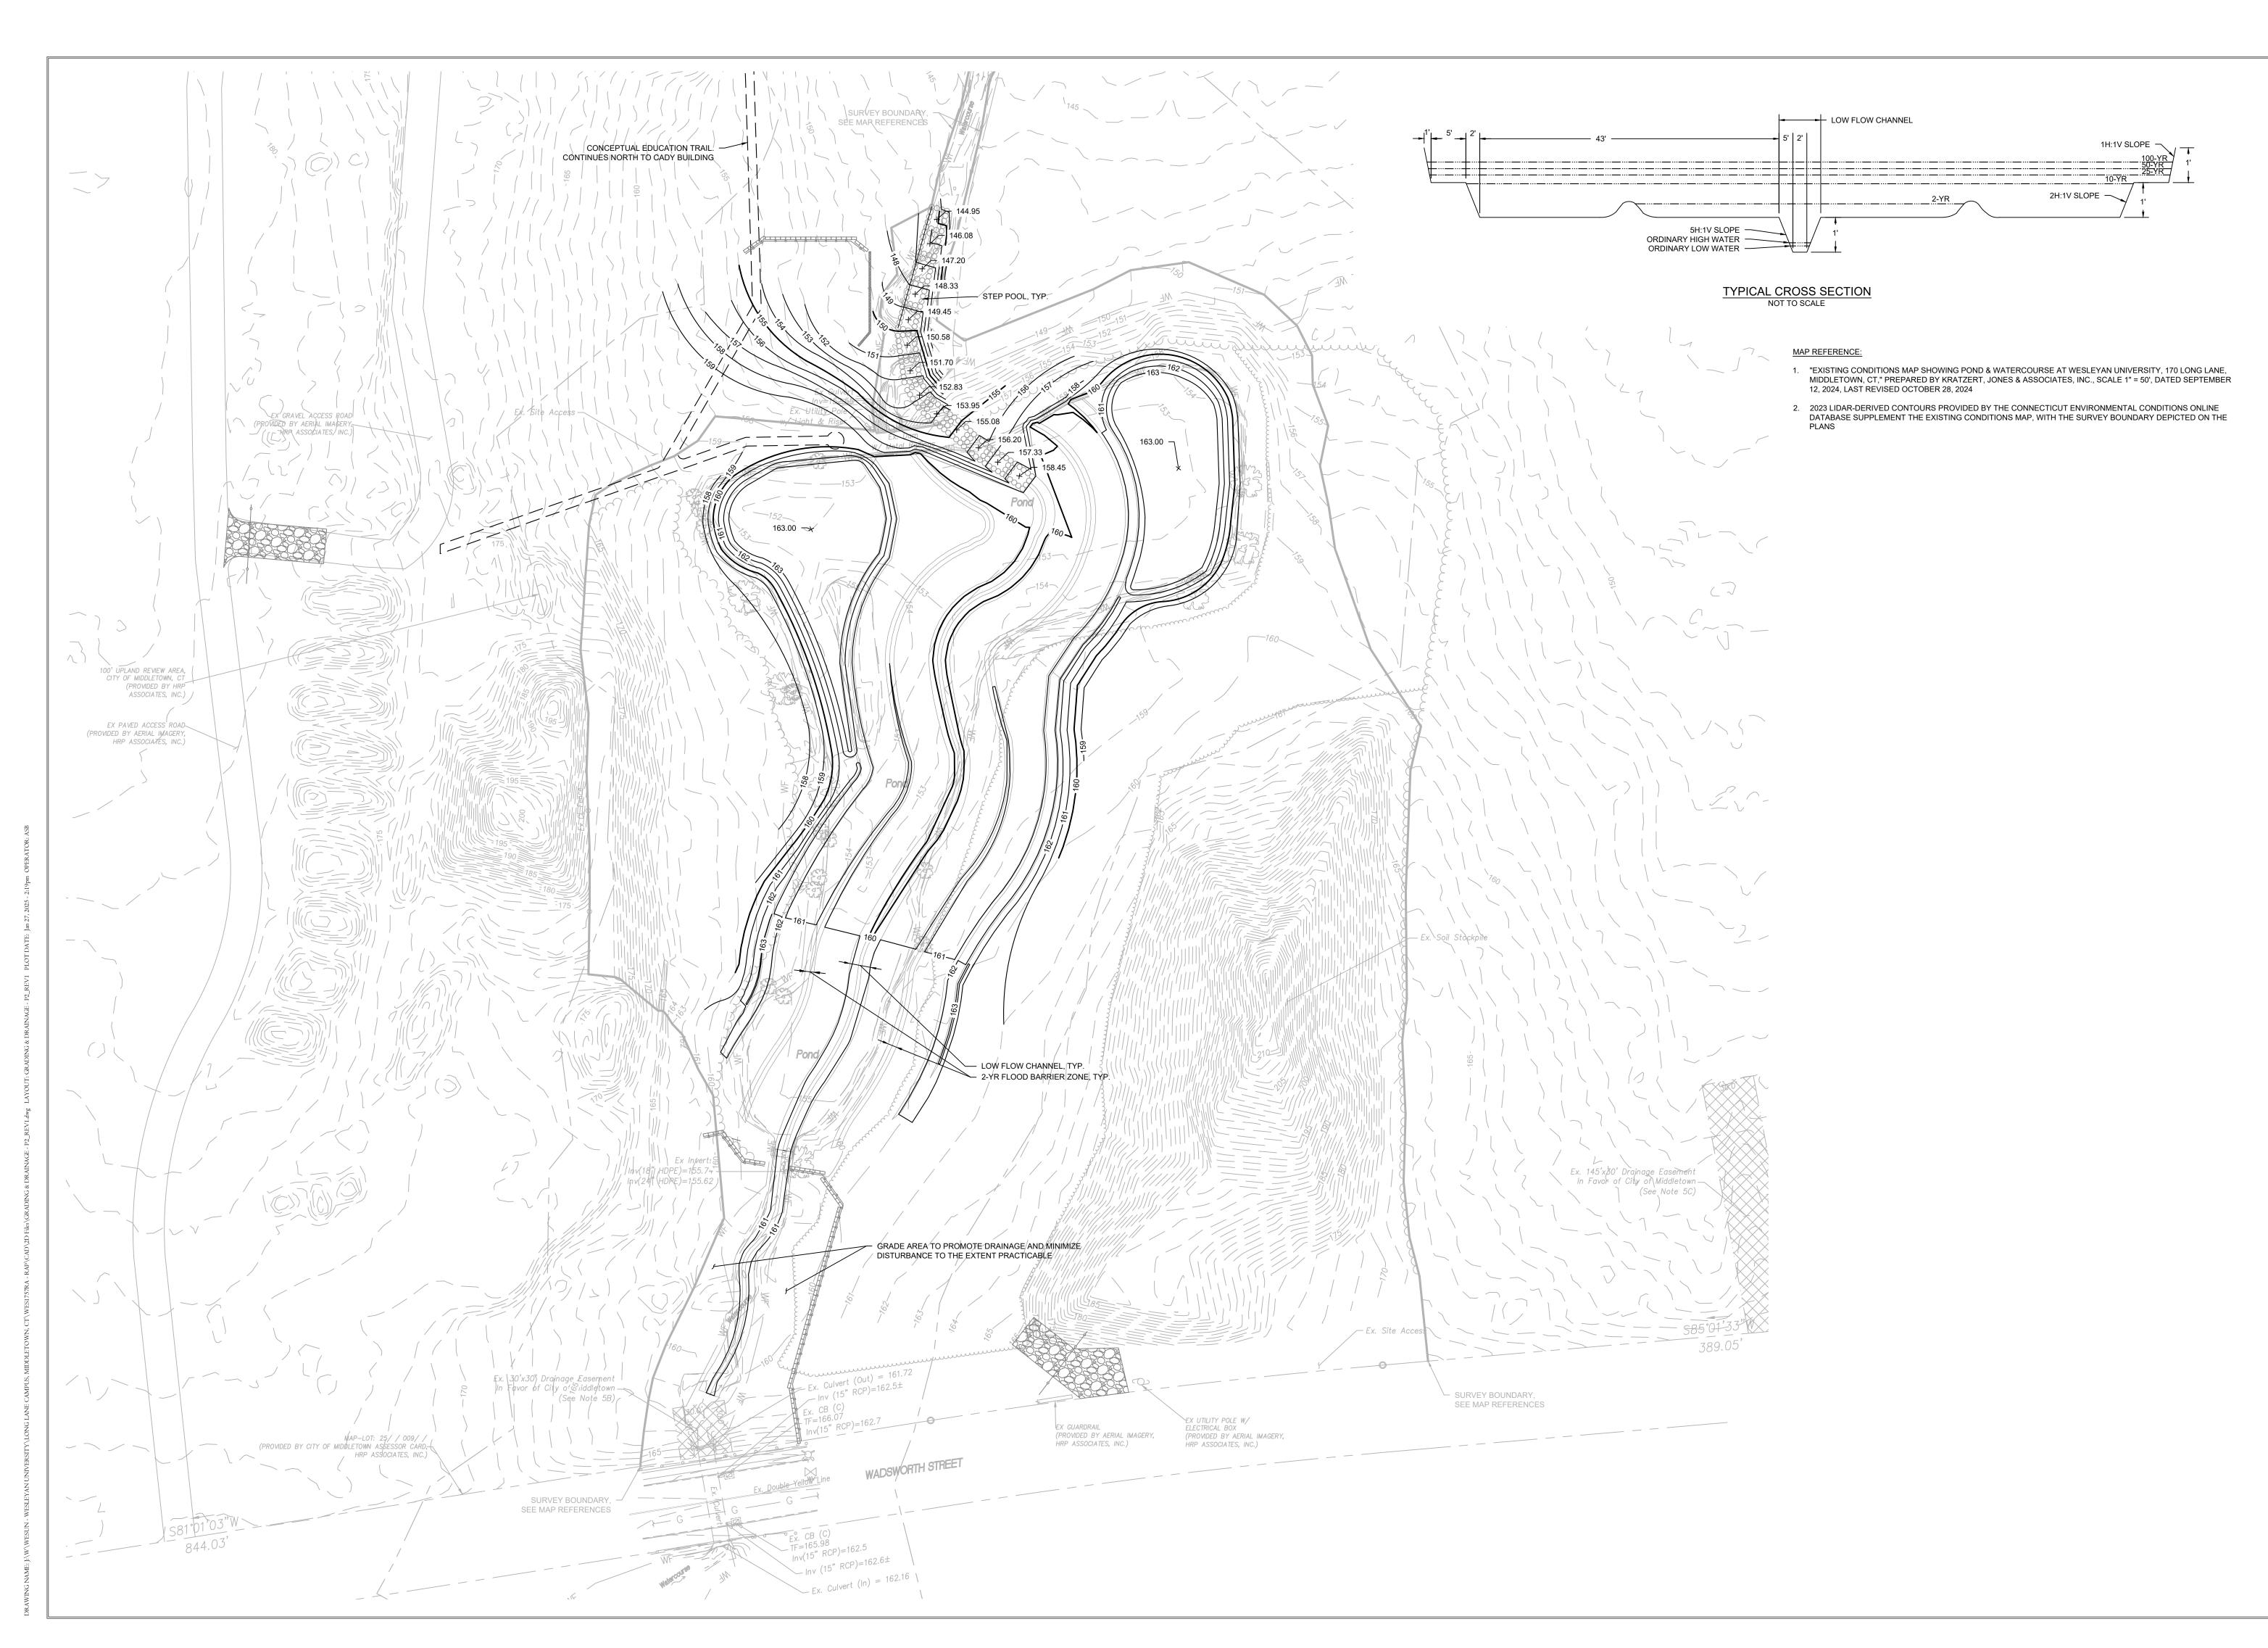

HRP

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0 20' 40'


CONNECTION OF CO

PROPOSED DAM REMOVAL RESTORATION WESLEYAN UNIVERSITY

> GRADING & DRAINAGE -PHASE 2

SHEET NO.

C1.1

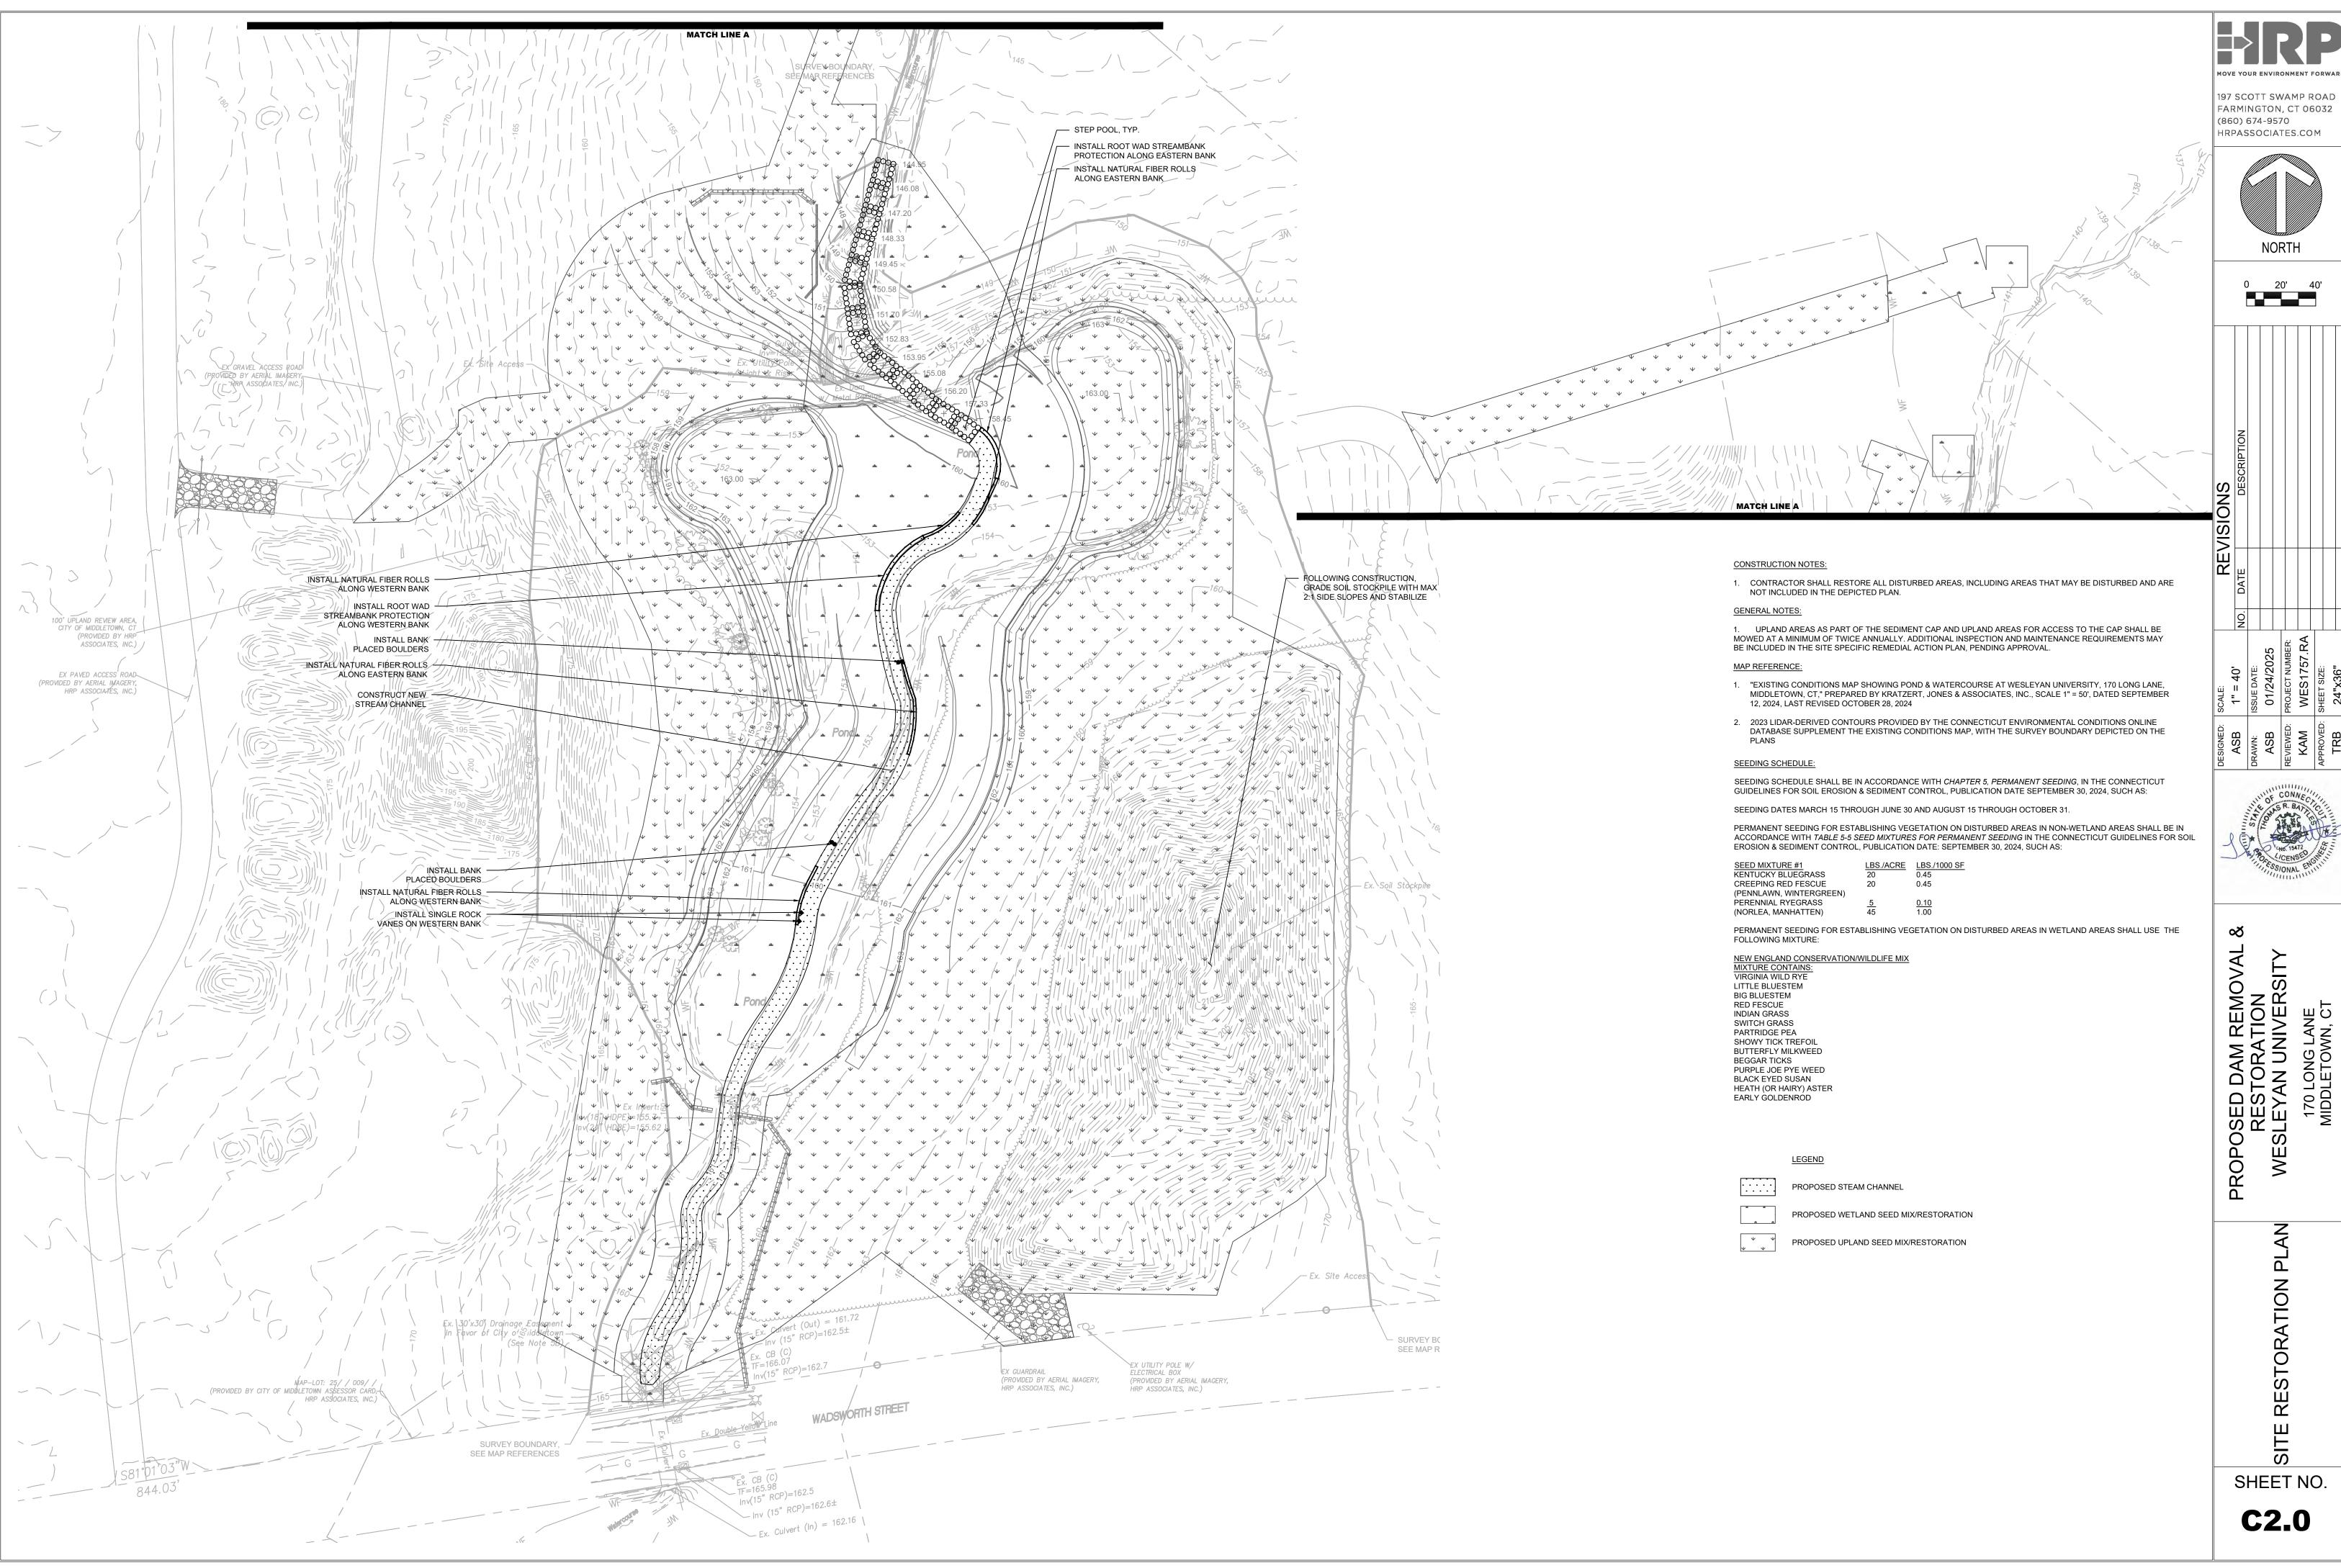







NOTES

 THE PAD SHOULD BE CONSTRUCTED IN AN AREA KNOWN OR BELIEVED TO BE FREE OF SURFACE CONTAMINATION


EQUIPMENT DECONTAMINATION PAD NOT TO SCALE

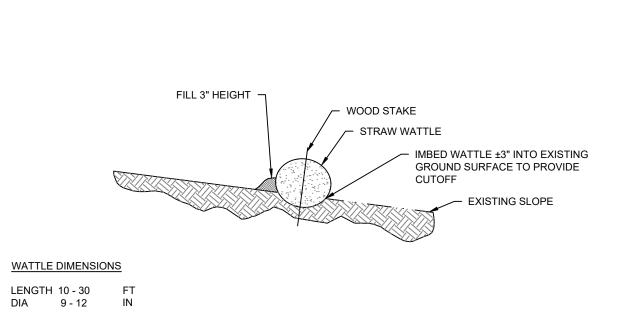


TYPICAL STRAW WATTLE NOT TO SCALE

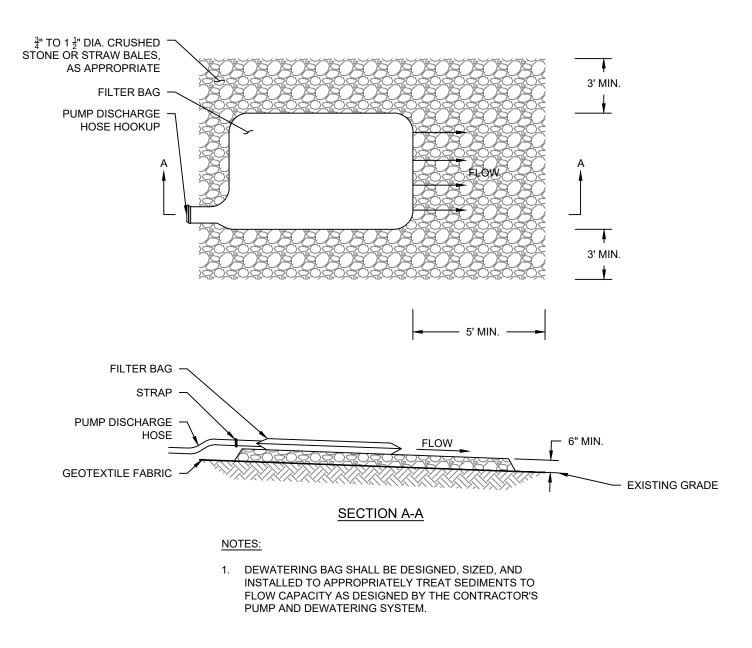

DEWATERING BAG NOT TO SCALE

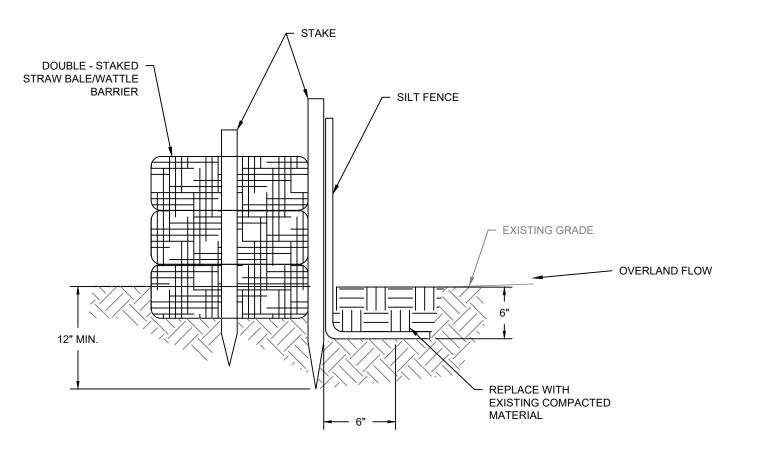


SILT FENCE BACKED BY STAKED STRAW BALES/WATTLES
NOT TO SCALE

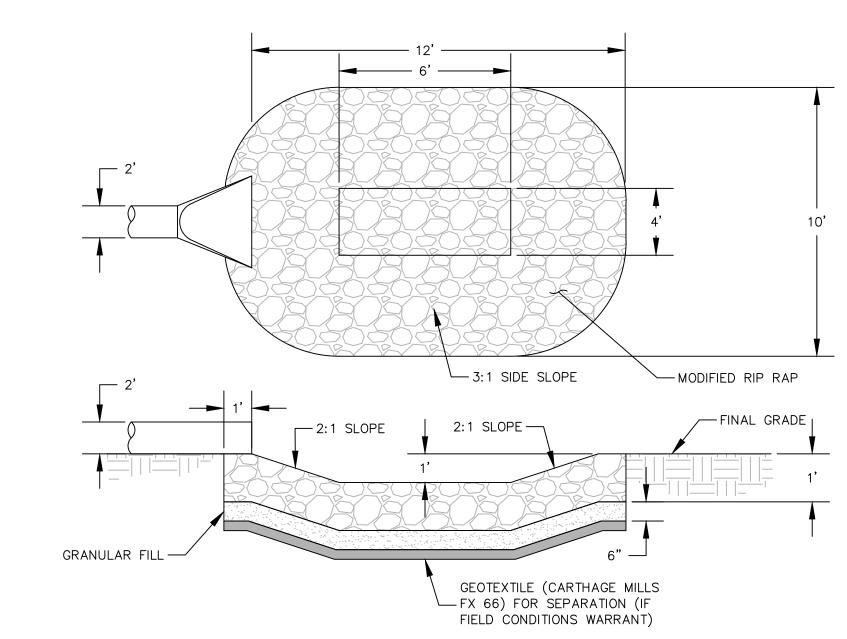

NOTES

- SCOUR HOLE DESIGN AND INSTALLATION AS SPECIFIED BY SECTION 11.13 OF THE CONNECTICUT DEPARTMENT OF TRANSPORTATION DRAINAGE MANUAL, MAY 2002.
- 2. RIP RAP TO CONSIST AS MODIFIED RIP RAP AS SPECIFIED BY SECTION M.12.02 OF THE STATE OF CONNECTICUT DEPARTMENT OF TRANSPORTATION STANDARD SPECIFICATIONS FOR ROADS, BRIDGES, FACILITIES AND INCIDENTAL CONSTRUCTION FORM 819, 2024.

PREFORMED SCOUR HOLE NOT TO SCALE

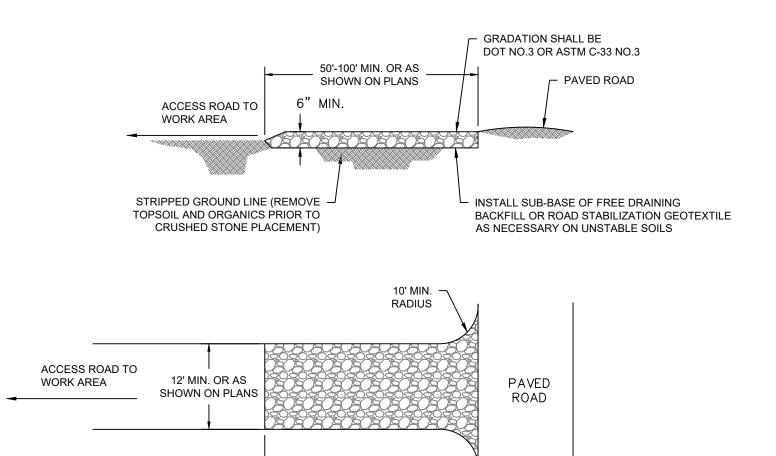


CONSTRUCTION ENTRANCE PAD
NOT TO SCALE

50'-100' MIN. OR AS SHOWN ON PLANS MOVE YOUR ENVIRONMENT FORWARD

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SCRIPTION



PROPOSED DAM REMOVAL
RESTORATION
WESLEYAN UNIVERSITY

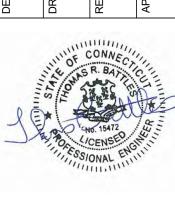
ETAILS

SHEET NO.


D1.0

STEP POOLS SHALL BE CONSTRUCTED TO THE FOLLOWING APPROXIMATE DIMENSIONS;
 L = 15'
 H = 1.15'

PREFORMED SCOUR HOLE NOT TO SCALE

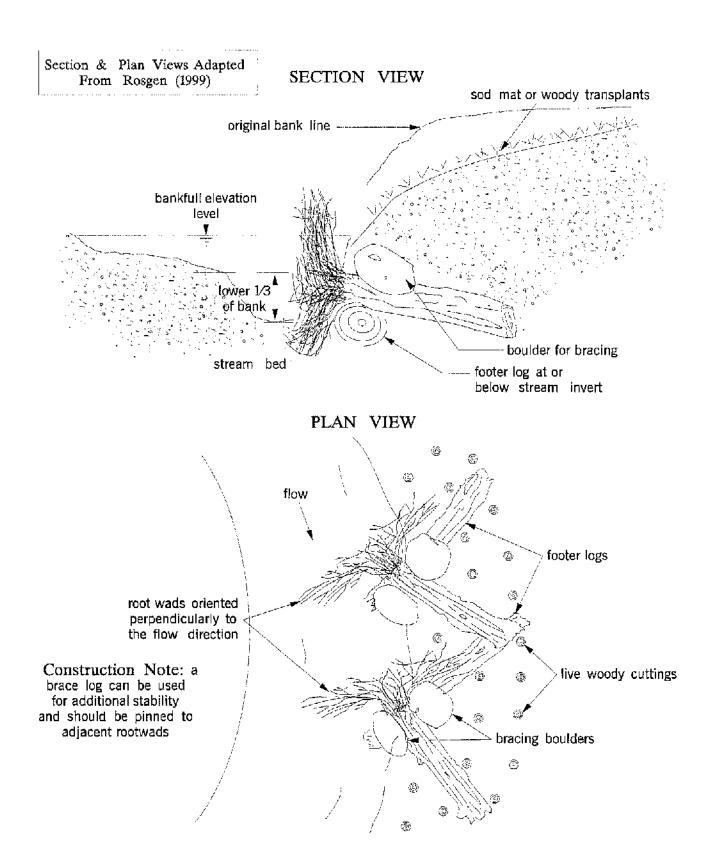


ROOT WAD REVETMENT NOT TO SCALE

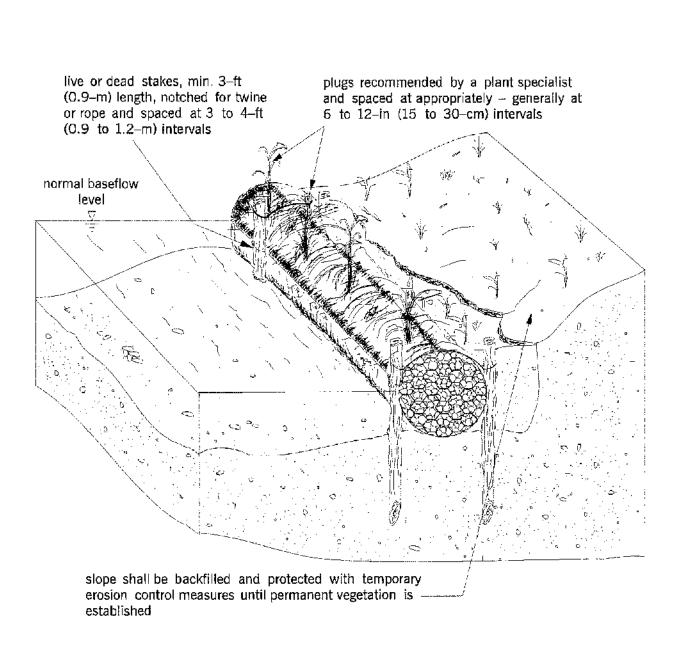


NOTE: PLUGS SHALL BE SALIX NIGRA.


NATURAL FIBER ROLLS NOT TO SCALE

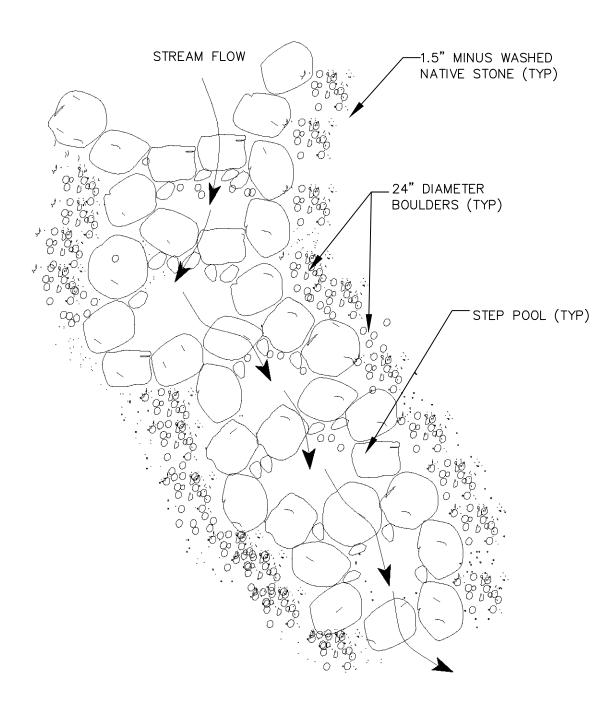

STEP POOL PLAN NOT TO SCALE

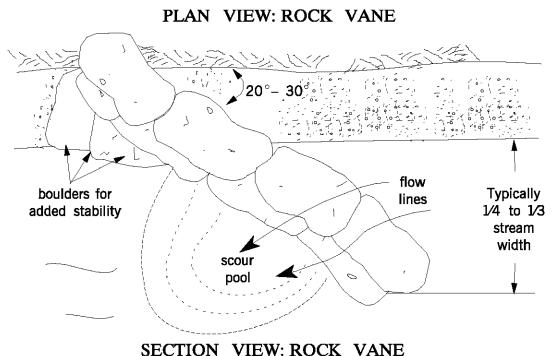

SECTION VIEW: ROCK VANE

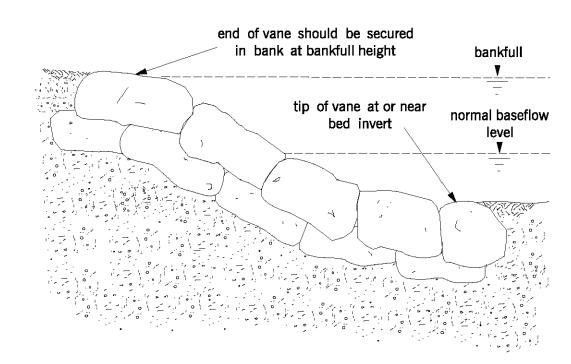

ROCK VANES NOT TO SCALE

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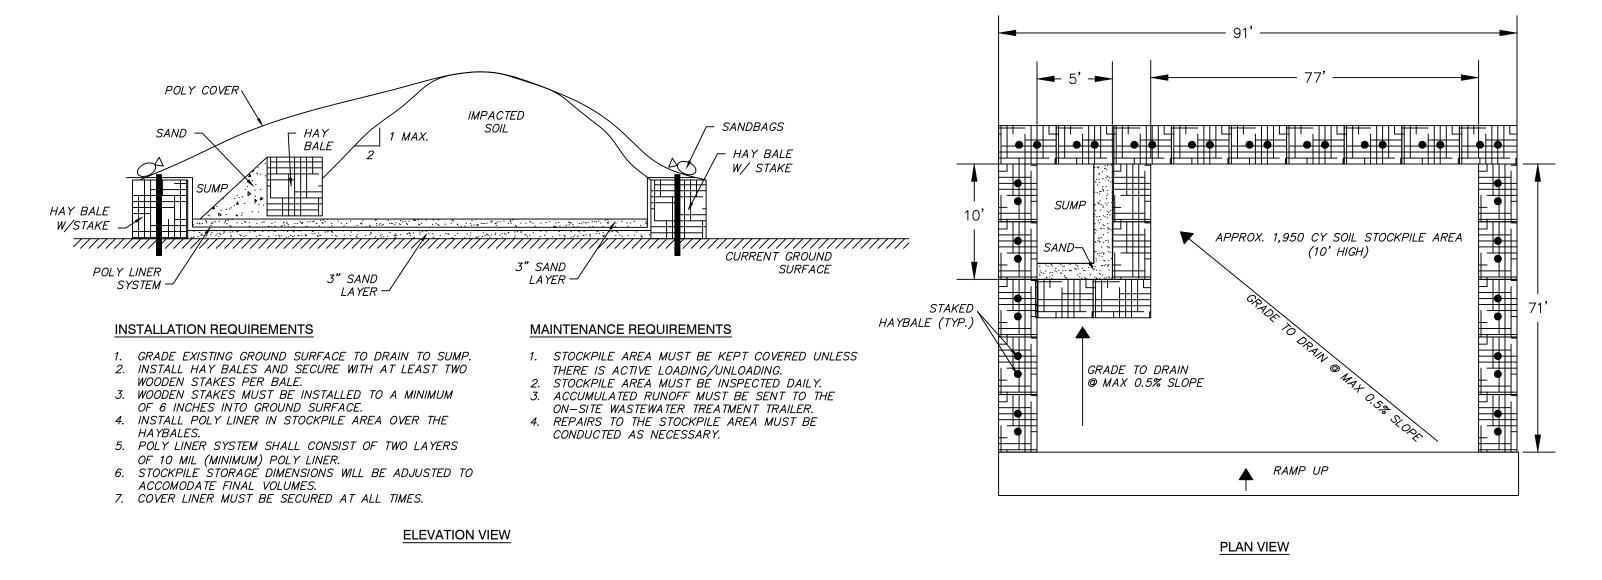
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PROPOSED DAM REMOVAL RESTORATION WESLEYAN UNIVERSITY


SHEET NO.


D1.1

CHAIN LINK TEMPORARY CONSTRUCTION GATE NOT TO SCALE



STOCKPILE STORAGE
NOT TO SCALE

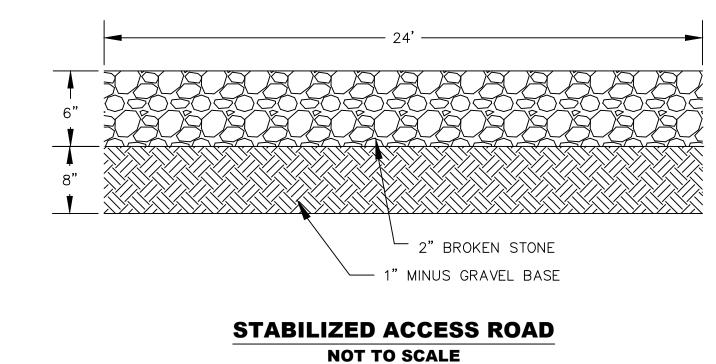

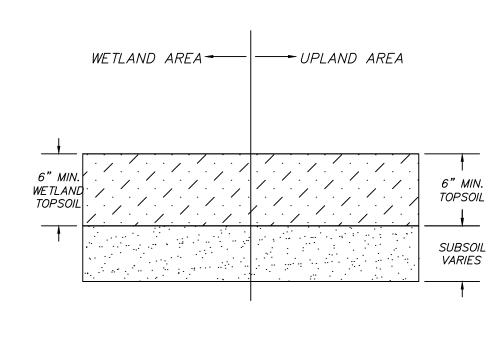

RESTORATION NOT TO SCALE

MOVE YOUR ENVIRONMENT FORWARD

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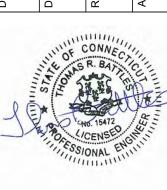
 SCALE:
 REVISIONS

 AS NOTED
 NO. DATE
 DESCRIPTION

 ISSUE DATE:
 12/13/2024
 DESCRIPTION

 PROJECT NUMBER:
 WES1757.RA
 SHEET SIZE:

 SHEET SIZE:
 24"x36"



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PROPOSED DAM REMOVAL
RESTORATION
WESLEYAN UNIVERSITY

DETAILS

SHEET NO.

D1.2