



**US Army Corps
of Engineers®
New England District**

696 Virginia Road
Concord, MA 01742-2751

PUBLIC NOTICE

Date: December 21, 2007

Comment Period Ends: January 21, 2008

File Number: NAE-2006-2242

In Reply Refer To: John Sargent

Or by e-mail: John.C.Sargent@usace.army.mil

The District Engineer has received a permit application from the applicant below to **conduct work in waters of the United States** as described below. The Corps is soliciting comments on both the project itself and the range of issues to be addressed in the environmental documentation.

APPLICANT

City of North Adams Airport Commission
Attn: Alfred Dougherty
10 Main Street
North Adams, Massachusetts 01247

ACTIVITY

Construction of a runway safety area, culvert replacements, and reconstruction of runway and taxiways. A detailed description and plans of the applicant's activity are attached.

WATERWAY AND LOCATION OF THE PROPOSED WORK

This work is proposed in Paull Brook and Tributaries and associated wetlands in the Hoosic River drainage at Harriman and West Airport, State Road, North Adams and Williamstown, Massachusetts. The proposed location on the USGS North Adams quadrangle sheet is at UTM coordinates 4728538 N and 649507 E.

AUTHORITY

Permits are required pursuant to:

- Section 10 of the Rivers and Harbors Act of 1899
 Section 404 of the Clean Water Act
 Section 103 of the Marine Protection, Research and Sanctuaries Act.

The decision whether to issue a permit will be based on an evaluation of the probable impact of the proposed activity on the public interest. That decision will reflect the national concern for both protection and utilization of important resources. The benefit which may reasonably accrue from the proposal must be balanced against its reasonably foreseeable detriments. All factors which may be relevant to the proposal will be considered, including the cumulative effects thereof; among those are: conservation, economics, aesthetics, general environmental concerns, wetlands, cultural value, fish and wildlife values, flood hazards, flood plain value, land use, navigation, shoreline erosion and accretion, recreation, water supply and conservation, water quality, energy needs, safety, food production and, in general, the needs and welfare of the people.

CENAE-R
FILE NO. NAE-2006-2242

The Corps of Engineers is soliciting comments from the public; Federal, state, and local agencies and officials; Indian Tribes; and other interested parties in order to consider and evaluate the impacts of this proposed activity. Any comments received will be considered by the Corps of Engineers to determine whether to issue, modify, condition or deny a permit for this proposal. To make this decision, comments are used to assess impacts on endangered species, historic properties, water quality, general environmental effects, and the other public interest factors listed above. Comments are used in the preparation of an Environmental Assessment and/or an Environmental Impact Statement pursuant to the National Environmental Policy Act. Comments are also used to determine the need for a public hearing and to determine the overall public interest of the proposed activity.

Where the activity involves the discharge of dredged or fill material into waters of the United States or the transportation of dredged material for the purpose of disposing it in ocean waters, the evaluation of the impact of the activity in the public interest will also include application of the guidelines promulgated by the Administrator, U.S Environmental Protection Agency, under authority of Section 404(b) of the Clean Water Act, and/or Section 103 of the Marine Protection Research and Sanctuaries Act of 1972 as amended.

SECTION 106 COORDINATION

Based on his initial review, the District Engineer has determined that little likelihood exists for the proposed work to impinge upon properties with cultural or Native American significance, or listed in, or eligible for listing in, the National Register of Historic Places. Therefore, no further consideration of the requirements of Section 106 of the National Historic Preservation Act of 1966, as amended, is necessary. This determination is based upon one or more of the following:

- a. The permit area has been extensively modified by previous work.
- b. The permit area has been recently created.
- c. The proposed activity is of limited nature and scope.
- d. Review of the latest published version of the National Register shows that no presence of registered properties listed as being eligible for inclusion therein are in the permit area or general vicinity.
- e. Coordination with the State Historic Preservation Officer and/or Tribal Historic Preservation Officer(s)

The following authorizations have been applied for, or have been, or will be obtained:

- Permit, License or Assent from State.
- Permit from Local Wetland Agency or Conservation Commission.
- Water Quality Certification in accordance with Section 401 of the Clean Water Act.

In order to properly evaluate the proposal, we are seeking public comment. Anyone wishing to comment is encouraged to do so. **Comments should be submitted in writing by the above date.** If you have any questions, please contact John Sargent at (978) 318-8026, (800) 343-4789 or (800) 362-4367, if calling from within Massachusetts.

Any person may request, in writing, within the comment period specified in this notice, that a public hearing be held to consider the application. Requests for a public hearing shall specifically state the reasons for holding a public hearing. The Corps holds public hearings for the purpose of obtaining public comments when that is the best means for understanding a wide variety of concerns from a diverse segment of the public.

CENAE-R

FILE NO. NAE-2006-2242

The initial determinations made herein will be reviewed in light of facts submitted in response to this notice. All comments will be considered a matter of public record. Copies of letters of objection will be forwarded to the applicant who will normally be requested to contact objectors directly in an effort to reach an understanding.

For more information on the New England District Corps of Engineers programs, visit our website at <http://www.nae.usace.army.mil>.

THIS NOTICE IS NOT AN AUTHORIZATION TO DO ANY WORK.



**Karen K. Adams
Chief, Permits and Enforcement Branch
Regulatory Division**

If you would prefer not to continue receiving Public Notices, please contact Ms. Tina Chaisson at (978) 318-8058 or e-mail her at bettina.m.chaisson@usace.army.mil. You may also check here () and return this portion of the Public Notice to: Bettina Chaisson, Regulatory Division, U.S. Army Corps of Engineers, 696 Virginia Road, Concord, MA 01742-2751.


NAME: _____

ADDRESS: _____

PROPOSED WORK AND PURPOSE

The work includes the discharge of fill material to address safety concerns at the Harriman and West airport in North Adams and Williamstown, Massachusetts. The work is needed to conform with Federal Aviation Administration standards. Work in jurisdictional waters include the relocation and reconstruction of the existing 4,300 foot by 100-foot Runway (Runway 11-29) by 100 feet to the west; replacement of the existing 430 linear feet of 6-foot diameter culvert with a 7-foot by 6-foot box culvert beneath Runway 11; replacing existing 500 linear feet of twin 5-foot diameter culverts with a 7-foot by 6-foot box culvert in Paull Brook beneath the runway; and creation of a 3.3 acre replacement wetland and stream channel. Approximately 1.51 acres of wetlands would be impacted during construction.

The work is described on the enclosed plans entitled "RUNWAY AND TAXIWAY RECONSTRUCTION WITH SAFETY AREA AND OTHER AIRPORT IMPROVEMENTS, HARRIMAN AND WEST AIRPORT, STATE ROAD (ROUTE 2), CITY OF NORTH ADAMS, MASSACHUSETTS," on 18 sheets, and dated "October 2007."

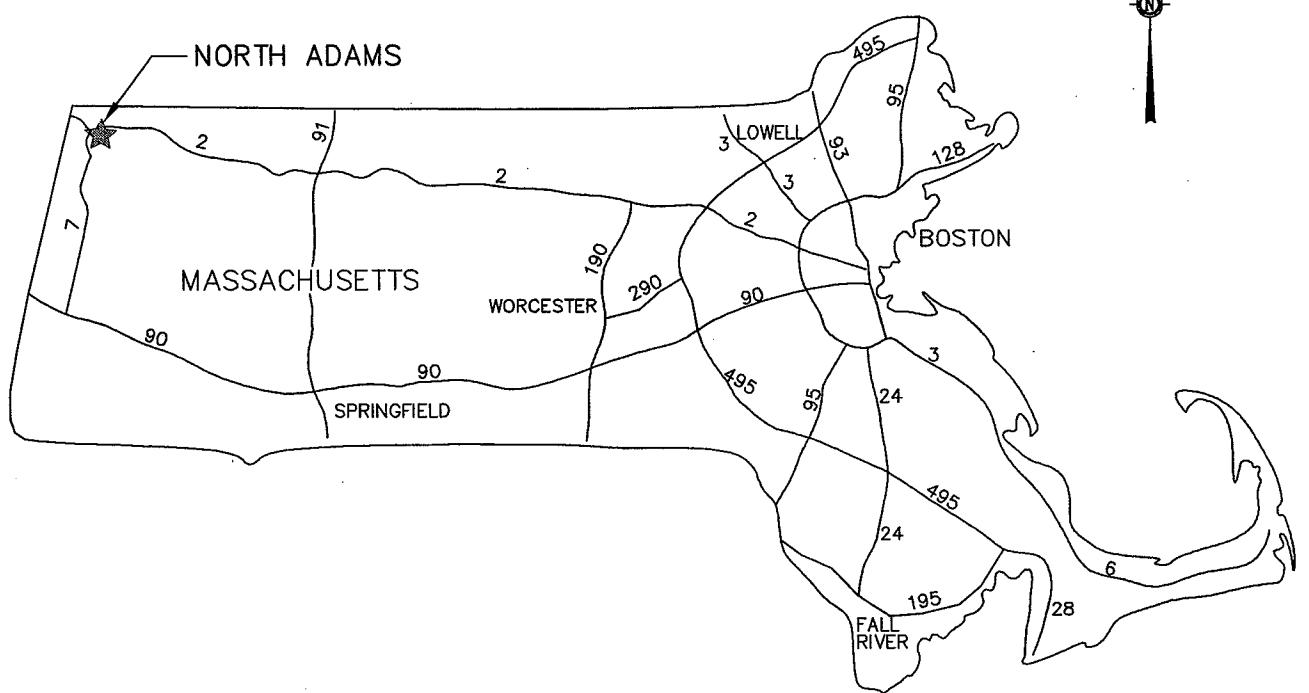

LOCATION MAP


SCALE: 1"=30 MILES

RECEIVED

DEC 10 2007

REGULATORY DIVISION

GRAPHICAL SCALE

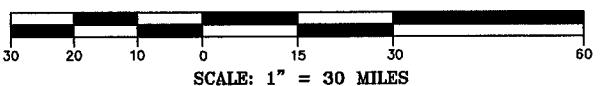

AIRPORT LOCATION MAP

RUNWAY AND TAXIWAY RECONSTRUCTION WITH
SAFETY AREA AND OTHER AIRPORT IMPROVEMENTS
AIP NO. 3-25-0036-17
HARRIMAN AND WEST AIRPORT
STATE ROAD (ROUTE 2)
CITY OF NORTH ADAMS, MASSACHUSETTS

PERMITTING PLAN SET

SECTION 404 PROGRAMMATIC
GENERAL PERMIT, CATEGORY II
PURSUANT TO 33 USC 1344


DATE:	JUNE 2006
SCALE:	AS SHOWN
REVISION:	2: OCTOBER 2007

FIG. 1



Gale Associates, Inc.
Engineers Architects Planners
15 Constitution Drive
Bedford, NH 03110
P 603.471.1887 F 603.471.1809
www.galnco.com
Boston Baltimore Orlando San Francisco

BAYSTATE ENVIRONMENTAL
CONSULTANTS INC.
Civil Engineers
238 North Main Street
Environmental Scientists
West Longmeadow, MA 01085

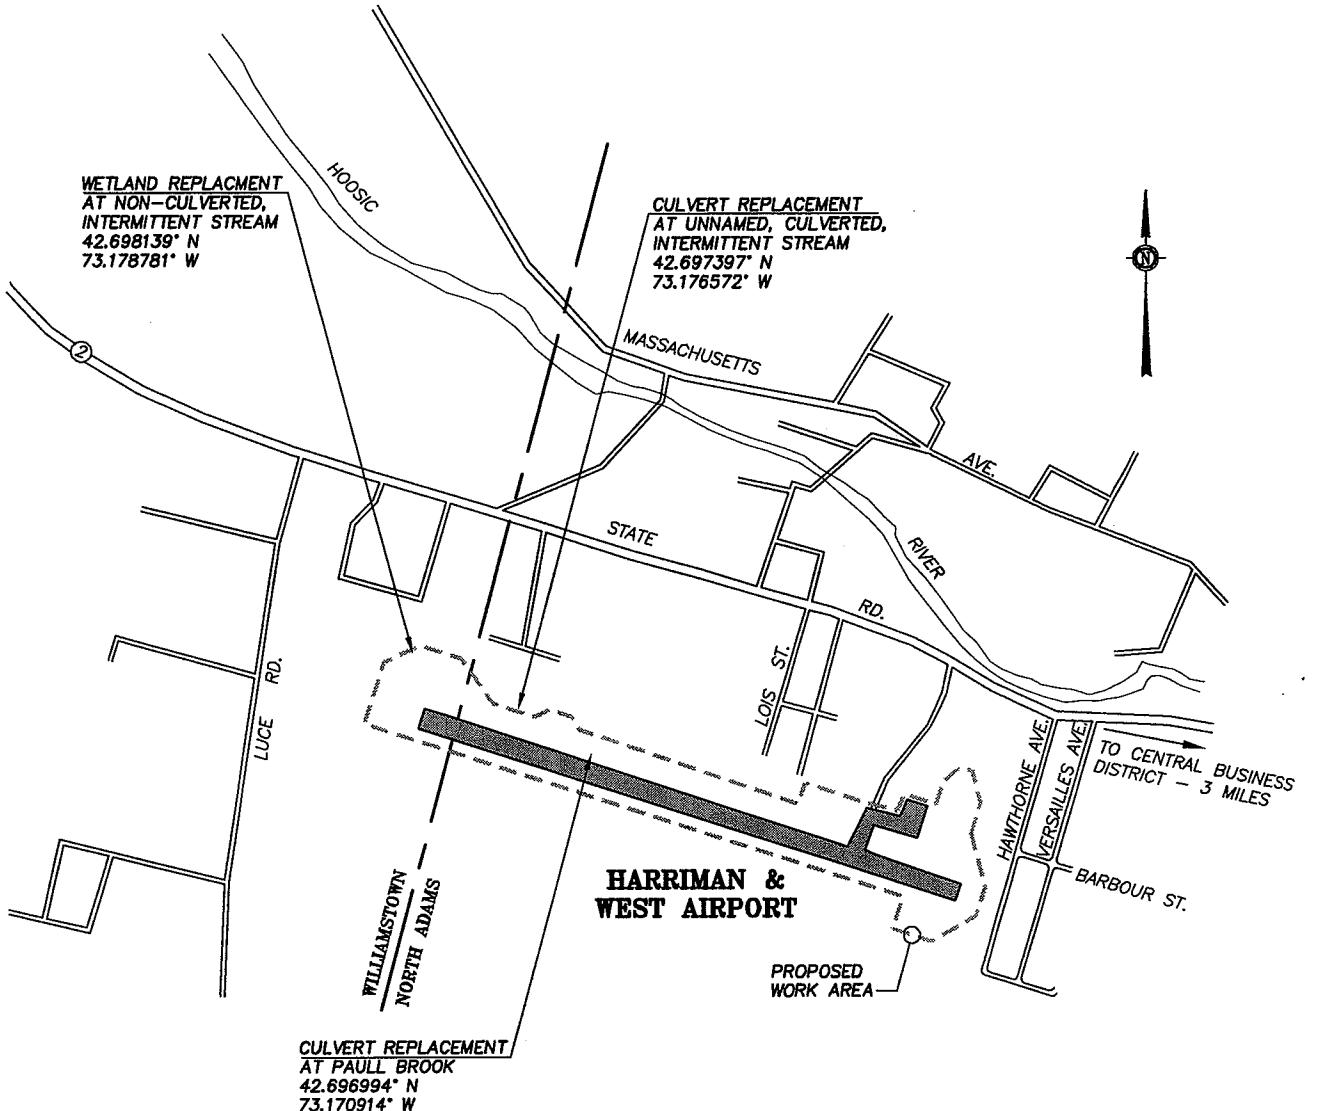

HARRIMAN AND WEST AIRPORT
CITY OF NORTH ADAMS, TOWN OF
WILLIAMSTOWN, MASSACHUSETTS

SCALE: N.T.S.


PROJECT DATUM:

COORDINATE SYSTEM:
MASS. STATE PLANE
ENGLISH UNITS

GEODETIC DATUM:
NAD27

VERTICAL DATUM:
NGVD 1929


GALE Gale Associates, Inc. Engineers Architects Planners 15 Constitution Drive Bedford, NH 03110 P 603.471.1887 F 603.471.1809 www.galinc.com Boston Baltimore Orlando San Francisco	SITE VICINITY MAP				DATE: JUNE 2006
	PROJ. NO:	DRAWN	REVIEWED	CADD FILE	
PEC BAYSTATE ENVIRONMENTAL CONSULTANTS INC. Civil Engineers 200 North Main Street Environmental Scientists East Longmeadow, MA 01028	775750	EWS	BLA	775750-G12.DWG	SCALE: AS SHOWN
RUNWAY AND TAXIWAY RECONSTRUCTION WITH SAFETY AREA AND OTHER AIRPORT IMPROVEMENTS AIRP NO. 3-25-0036-17 HARRIMAN AND WEST AIRPORT STATE ROAD (ROUTE 2) CITY OF NORTH ADAMS, MASSACHUSETTS					
PERMITTING PLAN SET SECTION 404 PROGRAMMATIC GENERAL PERMIT, CATEGORY II <small>PURSUANT TO 33 USC 1314</small>					
FIG. 2					

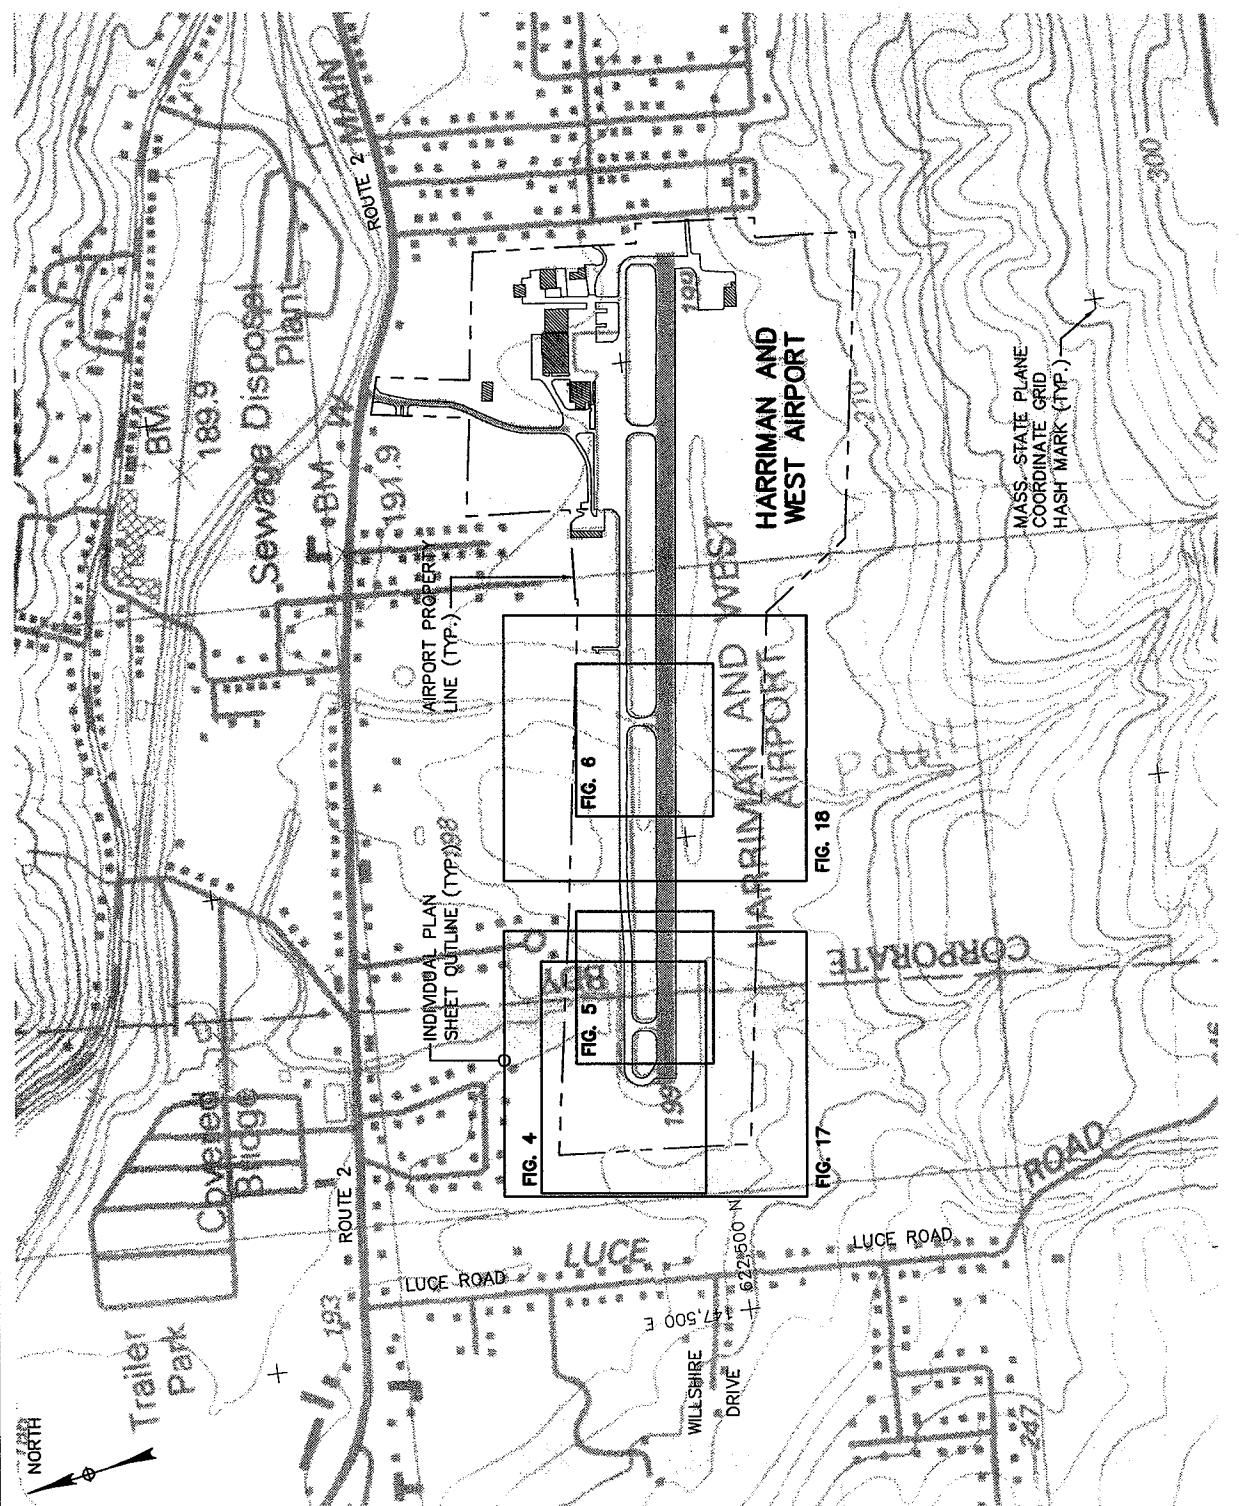

HARRIMAN AND WEST AIRPORT
NORTH ADAMS AND WILLIAMSTOWN, MASSACHUSETTS
SCALE: 1"=1,000'

GRAPHIC SCALE
0 250 500 1,000
SCALE: 1'=1,000

INDIVIDUAL SHEET LOCATION PLAN				DATE:	JUNE 2006
				SCALE:	1"=1,000'
				REVISION:	3: DECEMBER 2007
	RUNWAY AND TAXIWAY RECONSTRUCTION WITH SAFETY AREA AND OTHER AIRPORT IMPROVEMENTS AIR NO. 3-25-0036-17 HARRIMAN AND WEST AIRPORT STATE ROAD (ROUTE 2) CITY OF NORTH ADAMS, MASSACHUSETTS	PERMITTING PLAN SET SECTION 404 PROGRAMMATIC GENERAL PERMIT, CATEGORY II PURSUANT TO 33 URG 1544			
BAYSTATE ENVIRONMENTAL CONSULTANTS INC.	PROJ. NO:	DRAWN	REVIEWED	CADD FILE	FIG. 3
Civil Engineers 259 Main St., Suite 100 Billerica, MA 01821	775750	EWS	BLA	775750-G14.DWG	

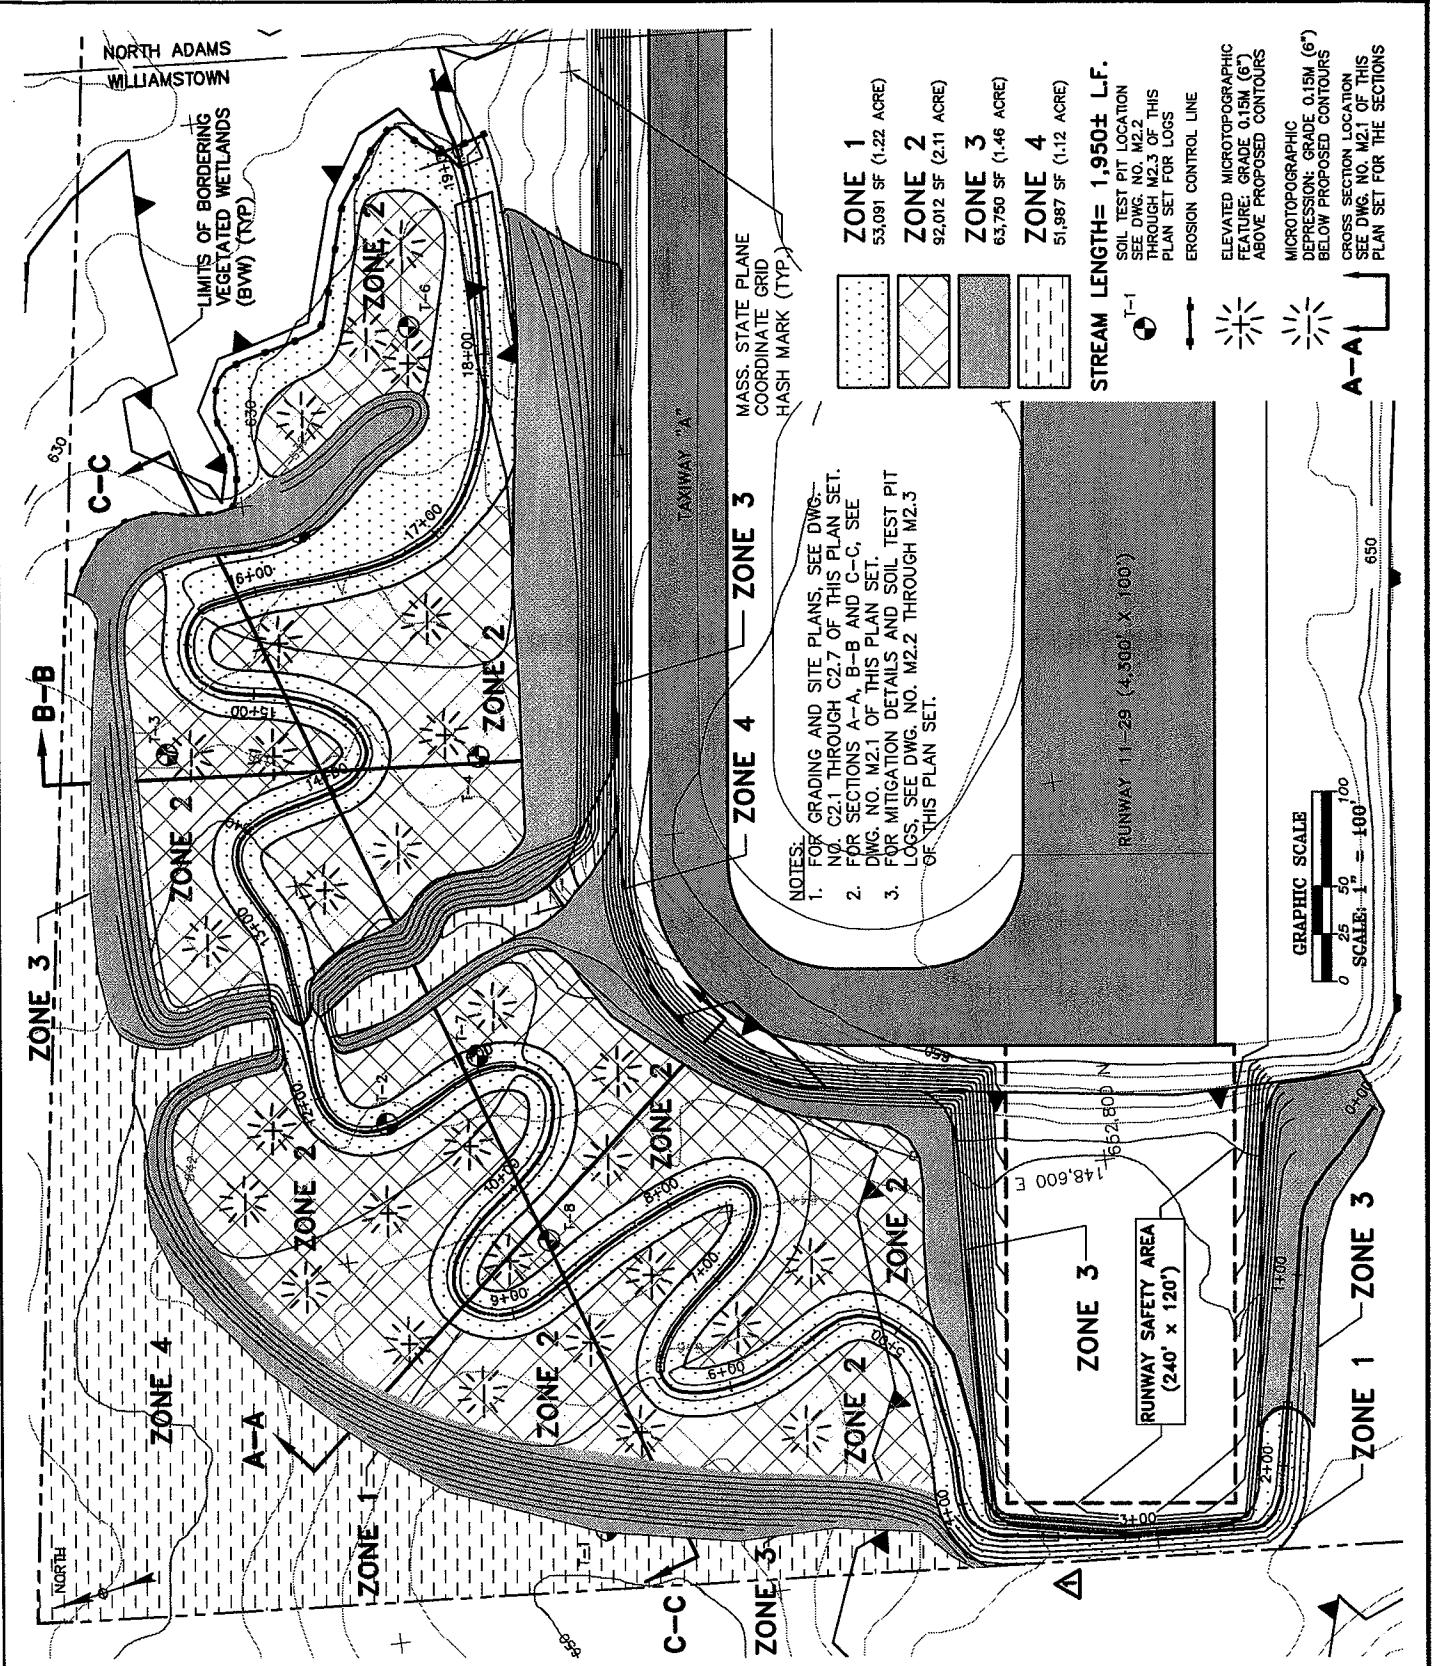

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BEC BAYSTATE ENVIRONMENTAL CONSULTANTS INC.
Civil Engineers
200 North Main Street
Environmental Scientists
East Longmeadow, MA 01028

**MITIGATION GRADING AND SITE PLAN –
WETLAND REPLACEMENT AT NON-CULVERTED,
INTERMITTENT STREAM**


RUNWAY AND TAXIWAY RECONSTRUCTION WITH
SAFETY AREA AND OTHER AIRPORT IMPROVEMENTS
AIP NO. 3-25-0036-17
HARRIMAN AND WEST AIRPORT
STATE ROAD (ROUTE 2)
CITY OF NORTH ADAMS, MASSACHUSETTS

PERMITTING PLAN SET
SECTION 404 PROGRAMMATIC
GENERAL PERMIT, CATEGORY II
PURSUANT TO 32 URC 1544

DATE:	JUNE 2006
SCALE:	1"=100'
REVISION:	2: OCTOBER 2007

PROJ. NO:	DRAWN	REVIEWED	CADD FILE
775750	BEC	BL	775750-M11.DWG

FIG. 4

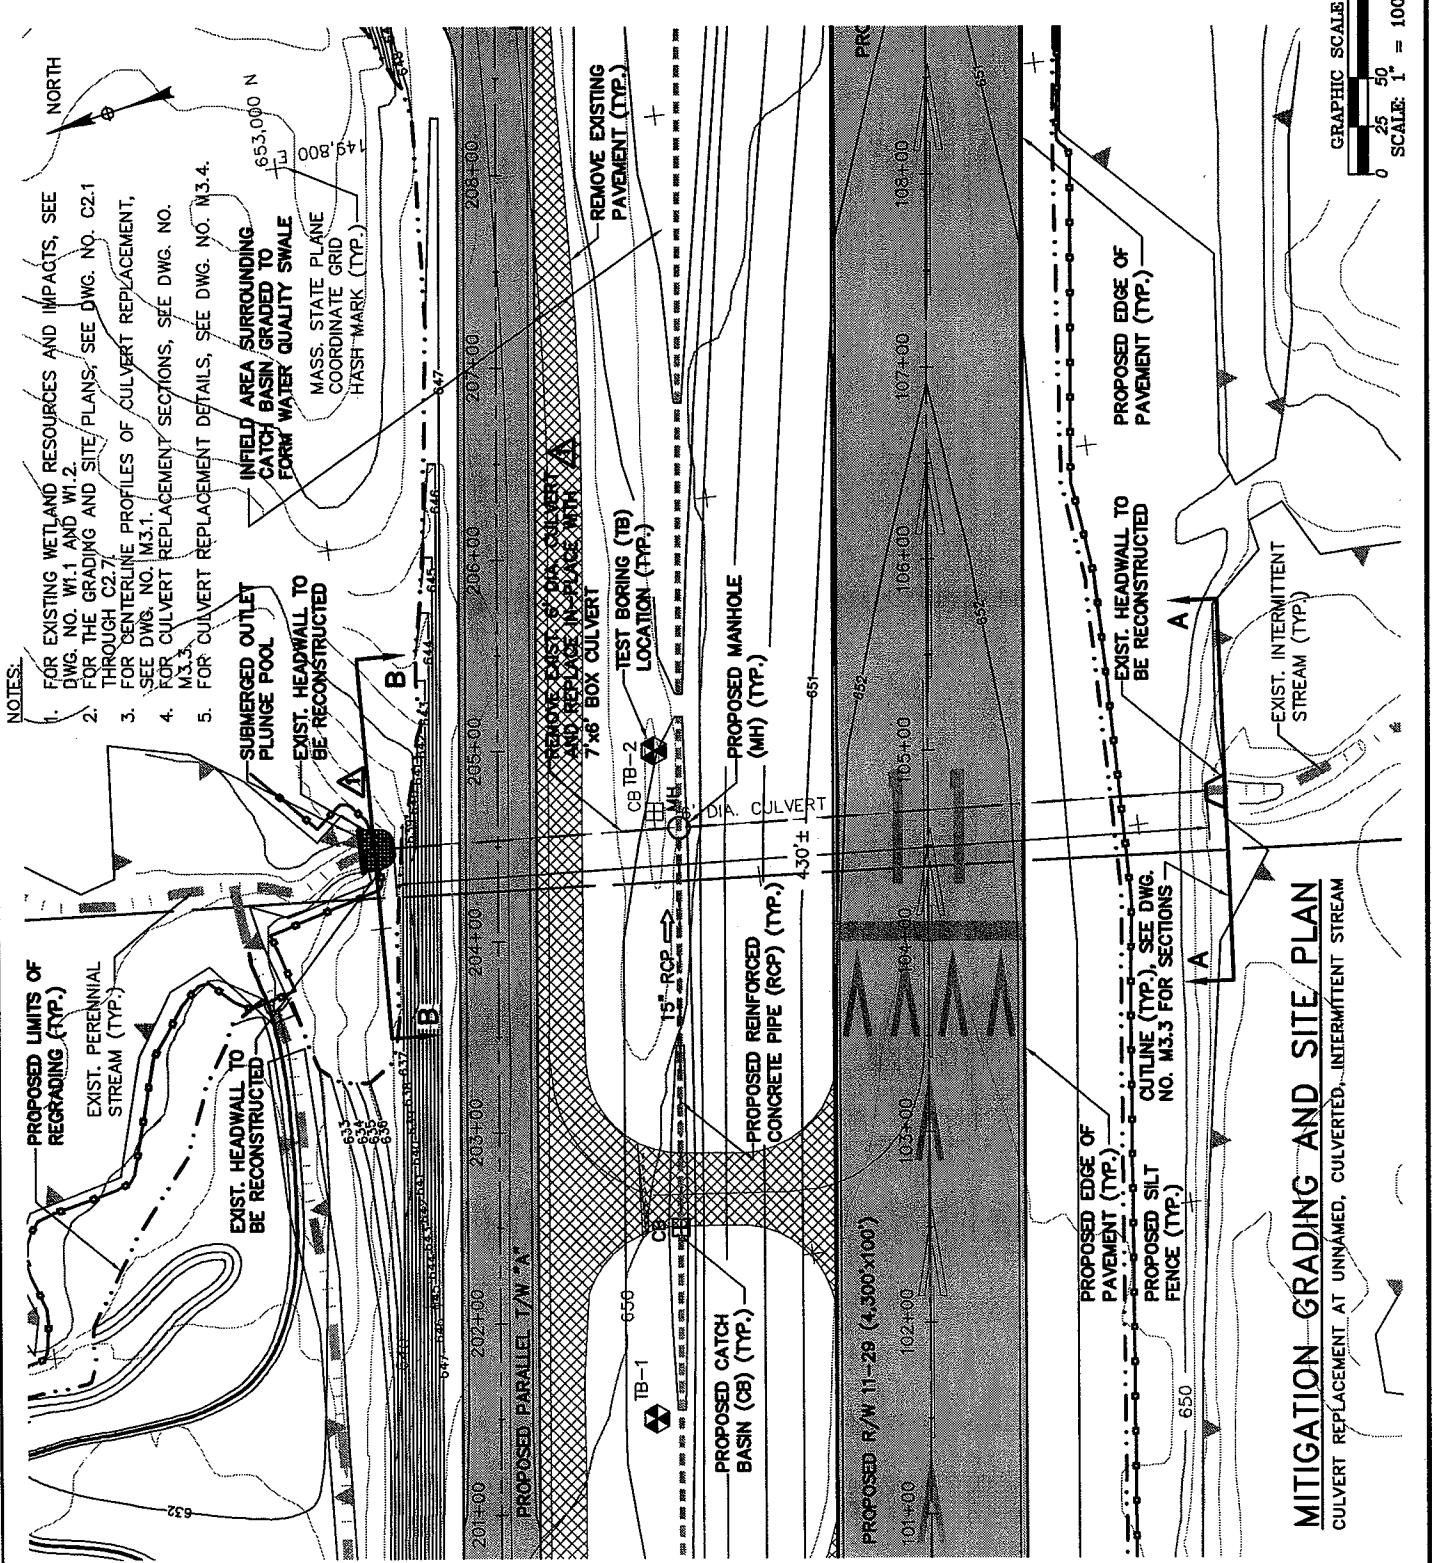

RUNWAY AND TAXIWAY RECONSTRUCTION WITH SAFETY AREA AND OTHER AIRPORT IMPROVEMENTS
AIRPARK NO. 3-25-0036-17
HARRIMAN AND WEST AIRPORT
STATE ROAD (ROUTE 2)
CITY OF NORTH ADAMS, MASSACHUSETTS

SECTION 404 PROGRAMMATIC
GENERAL PERMIT, CATEGORY II
PURSUANT TO 33 URC 1944

DATE: JUNE 2006


SCALE: AS SHOWN

REVISION: 2: OCTOBER 2007

FIG. 5




PROJ. NO.: 775750 DRAWN: EWS REVIEWED: BL5 CADD FILE: 775750-M12.DWG


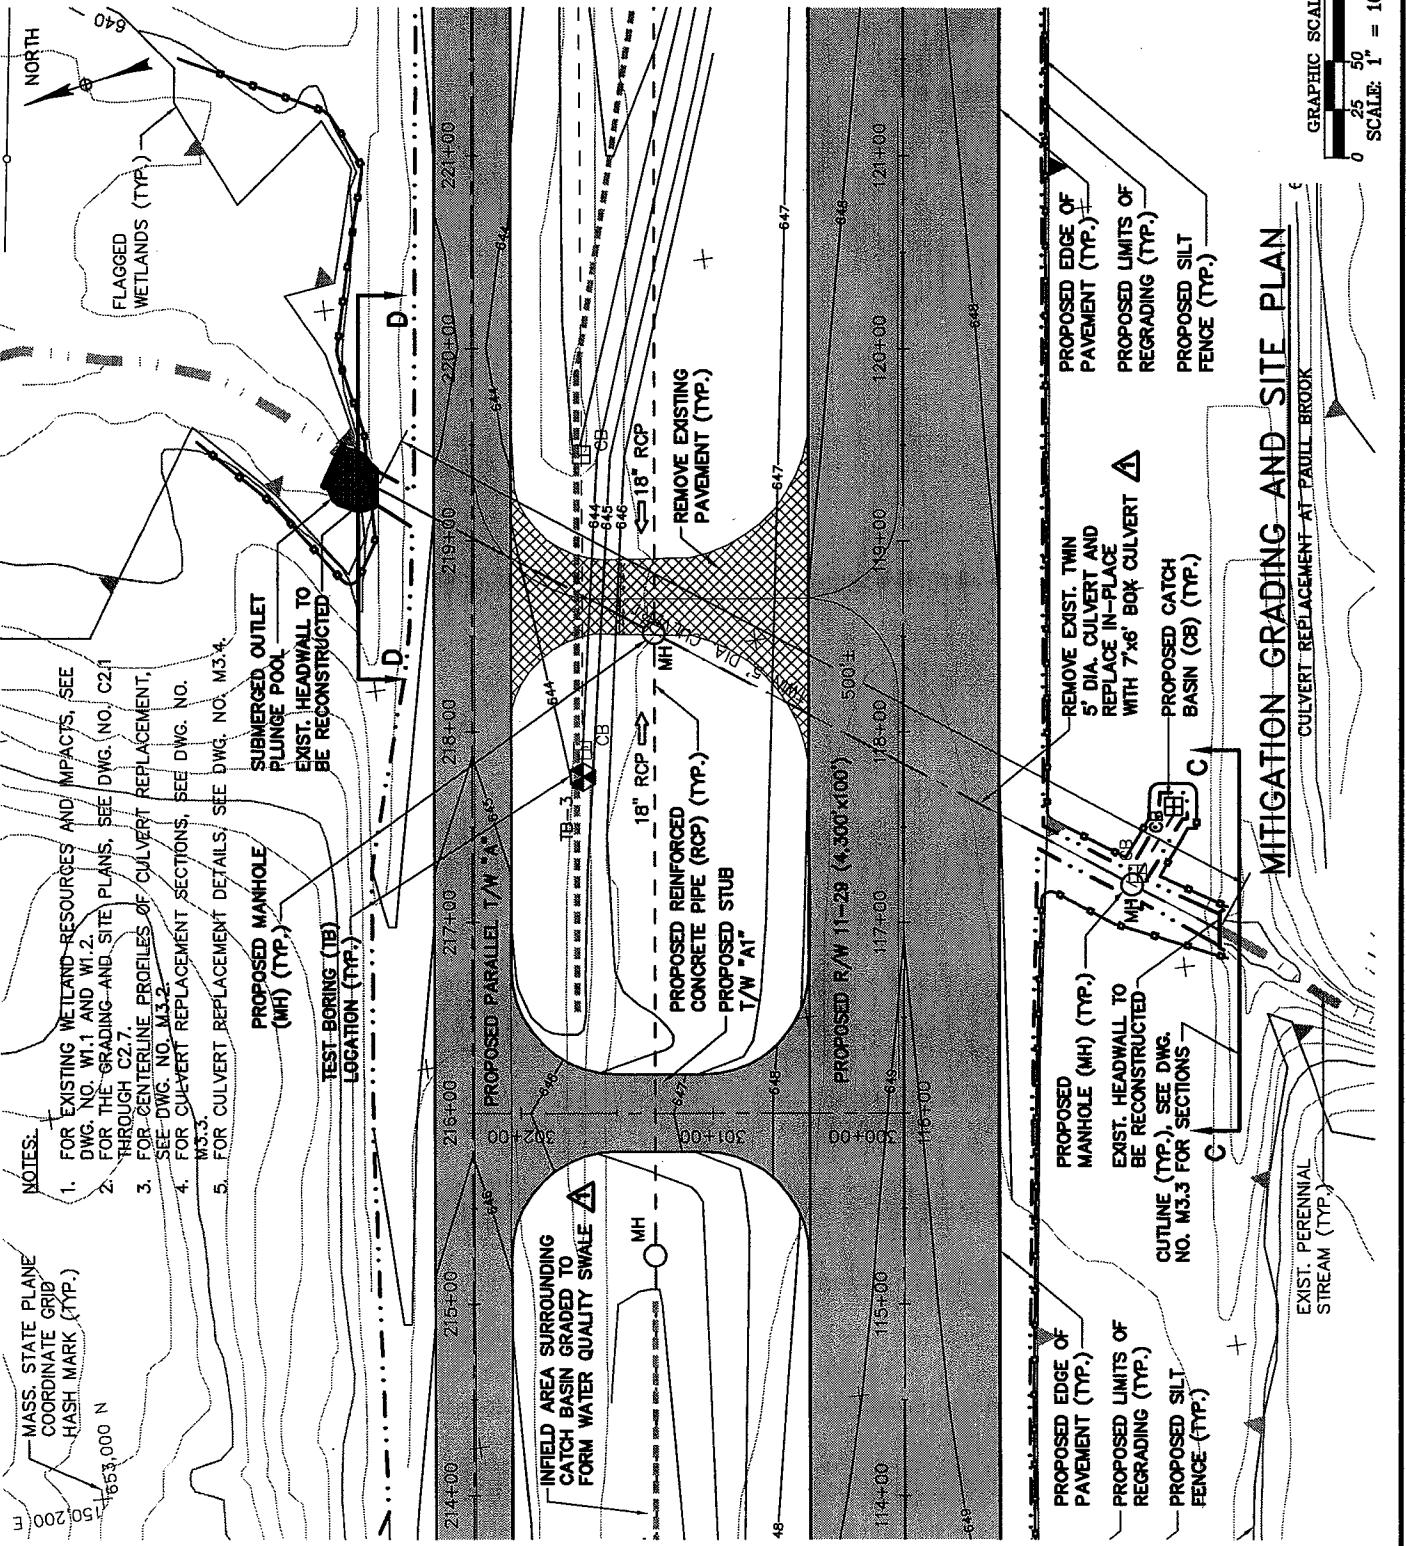


GALE				MITIGATION GRADING AND SITE PLAN – CULVERT REPLACEMENT AT PAULL BROOK			
Gale Associates, Inc Engineers Architects Planners							
15 Constitution Drive Bedford, NH 03110 P 603.471.1887 F 603.471.1809 www.gainc.com							
Boston Baltimore Orlando San Francisco							
BEC	BAYSTATE ENVIRONMENTAL CONSULTANTS INC.	Civil Engineers 298 North Main Street East Longmeadow, MA 01028	Environmental Scientists	RUNWAY AND TAXIWAY RECONSTRUCTION WITH SAFETY AREA AND OTHER AIRPORT IMPROVEMENTS AIRP NO. 3-25-0036-17 HARRIMAN AND WEST AIRPORT STATE ROAD (ROUTE 2) CITY OF NORTH ADAMS, MASSACHUSETTS	PERMITTING PLAN SET SECTION 404 PROGRAMMATIC GENERAL PERMIT, CATEGORY II PURSUANT TO 33 URC 1844	DATE: JUNE 2006	SCALE: AS SHOWN
PROJ. NO:	DRAWN:	REVIEWED:	CADD FILE:	775750	EWS	BL	775750-M12.DWG


FIG. 6

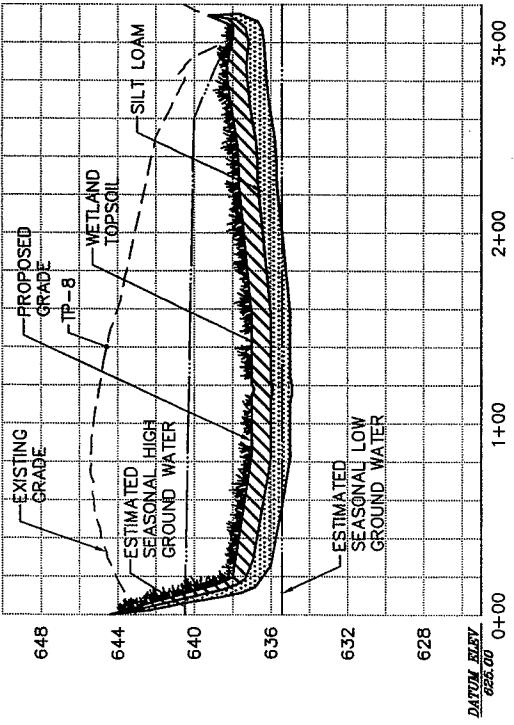

MITIGATION AREA SECTION A-A
SEE DWG. NO. C2.5 FOR THE LOCATION OF THIS SECTION

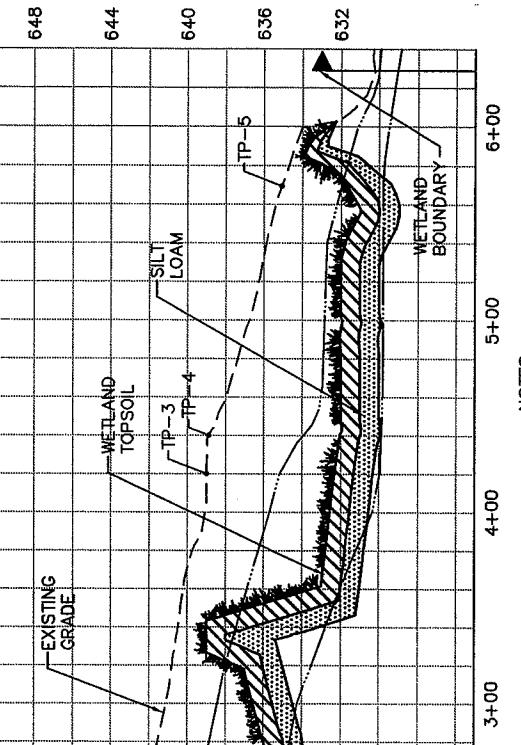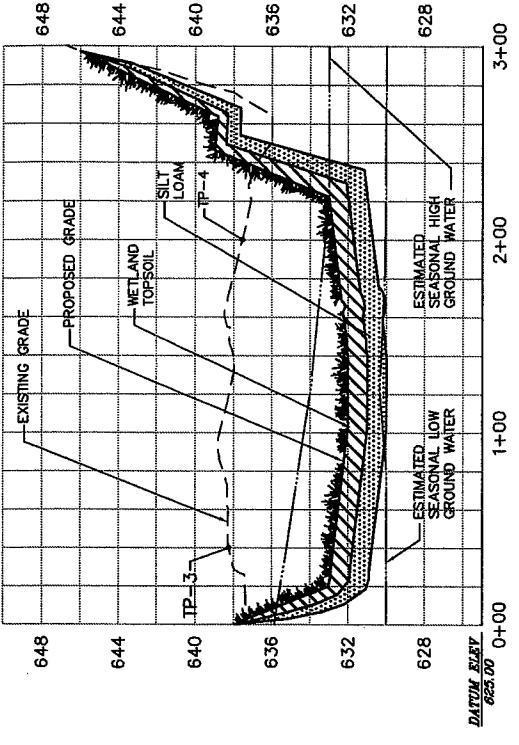

NOTES:
 1. FOR GRADING AND SITE PLANS, SEE DWG. NO. C2.1 THROUGH C2.7 OF THIS PLAN SET.
 2. FOR THE LOCATION OF EACH SECTION SHOWN ABOVE, SEE DWG. NO. M1.1 OF THIS PLAN SET.
 3. FOR MITIGATION DETAILS AND SOILS TEST PIT LOGS, SEE DWG. M2.2 THROUGH M2.3 OF THIS PLAN SET.

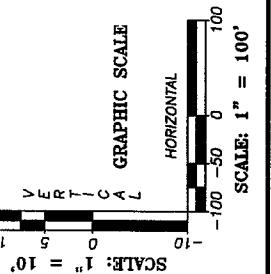

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200 North Main Street
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**MITIGATION SECTIONS – WETLAND
REPLACEMENT AT NON-CULVERTED,
INTERMITTENT STREAM**

RUNWAY AND TAXIWAY RECONSTRUCTION WITH
SAFETY AREA AND OTHER AIRPORT IMPROVEMENTS
AIP NO. 3-25-0036-17
HARRIMAN AND WEST AIRPORT
STATE ROAD (ROUTE 2)
CITY OF NORTH ADAMS, MASSACHUSETTS

PERMITTING PLAN SET
SECTION 404 PROGRAMMATIC
GENERAL PERMIT, CATEGORY II
PURSUANT TO 25 URC 1344

DATE:	JUNE 2006
SCALE:	AS SHOWN
REVISION:	2: OCTOBER 2007

PROJ. NO:	DRAWN	REVIEWED	CADD FILE
775750	BEC	BLs	775750-M21.DWG

FIG. 7

IP-1		Indus		Mithila		Gangabanki	
Depth	Horizon	Color	V	V	SL	SL	SL
0-2"	V	V	2.5	2.5	SL	SL	SL
2-4"	A	2.5	2.5	SL	SL	SL	SL
4-8"	Bm	2.5	2.5	SL	SL	SL	SL
8-18"	Bm2	2.5	2.5	SL	SL	SL	SL
18-23"							
23-30"	BC	2.5	2.5	SL	SL	SL	SL
30-35"	C	2.5	2.5	SC	SL	SL	SL
35-40"							
40-50"	C2	2.5	2.5	SC	SL	SL	SL
50-60"							
60-70"	C3	2.5	2.5	SC	SL	SL	SL

IP-2

Period (yr)	Number of Stars	Relative Frequency
0-2 ⁺	10	10 yr 2/2
2-5 ⁺	10	10 yr 5/3 yrsL
5-13 ⁺	10	10 yr 5/3 yrsL map 5 yr 4/4
13-25 ⁺	10	10 yr 6/25 yrsL map 7.5 yr 6/4
23-43 ⁺	10	10 yr 6/25 yrsL
43-108 ⁺	2.5	2.5 yr 5/3 yrsL fit 2.5 yr 9/2 estimated 6 5/7

The graph shows ground resistance (Ω) on the y-axis (0 to 100) versus depth (m) on the x-axis (0 to 32). The data points are as follows:


Depth (m)	Resistance (Ω)
0-3 ⁺	2.5
3-5 ⁺	4.3
A ⁺	4.2
B ⁺	4.2
C ⁺	5.3
8-13 ⁺	5.3
13-20 ⁺	4.4
20-32 ⁺	4.4
32-104 ⁺	5.1

Annotations: A dashed line connects the first four data points (0-5m). A solid line connects the remaining points (8-32m). A vertical line at 25m indicates the limit of the sounding. A horizontal line at 75Ω indicates the limit of the instrument.

T-4		Color		Texture		Minerals		Groundwater	
Depth	Horizon	V	V	V	V	V	V	V	V
0--4"	A	2.5	YR	3/5	VS				
4--11"	Bg	2.5	YR	4/2	VS				
11--15"	C	2.5	YR	5/5	VS				
15--23"	C2	2.5	YR	4/4	0				
23--28"	C3	2.5	YR	8/2	S				
28--37"	C4	2.5	YR	4/4	S				
37--67"	ZC	6	YR	8/2	VS				
67--91"	ZC2	5	YR	5/1	SC	2.5	YR	4/4	(w)

SOIL TEST PIT LOGS

TP-1 THROUGH TP-4
N.T.S.

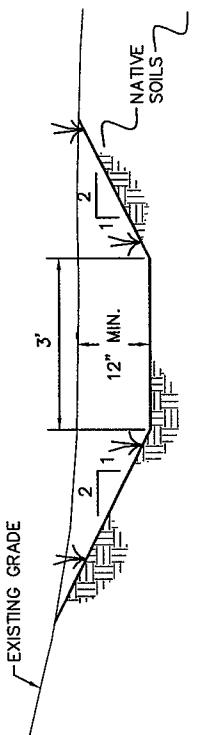

TYPICAL SECTION STREAM CHANNEL
STA 0+00 TO 3+00 N.T.S.

TYPICAL SECTION THROUGH WATER
CASCADE FEATURE AND PLUNGE POOL

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FOR THE LOCATIONS
OF TEST PITS (TP),
SEE DWG. NO. M-1
OF THIS PLAN SET.

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MITIGATION DETAILS (SHEET 1 OF 2)				DATE:	JUNE 2006
				SCALE:	NOT TO SCALE
				REVISION:	2: OCTOBER 2007
RUNWAY AND TAXIWAY RECONSTRUCTION WITH SAFETY AREA AND OTHER AIRPORT IMPROVEMENTS AIP NO. 3-25-0036-17 HARRIMAN AND WEST AIRPORT STATE ROAD (ROUTE 2) CITY OF NORTH ADAMS, MASSACHUSETTS			PERMITTING PLAN SET <div style="border: 1px solid black; padding: 2px;"> SECTION 404 PROGRAMMATIC GENERAL PERMIT, CATEGORY II <small>PURSUANT TO 33 URS 1544</small> </div>		
PROJ. NO:	DRAWN	REVIEWED	CADD FILE		
775750	BEC	BLs	775750-M22.DWG		

FIG. 8

IP-5		Sister		Sister	
Benth.	Horizon	Thickness	Motiles	Motiles	Sedimentation
0-1"	V	2.5 yr 3/3	vel.		
1-4"	A	2.5 yr 3/3	vel.		
AB					
4-15"	Bw	10 yr 4/4	vel.	elip & yr 1/4	
15-21"	C	10 yr 3/3	qts	2.5 yr 3/3	
			elip 5 yr 3/3		
21-45"	2C	2.5 yr 5/2	SC	elip 2.5 yr 5/3	mineral
					No sediment
45-75"	2C2	2.5 yr 5/1	SC		


T-0		Color	Tide	Motion	Groundwater
Horizon	X	10 yr	2/2	tsl.	
0-2"	X	10 yr	2/2	tsl.	
2-12"	X	2.5 yr	5/3	vsrl.	
12-46"	C	10 yr	5/3	tsl	w/20% clockwise
Depth					saturation @ 30°
					groundwater @ 30°

IP-7		Grundwasser	
Soil	Horizon	Indicus	Motus
V	V	2.5 m 3/3	WL
A	V	2.5 m 3/3	WL
B	V	2.5 m 3/3	WL
BC	V	2.5 m 3/3	WL
C	V/V ₁ /V ₂	2.5 m 3/3	flowing WL
C2	V	2.5 m 3/3	WL
C3		2.5 m 6/2	WL

T-8		Structures	
Depth	Horizon	Color	Texture
0-3"	A	2.5 YM 6/3	VLS.
3-7"	B	2.5 YM 6/3	Off 10 YM 5/4.
7-13"	BG	2.5 YM 6/3	Vel. off 10 YM 6/4.
13-21"	C	2.5 YM 6/3	Vel. off 2.5 YM 6/4.
21-38"	C2	2.5 YM 5/2	Layered VLS/SR
28-45"	C3	2.5 YM 5/1	Layered VLS/SR
43-58"	C4	2.5 YM 6/1	SR


SOIL TEST PIT LOGS

TP-5 THROUGH TP-8
N.T.S.

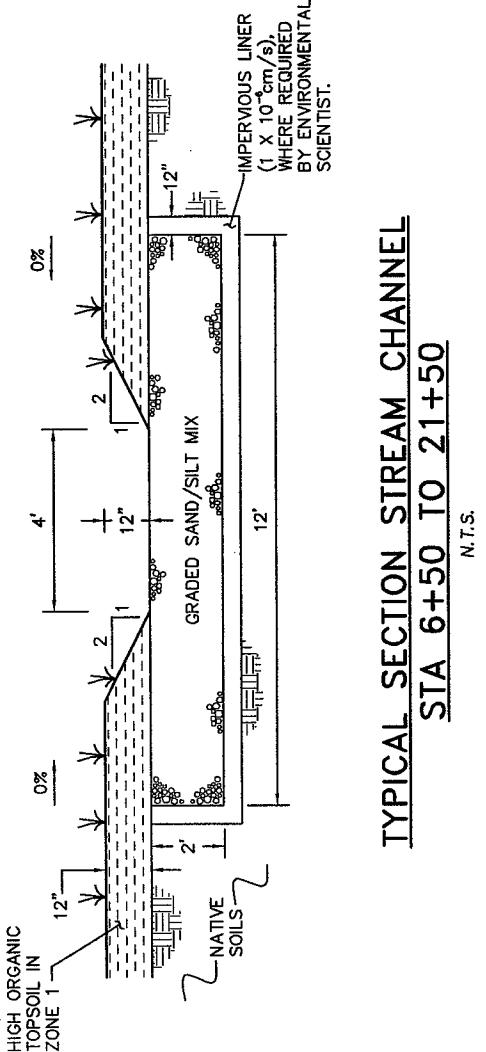

TYPICAL SECTION STREAM CHANNEL
STA 6+50 TO 21+50

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TYPICAL SECTION STREAM CHANNEL
STA 3+00 TO 6+50 & STA 21+50 TO 23+04
N.T.S.
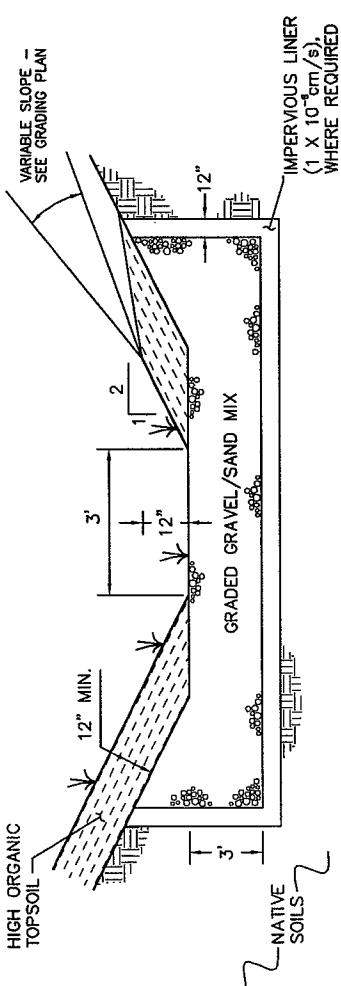
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OF TEST PITS (TP),
SEE DWG. NO. M1.1
OF THIS PLAN SET.



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**MITIGATION DETAILS
(SHEET 2 OF 2)**

RUNWAY AND TAXIWAY RECONSTRUCTION WITH
SAFETY AREA AND OTHER AIRPORT IMPROVEMENTS
AIRPORT NO. 3-25-0036-17
HARRIMAN AND WEST AIRPORT
STATE ROAD (ROUTE 2)
CITY OF NORTH ADAMS, MASSACHUSETTS

PERMITTING PLAN SET

DATE:	JUNE 2006
SCALE:	NOT TO SCALE
REVISION:	2: OCTOBER 2007

FIG. 9




**BAYSTATE ENVIRONMENTAL
CONSULTANTS INC.**

Environmental Scientists
Volume 14, Number 3, 2002


NOTES:

1. FOR LOCATION OF PROFILE, SEE DWG. NO. M1.2.
2. FOR SECTIONS AT THE INLET AND OUTLET OF THE CULVERT, SEE DWG. NO. M3.3.
3. FOR CULVERT DETAILS, SEE DWG. NO. M3.4.

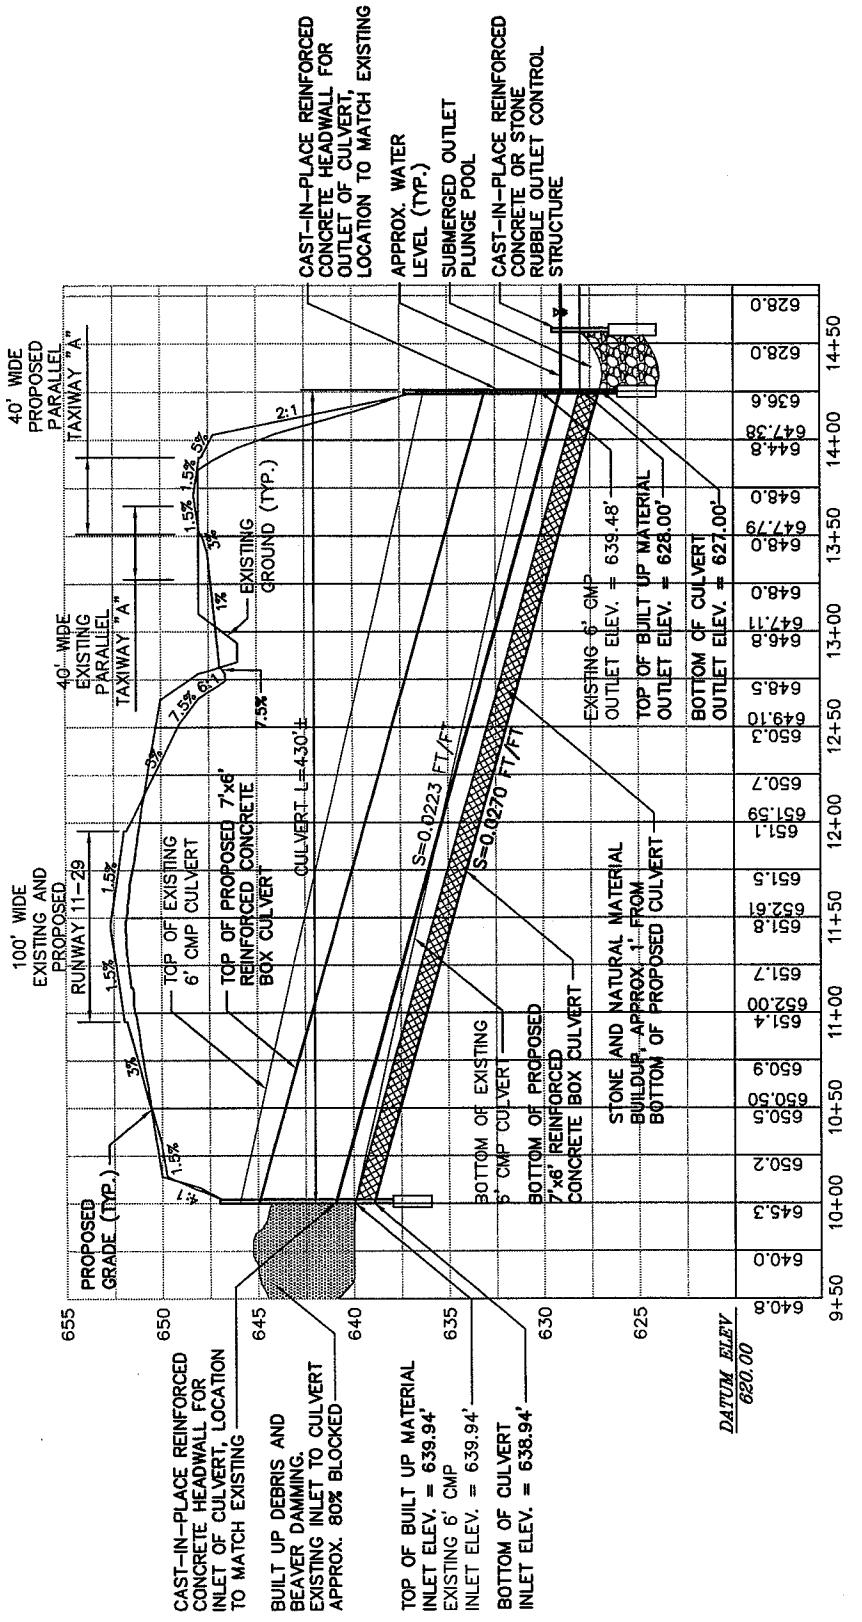

CENTERLINE PROFILE: UNNAMED, CULVERTED, INTERMITTENT STREAM

6' CORRUGATED METAL PIPE (EXISTING)
7x6' REINFORCED CONCRETE BOX CULVERT (PROPOSED)

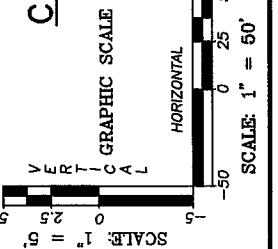

DATE:	JUNE 2006
SCALE:	AS SHOWN
REVISION:	2: OCTOBER 2007

FIG. 10



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15 Constitution Drive
Bedford, NH 03110
P 603.471.1887 F 603.471.1809
www.gainc.com

Boston Baltimore Orlando San Francisco



BAYSTATE ENVIRONMENTAL
CONSULTANTS INC.
Civil Engineers
218 North Main Street
Environmental Scientists
East Longmeadow, MA 01028

STREAM PROFILE – UNNAMED, CULVERTED, INTERMITTENT STREAM


RUNWAY AND TAXIWAY RECONSTRUCTION WITH
SAFETY AREA AND OTHER AIRPORT IMPROVEMENTS
AIR NO. 3-25-0036-17
HARRIMAN AND WEST AIRPORT
STATE ROAD (ROUTE 2)
CITY OF NORTH ADAMS, MASSACHUSETTS

PERMITTING PLAN SET
SECTION 404 PROGRAMMATIC
GENERAL PERMIT, CATEGORY II
PURSUANT TO 33 USC 1364


PROJ. NO:	DRAWN	REVIEWED	CADD FILE
775750	EWS	BL	775750-M31.DWG

NOTES:

1. FOR LOCATION OF PROFILE, SEE DWG. NO. M1.3.
2. FOR SECTIONS AT THE INLET AND OUTLET OF THE CULVERT, SEE DWG. NO. M3.3.
3. FOR CULVERT DETAILS, SEE DWG. NO. M3.4.

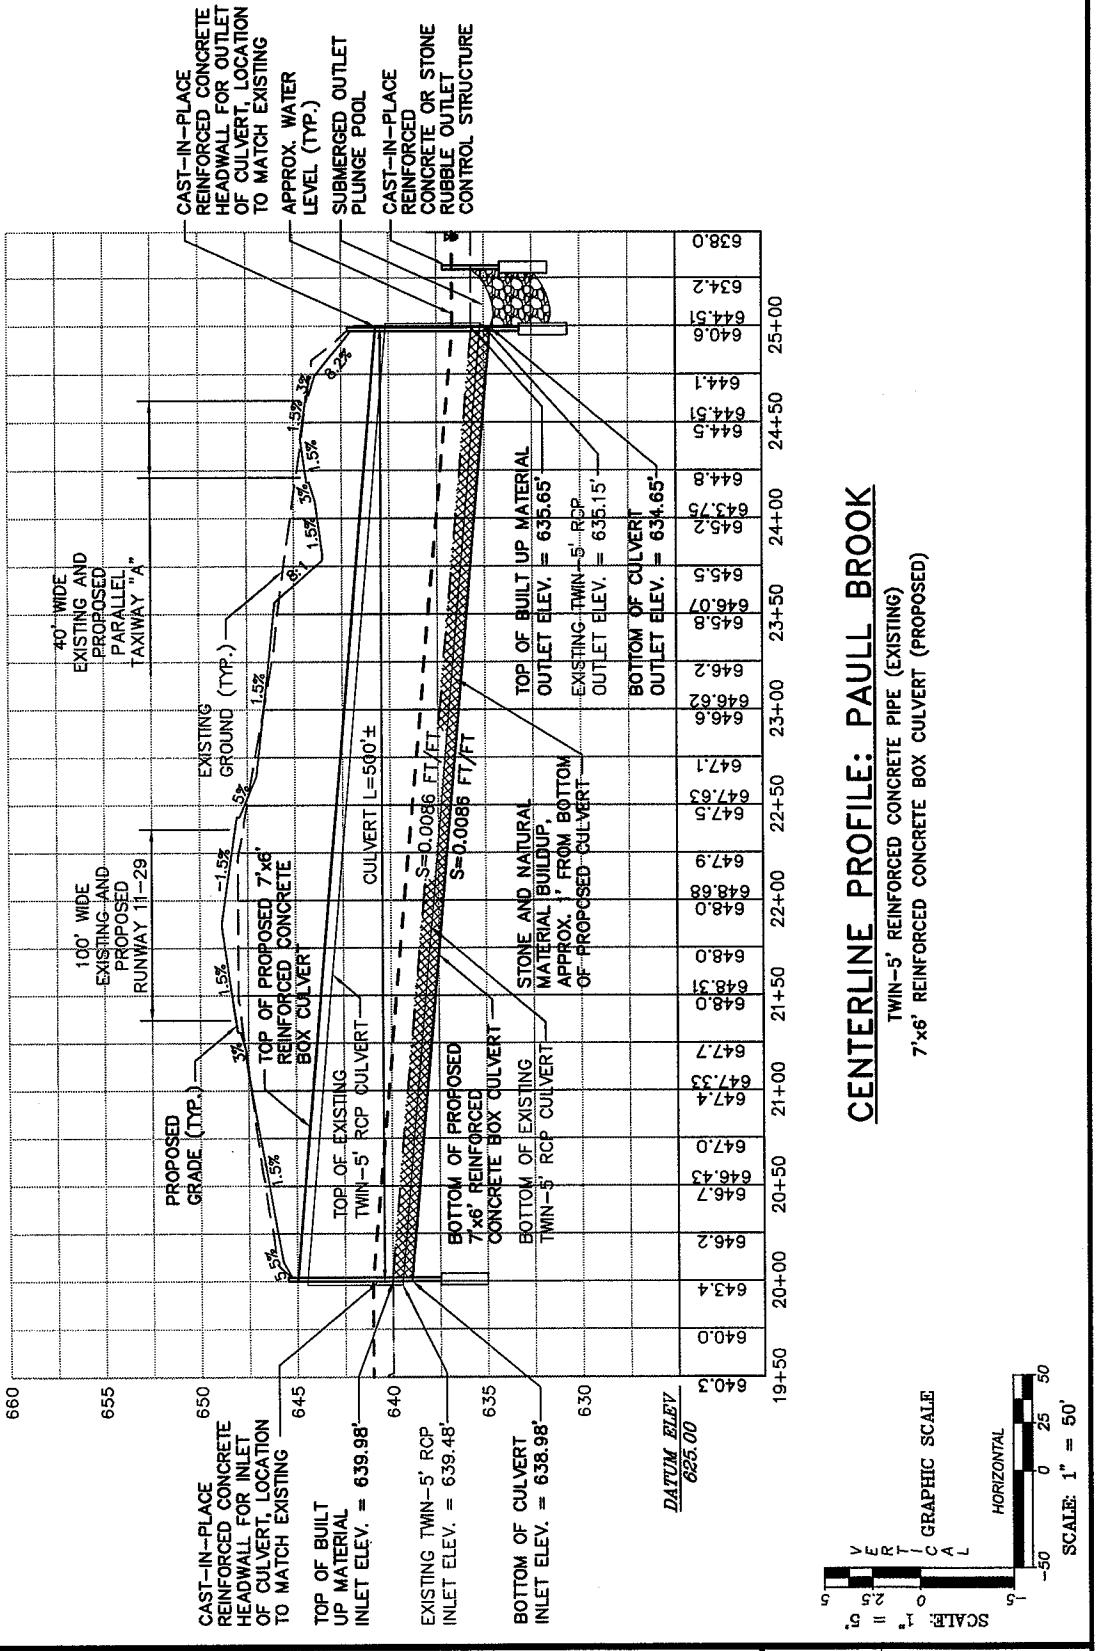**CENTERLINE PROFILE: PAULL BROOK**

TWIN-5' REINFORCED CONCRETE PIPE (EXISTING)
7x6' REINFORCED CONCRETE BOX CULVERT (PROPOSED)

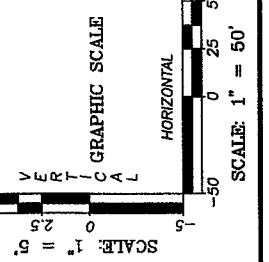

DATE:	JUNE 2006
SCALE:	AS SHOWN
REVISION:	2: OCTOBER 2007
FIG. 11	



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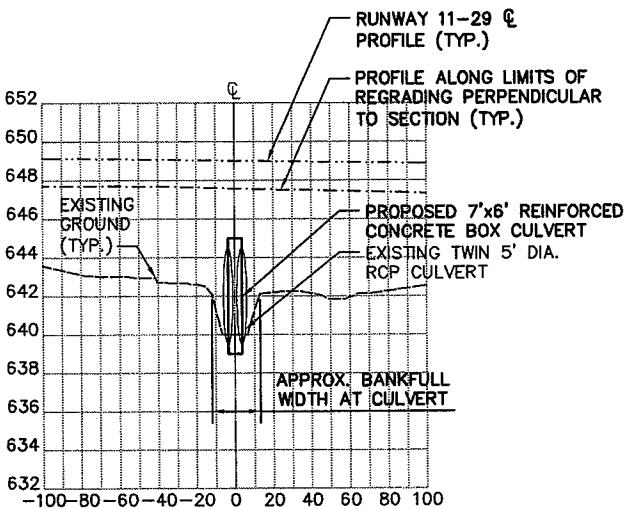
STREAM PROFILE - PAULL BROOK

RUNWAY AND TAXIWAY RECONSTRUCTION WITH
SAFETY AREA AND OTHER AIRPORT IMPROVEMENTS
AIP NO. 3-25-0038-17
HARRIMAN AND WEST AIRPORT
STATE ROAD (ROUTE 2)
CITY OF NORTH ADAMS, MASSACHUSETTS


PERMITTING PLAN SET

SECTION 404 PROGRAMMATIC
GENERAL PERMIT, CATEGORY II
PURSUANT TO 33 URG 1544

PROJ. NO: DRAWN REVIEWED CADD FILE
775750 EWS BLB 775750-M31.DWG



SECTION C-C: UPSTREAM END

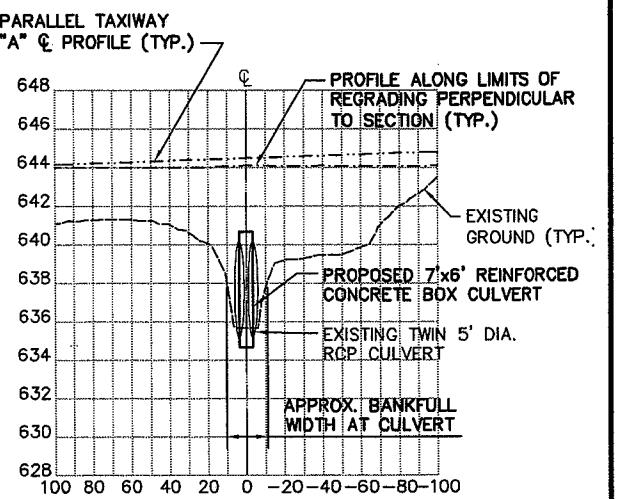


SECTION D-D: DOWNSTREAM END

CULVERT CROSS SECTIONS: PAULL BROOK



NOTES:

1. FOR LOCATION OF SECTIONS, SEE DWG. NO. M1.2 AND M1.3.
2. FOR PROFILES OF CULVERTS, SEE DWG. NO. M3.1 AND M3.2..
3. FOR CULVERT DETAILS, SEE DWG. NO. M3.4.
4. FOR INVERT AND BOTTOM OF CULVERT ELEVATIONS, DWG. NO. M3.1 AND M3.2

TWIN-5' REINFORCED CONCRETE PIPE (EXISTING)
7'x6' REINFORCED CONCRETE BOX CULVERT (PROPOSED)

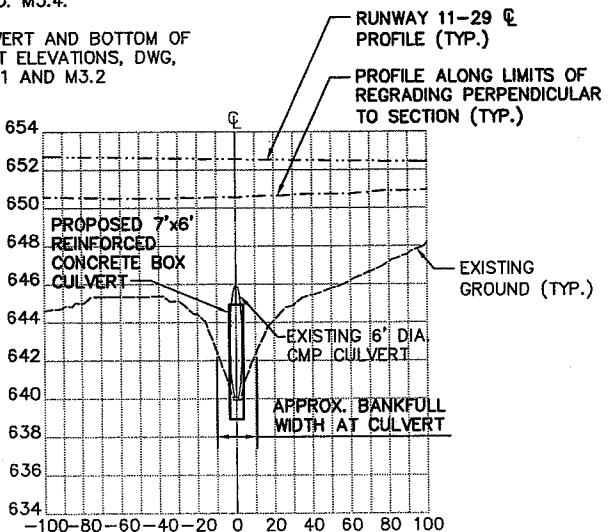

SECTION A-A: UPSTREAM END

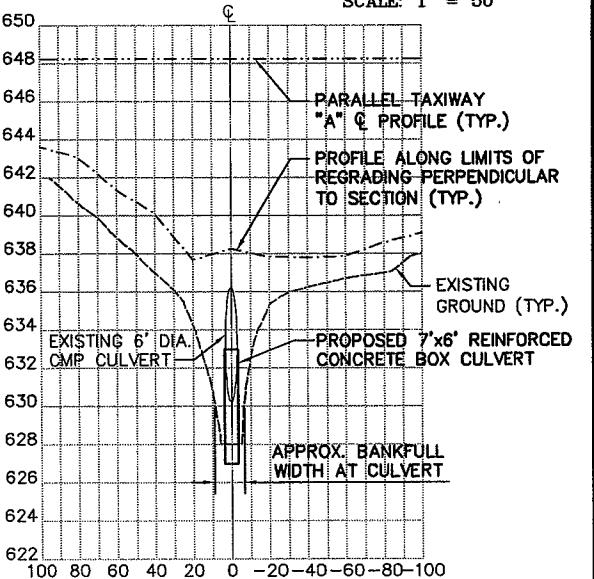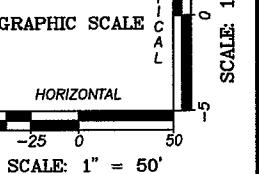

SECTION B-B: DOWNSTREAM END

CULVERT CROSS SECTIONS: UNNAMED BROOK

6' CORRUGATED METAL PIPE (EXISTING)
7'x6' REINFORCED CONCRETE BOX CULVERT (PROPOSED)



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MITIGATION SECTIONS – UNNAMED, CULVERTED, INTERMITTENT STREAM AND PAULL BROOK

RUNWAY AND TAXIWAY RECONSTRUCTION WITH
SAFETY AREA AND OTHER AIRPORT IMPROVEMENTS
AIP NO. 3-25-0032-17
HARRIMAN AND WEST AIRPORT
STATE ROAD (ROUTE 2)
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PERMITTING PLAN SET

SECTION 404 PROGRAMMATIC
GENERAL PERMIT, CATEGORY II
PURSUANT TO 33 USC 1314


DATE:	JUNE 2006
SCALE:	SCALE
REVISION:	2: OCTOBER 2007

FIG. 12


PROJ. NO:	DRAWN	REVIEWED	CADD FILE
775750	EWS	BL	775750-M31.DWG

NOTES:


1. ALL CULVERTS SHALL BE PREFABRICATED REINFORCED CONCRETE AND HAVE A COMPRESSIVE STRENGTH OF 5,000 PSI.
2. ALL REINFORCING STEEL SHALL MEET THE REQUIREMENTS OF THE MANUFACTURER.
3. ALL CULVERT PIECES SHALL BE JOINED WITH A RUBBER GASKET.
4. ALL JOINTS, CRACKS, AND HOLES SHALL BE MORTARED WITH NON-SHRINK MORTAR.
5. CULVERTS AND PLUNGE POOLS SHALL BE CONSTRUCTED AND/OR INSTALLED USING "IN-THE-DRY" METHODS. SEE SPECIFICATION SECTION D-701 AND N-004.
6. SIZE, LOCATION, AND SPACING OF STEEL BAFFLES SHALL BE AS SHOWN.
7. STEEL GRATES SHALL BE INSTALLED AT THE INLET OF BOTH CULVERTS TO PREVENT THE PASSAGE OF BEAVERS. THE GRATES SHALL BE DESIGNED TO ENCOURAGE THE PASSAGE OF FISH AND OTHER STREAM WILDLIFE. SEE SPECIFICATION SECTION N-004.

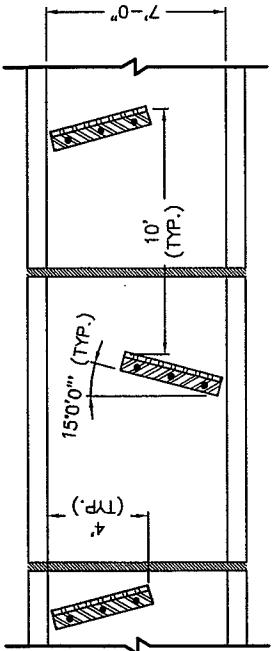


BAFFLE PLACEMENT DETAIL

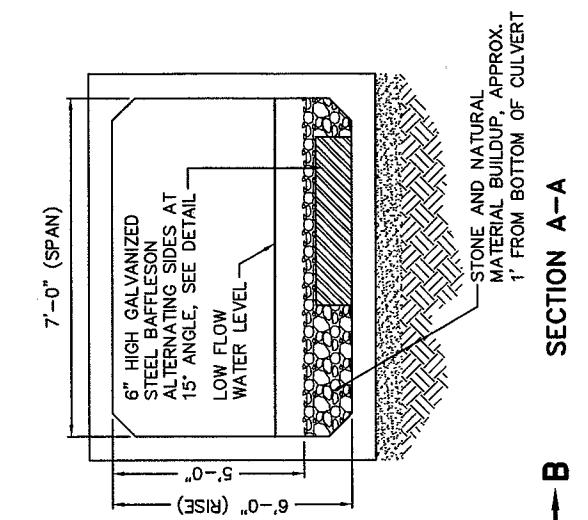

**SECTION B-B
CONTROL STRUCTURE**

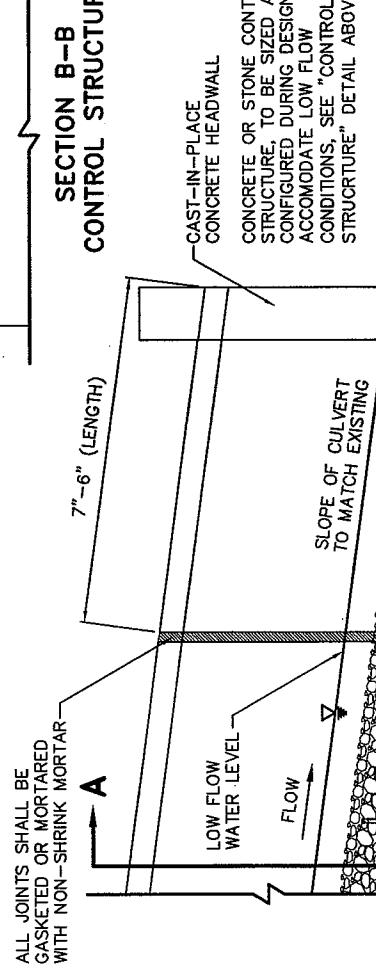

SECTION A-A

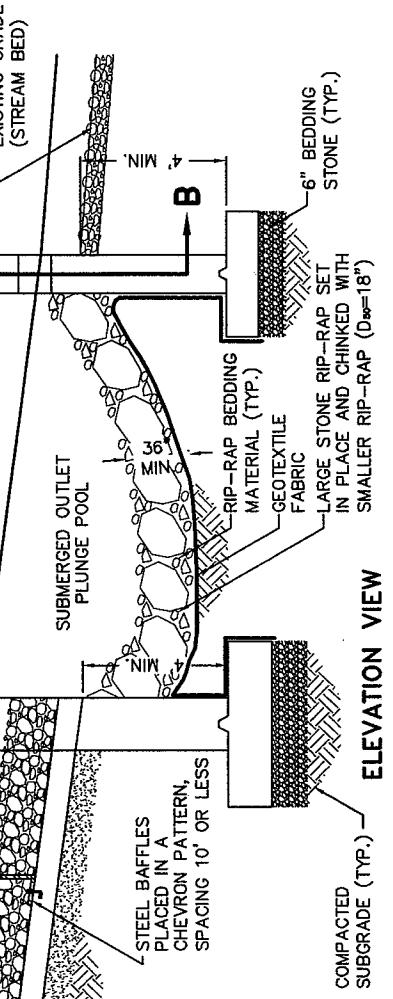

REINFORCED CONCRETE BOX CULVERT
N.T.S.



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MITIGATION DETAILS – UNNAMED, CULVERTED, INTERMITTENT STREAM AND PAULL BROOK



RUNWAY AND TAXIWAY RECONSTRUCTION WITH
SAFETY AREA AND OTHER AIRPORT IMPROVEMENTS
AIRP NO. J-25-0036-17
HARRIMAN AND WEST AIRPORT
STATE ROAD (ROUTE 2)
CITY OF NORTH ADAMS, MASSACHUSETTS


PERMITTING PLAN SET

SECTION 404 PROGRAMMATIC
GENERAL PERMIT, CATEGORY II
PURSUANT TO 33 LUO 1544

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FIG. 13

PROJ. NO:	DRAWN	REVIEWED	CADD FILE
775750	EWS	BLS	775750-M34.DWG

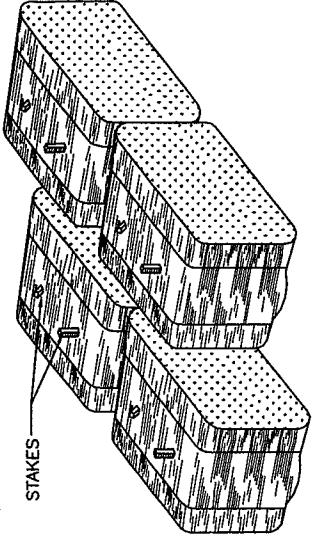


HAY BALE NOTES:

- BALES SHALL BE PLACED IN A ROW WITH THE ENDS TIGHTLY ABUTTING THE ADJACENT BALES.
- BALES SHALL BE SECURELY ANCHORED IN PLACE BY STAKES OR RE-BARS DRIVEN THROUGH THE BALES. THE FIRST STAKE IN EACH BALE SHALL BE ANGLED TOWARD PREVIOUSLY LAID BALE TO FORCE BALES TOGETHER.
- INSPECTION SHALL BE FREQUENT AND REPAIR OR REPLACEMENT SHALL BE MADE PROMPTLY AS NEEDED.
- BALES SHALL BE REMOVED AND REPLACED WHEN THEY BECOME FILLED WITH DRAINAGE SEDIMENT.
- BALES SHALL BE REMOVED WHEN THE EMBANKMENTS STABILIZE.

TYPICAL DOUBLE ROW HAYBALE CHECK DAM DETAIL

N.T.S.

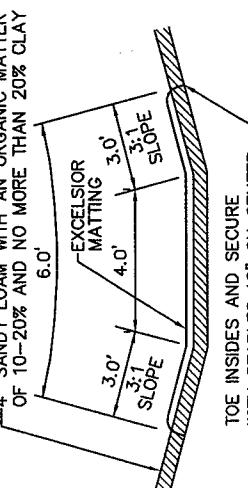

TOE INSIDES AND SECURE WITH STAPLES 18° ON CENTER

HAY BALE NOTES:

- BALES SHALL BE PLACED IN TWO ROWS, STAGGERED WITH 6" OVERLAP AT THE END.
- FOR MORE NOTES PERTAINING TO THIS DETAIL, SEE NOTES FOR "TYPICAL SINGLE ROW HAYBALE CHECK DAM DETAIL" TO THE LEFT.

TYPICAL DOUBLE ROW HAYBALE CHECK DAM DETAIL


N.T.S.

4" SANDY LOAM WITH AN ORGANIC MATTER OF 10-20% AND NO MORE THAN 20% CLAY


6.0' EXCELSIOR MATTING 3.0' SLOPE 3.1' SLOPE

GRASS SWALE AND EXCELSIOR MATTING SECTION DETAIL


N.T.S.

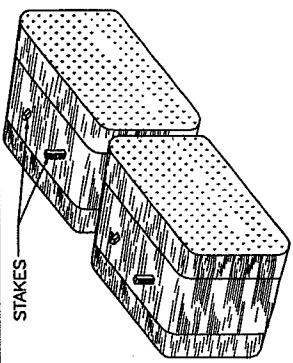

DETAIL OF POST ATTACHMENT (PRE-ASSEMBLED PRIOR TO INSTALLATION)

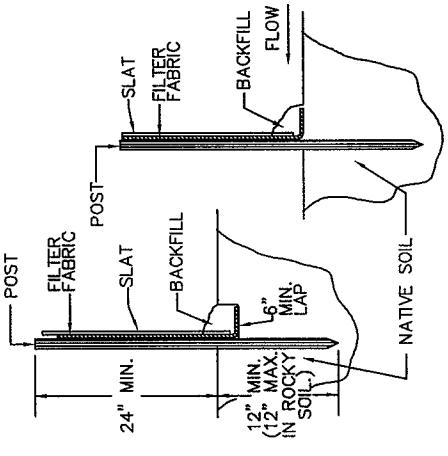


TOE-IN METHODS

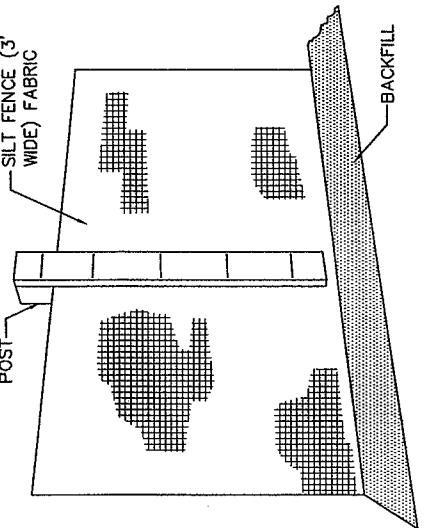

PERSPECTIVE OF FENCE

N.T.S.

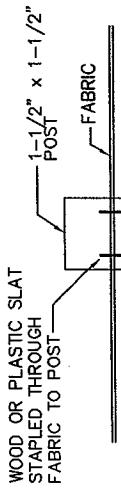

TYPICAL SILT FENCE DETAIL

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EROSION CONTROL DETAILS (SHEET 1 OF 2)



RUNWAY AND TAXIWAY RECONSTRUCTION WITH
SAFETY AREA AND OTHER AIRPORT IMPROVEMENTS
AIP NO. 3-25-0036-17
HARRIMAN AND WEST AIRPORT
STATE ROAD (ROUTE 2)
CITY OF NORTH ADAMS, MASSACHUSETTS

PERMITTING PLAN SET

SECTION 404 PROGRAMMATIC
GENERAL PERMIT, CATEGORY B
PURSUANT TO 33 URC 1344

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FIG. 14

A CONSTRUCTION SEQUENCE

- MOBILIZATION.
- INSTALL SILT FENCE, HAY BAILE CHECK DAMS AND OTHER SEDIMENTATION AND EROSION CONTROL MEASURES AS SHOWN ON THE PLANS OR AS INDICATED BY THE ENGINEER.
- STRIP AND STOCKPILE TOPSOIL FOR REUSE. STABILIZE BY PLACEMENT OF TEMPORARY SEED AND MULCH IF REQUIRED. SEE TEMPORARY EROSION CONTROL NOTES THIS SHEET.
- EXCAVATE EXISTING SOILS, PAVEMENTS, AND STRUCTURES PROPOSED TO BE REMOVED FOR THE PLACEMENT OF PAVEMENT SECTION MATERIALS, PIPES, DUCTS OR OTHER CONSTRUCTION AS SPECIFIED.
- INSTALL DRAINAGE STRUCTURES AND PIPES.
- INSTALL HAY BAILE CHECK DAMS ON NEW DRAINAGE STRUCTURES.
- INSTALL ELECTRICAL DUCTS AND STRUCTURES.
- BLEND, GRADE, AND COMPACT SUBBASE.
- INSTALL/PLACE AND COMPACT BASE MATERIALS.
- ROUGH GRADE TURF AREAS.
- RENEW OR REPLACE CHECK DAMS, SILT FENCE OR OTHER MEASURES AS REQUIRED.
- PLACE BITUMINOUS CONCRETE PAVEMENT.
- FINISH GRADE ALL TURF AREAS.
- SEED AND MULCH ALL TURF AREAS WITH PERMANENT SEED MIXTURE WITHIN 15 DAYS OF THE COMPLETION OF FINAL GRADING.
- CONTINUE TEMPORARY SEDIMENTATION AND EROSION CONTROL MEASURES UNTIL AREAS ARE SUFFICIENTLY STABILIZED AND TURF IS ESTABLISHED.
- REMOVE TEMPORARY SEDIMENTATION AND EROSION CONTROL MEASURES AND RESTORE THE AREAS AROUND THEM.
- ALL SEDIMENTATION AND EROSION CONTROL MEASURES SHALL BE PLACED AND MAINTAINED IN ACCORDANCE WITH MDEP STANDARDS AND BEST MANAGEMENT PRACTICES.

TEMPORARY EROSION CONTROL NOTE

- ALL EARTH WORK SHALL BE CONFINED TO THE LIMITS OF WORK SHOWN ON THE PLANS.
- HAY BAILE CHECK DAMS SHALL BE INSTALLED WHERE INDICATED AND PER THE DETAIL.
- SILT FENCES SHALL BE INSTALLED WHERE SHOWN ON THE PLANS, ON THE DOWNHILL SIDE OF STOCKPILES, AND IN OTHER LOCATIONS AS REQUIRED TO PREVENT SILT AND SEDIMENT FROM ENTERING THE EXISTING DRAINAGE CHANNELS.
- ALL CHECK DAMS, SILT FENCE, AND OTHER SEDIMENTATION AND EROSION CONTROL MEASURES SHALL BE MAINTAINED AND/OR REPLACED AS NEEDED TO RETAIN THEIR EFFECTIVENESS.
- ALL TURF AREAS SHALL BE PERMANENTLY STABILIZED WITHIN 15 DAYS OF FINAL GRADING OR TEMPORARILY STABILIZED WITHIN 30 DAYS OF INITIAL DISTURBANCE OF SOIL. ALL SEEDING SHALL BE IN ACCORDANCE WITH THE SPECIFICATIONS.
- SEED MIXTURES, LIME, FERTILIZER AND MULCH SHALL BE IN ACCORDANCE WITH THE SPECIFICATIONS.

BMP NOTES:


- ALL BMP'S HAVE BEEN DESIGNED TO MEET THE GUIDELINES SET FORTH IN THE MASSACHUSETTS DEPARTMENT OF ENVIRONMENT PROTECTION (MDEP) DOCUMENT TITLED, STORMWATER MANAGEMENT, VOLUME TWO: STORMWATER TECHNICAL HANDBOOK. TO THE MAXIMUM EXTENT POSSIBLE.
 - ALL BMP'S SHALL BE INSTALLED TO COMPLY WITH THE MDEP DOCUMENT REFERENCED ABOVE, TO MAXIMUM EXTENT POSSIBLE.
-

PLAN VIEW

ELEVATION VIEW DEWATERING SEDIMENT RETENTION BASIN

N.T.S.

- STONE CHECK DAMS SHALL BE CONSTRUCTED WITH 2" TO 3" STONES.
- CENTER OF STONE CHECK DAM SHALL BE 6" LOWER THAN THE OUTER EDGES OF THE STONE CHECK DAM.
- REGULAR INSPECTIONS SHALL BE MADE TO ENSURE THAT THE CHECK DAM IS FUNCTIONING PROPERLY.
- EROSION CAUSED BY HIGH FLOWS AROUND THE EDGES OF THE STONE CHECK DAM SHALL BE CORRECTED IMMEDIATELY.
- EVIDENCE OF SILTRATION DOWNSTREAM OF THE STONE CHECK DAM REQUIRES INSPECTION AND ADJUSTMENT IMMEDIATELY.
- STONE CHECK DAMS SHALL BE CHECKED FOR SEDIMENT ACCUMULATION AFTER EACH SIGNIFICANT RAINFALL. SEDIMENT SHALL BE REMOVED WHEN IT REACHES HALF OF THE ORIGINAL HEIGHT OR PRIOR TO THAT HAPPENING.
- STONE CHECK DAMS SHALL BE REMOVED WITH WRITTEN PERMISSION FROM THE ENGINEER UPON COMPLETION OF ALL PROPOSED WORK.

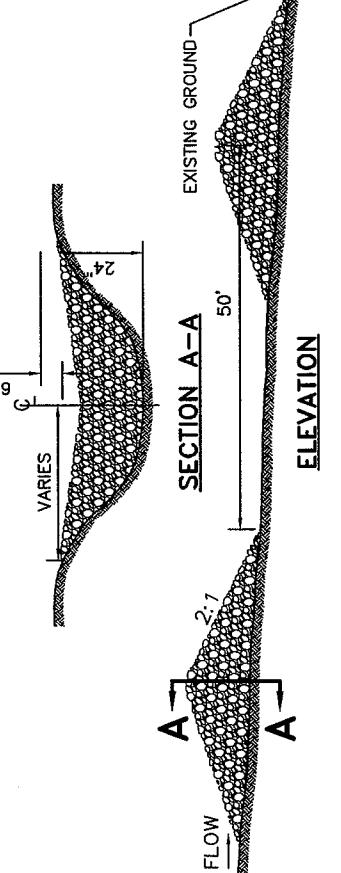

STONE CHECK DAM TYPICAL DETAIL

N.T.S.



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EROSION CONTROL DETAILS (SHEET 2 OF 2)

RUNWAY AND TAXIWAY RECONSTRUCTION WITH SAFETY AREA AND OTHER AIRPORT IMPROVEMENTS AIP NO. 3-25-0036-17 HARRIMAN AND WEST AIRPORT STATE ROAD (ROUTE 2) CITY OF NORTH ADAMS, MASSACHUSETTS		PERMITTING PLAN SET SECTION 404 PROGRAMMATIC GENERAL PERMIT, CATEGORY II PURSUANT TO 33 USC 1344	
PROJ. NO:	DRAWN	REVIEWED	CADD FILE
775750	EWS	BLA	775750-C71.DWG

DATE:	JUNE 2006
SCALE:	NOT TO SCALE
REVISION:	2: OCTOBER 2007

FIG. 15



CONSTRUCTION PHASING NOTES

RUNWAY AND TAXIWAY RECONSTRUCTION WITH
SAFETY AREA AND OTHER AIRPORT IMPROVEMENTS
AIP NO. J-25-0036-17
HARRIMAN AND WEST AIRPORT
STATE ROAD (ROUTE 2)
CITY OF NORTH ADAMS, MASSACHUSETTS

PERMITTING PLAN SET

SECTION 404 PROGRAMMATIC
GENERAL PERMIT, CATEGORY II
PURSUANT TO 33 U.S.C. 1344



CITY OF NORTH ADAMS
AIRPORT IMPROVEMENT
PROJECT NUMBER: 775750

Environmental Assessment

DATE: 06/01/2006

REVISION: 2: OCTOBER 2007

DATE: JUNE 2006

SCALE: N.T.S.

PROJ. NO: 775750

DRAWN: EWS

REVIEWED: BL

CADD FILE: 775750-S11.DWG

PHASE I:

CONSTRUCT RUNWAY 11 END SAFETY AREA, WHICH INCLUDES THE FOLLOWING TASKS

1. INSTALL SILT FENCE AND EROSION AND SEDIMENTATION CONTROL MEASURES (BMPS). PROTECT NON-CULVERTED, INTERMITTENT STREAM FROM DISTURBANCE.
2. INSPECT AND MAINTAIN ALL BMPS THROUGHOUT THE DURATION OF THE PROJECT. PROTECT ALL BMPS WILL BE LEFT IN PLACE UNTIL ALL DISTURBED AREAS HAVE VEGETATION ESTABLISHED.
3. CONSTRUCT NON-CULVERTED, INTERMITTENT STREAM WETLAND MITIGATION AREA
4. STRIP AND STOCKPILE TOPSOIL FROM UPLAND AREAS IN DESIGNATED AREA.
5. EXCAVATE EXISTING MATERIAL AND STOCKPILE IN DESIGNATED MITIGATION AREA.
6. CONSTRUCT NEW STREAM BED AND WATERFALL, CULVERTED TO TOPSOIL TO FINISH GRADE.
7. PLANT PROPOSED SPECIES
8. REDIRECT EXISTING NON-CULVERTED, INTERMITTENT STREAM TO NEWLY CONSTRUCTED WETLAND MITIGATION AREA
9. HAUL FILL MATERIAL TO SITE AND STOCKPILE IN DESIGNATED AREA
10. CONSTRUCT EMBANKMENT FOR SAFETY AREA
11. PLACE, GRADE AND COMPACT FILL MATERIAL REQUIRED TO CONSTRUCT SAFETY AREA
12. REGRADE AND GRADE TOPSOIL TO FINISH GRADE
13. SEED, FERTILIZE, AND MULCH ALL DISTURBED AREAS
14. REMOVE BMPS UNDER THE DIRECTION OF THE ENGINEER ONCE ALL DISTURBED AREAS HAVE BEEN STABILIZED

PHASE II:

RECONSTRUCT AND SHIFT A PORTION OF RUNWAY 11-23 ON THE RUNWAY 11 END AND RECONSTRUCT TAXIWAY TO RUNWAY 23 END, WHICH INCLUDES THE FOLLOWING TASKS

1. INSTALL SILT FENCE AND EROSION AND SEDIMENTATION CONTROL MEASURES (BMPS). PROTECT CULVERTED, INTERMITTENT STREAM AND PAUL BROOK FROM DISTURBANCE
2. INSPECT AND MAINTAIN ALL BMPS THROUGHOUT THE DURATION OF THE PROJECT. PROTECT ALL BMPS WILL BE LEFT IN PLACE UNTIL ALL DISTURBED AREAS HAVE VEGETATION ESTABLISHED
3. STRIP EXISTING TOPSOIL IN UNNAMEDED, CULVERTED, INTERMITTENT STREAM AND PAUL BROOK
4. INSTALL NEW BOX CULVERTS IN UNNAMEDED, CULVERTED, INTERMITTENT STREAM AND PAUL BROOK
 - REMOVE WING WALLS ON ONE SIDE OF EXISTING CULVERTS
 - REMOVE ONE OF THE TWO CULVERTS AND HAUL FILL MATERIAL TO NEW CULVERTS AND CULVERT PROTECTION
 - INSTALL NEW BOX CULVERTS AND HAUL FILL MATERIAL TO NEW CULVERTS
 - REMOVE REMAINING WING WALLS AND CULVERTS
 - RESTORE SURROUNDING AREA
5. HAUL BASE AND GRAVEL MATERIALS TO SITE AND STOCKPILE IN DESIGNATED AREA
6. EXCAVATE EXISTING MATERIALS TO SUBGRADE FOR PAVED AND TURF AREAS
7. STOCKPILE IN DESIGNATED AREA. ANY SURPLUS OR UNSUITABLE MATERIALS WILL BE LEGALLY DISPOSED OF OFF AIRPORT PROPERTY
8. INSTALL UNDERDRAINS AND DRAINAGE IMPROVEMENTS INCLUDING THE TWO (2) CULVERTS THAT RUN UNDERNEATH THE AIRPORT USING IN-THE-DRY METHODOLOGY; SEE SPECIFICATION SECTION P-156
9. PLACE, GRADE, AND COMPACT BASE AND GRAVEL MATERIALS IN PROPOSED
10. INSTALL ELECTRICAL COMPONENTS
 - CABLES, DUCT BANKS, RUNWAY AND TAXWAY LIGHTS, AND GUIDANCE SIGNS
11. RESPREAD TOPSOIL TO FINISH GRADE
12. PLACE PAVEMENT ON RUNWAY AND TAXWAY
13. SEED, FERTILIZE, AND MULCH DISTURBED AREAS
14. REMOVE BMPS UNDER THE DIRECTION OF THE ENGINEER ONCE ALL DISTURBED AREAS HAVE BEEN STABILIZED

PHASE III:

RECONSTRUCT AND SHIFT A PORTION OF RUNWAY 11-23 ON THE RUNWAY 23 END AND RECONSTRUCT TAXIWAY TO RUNWAY 23 END, WHICH INCLUDES THE FOLLOWING TASKS

1. INSTALL SILT FENCE AND EROSION AND SEDIMENTATION CONTROL MEASURES (BMPS).
2. INSPECT AND MAINTAIN ALL BMPS THROUGHOUT THE DURATION OF THE PROJECT. PROTECT ALL BMPS WILL BE LEFT IN PLACE UNTIL ALL DISTURBED AREAS HAVE VEGETATION ESTABLISHED
3. REMOVE EXISTING PAVEMENT
4. STRIP EXISTING TOPSOIL IN PROPOSED AREAS AND STOCKPILE IN DESIGNATED AREA
5. EXCAVATE EXISTING MATERIALS TO SUBGRADE FOR PAVED AND TURF AREAS
 - STOCKPILE IN DESIGNATED AREA. ANY SURPLUS OR UNSUITABLE MATERIALS WILL BE LEGALLY DISPOSED OF OFF AIRPORT PROPERTY
6. REMOVE EXISTING PAVEMENT
7. STRIP EXISTING TOPSOIL IN PROPOSED AREAS AND STOCKPILE IN DESIGNATED AREA
8. CONSTRUCT SITE BUILDING
 - STOCKPILE IN DESIGNATED AREA. ANY SURPLUS OR UNSUITABLE MATERIALS WILL BE LEGALLY DISPOSED OF OFF AIRPORT PROPERTY
9. PLACE, GRADE, AND COMPACT BASE AND GRAVEL MATERIALS IN PROPOSED
10. INSTALL ELECTRICAL COMPONENTS
 - CABLES, DUCT BANKS, RUNWAY AND TAXWAY LIGHTS, AND GUIDANCE SIGNS
11. RESPREAD TOPSOIL TO FINISH GRADE
12. PLACE PAVEMENT ON APRONS AND TAXILINE
13. SEED, FERTILIZE, AND MULCH DISTURBED AREAS
14. REMOVE BMPS UNDER THE DIRECTION OF THE ENGINEER ONCE ALL DISTURBED AREAS HAVE BEEN STABILIZED

PHASE V:

RECONSTRUCT APRONS AND TAXIWAY AND CONSTRUCT NEW REMOVAL EQUIPMENT (RE) BUILDING, WHICH INCLUDES THE FOLLOWING TASKS


1. INSTALL EROSION CONTROL MEASURES (BMPS)
2. REMOVE EXISTING PAVEMENT
3. STRIP EXISTING TOPSOIL IN PROPOSED AREAS AND STOCKPILE IN DESIGNATED AREA
4. HAUL BASE AND GRAVEL MATERIALS TO SITE AND STOCKPILE IN DESIGNATED AREA
5. EXCAVATE EXISTING MATERIALS TO SUBGRADE FOR PAVED AND TURF AREAS
 - STOCKPILE IN DESIGNATED AREA. ANY SURPLUS OR UNSUITABLE MATERIALS WILL BE LEGALLY DISPOSED OF OFF AIRPORT PROPERTY
6. INSTALL UNDERDRAINS AND DRAINAGE IMPROVEMENTS
7. INSTALL HAYBALE CHECK DAMS AND/OR FILTER FABRIC ON NEW DRAINAGE IMPROVEMENTS TO PROTECT FROM SEDIMENT AND EROSION
8. CONSTRUCT SITE BUILDING
 - STOCKPILE IN DESIGNATED AREA. ANY SURPLUS OR UNSUITABLE MATERIALS WILL BE LEGALLY DISPOSED OF OFF AIRPORT PROPERTY
9. PLACE, GRADE, AND COMPACT BASE AND GRAVEL MATERIALS IN PROPOSED
10. INSTALL ELECTRICAL COMPONENTS
 - CABLES, DUCT BANKS, RUNWAY AND TAXWAY LIGHTS, AND GUIDANCE SIGNS
11. RESPREAD TOPSOIL TO FINISH GRADE
12. PLACE PAVEMENT ON APRONS AND TAXILINE
13. SEED, FERTILIZE, AND MULCH DISTURBED AREAS
14. REMOVE BMPS UNDER THE DIRECTION OF THE ENGINEER ONCE ALL DISTURBED AREAS HAVE BEEN STABILIZED

PHASE IV:

RECONSTRUCT REMAINING PORTION OF TAXIWAY THAT WAS NOT RECONSTRUCTED IN PHASE II AND III, WHICH INCLUDES THE FOLLOWING TASKS

1. INSTALL SILT FENCE AND EROSION AND SEDIMENTATION CONTROL MEASURES (BMPS).
2. INSPECT AND MAINTAIN ALL BMPS THROUGHOUT THE DURATION OF THE PROJECT. PROTECT ALL BMPS WILL BE LEFT IN PLACE UNTIL ALL DISTURBED AREAS HAVE VEGETATION ESTABLISHED
3. REMOVE EXISTING PAVEMENT
4. STRIP EXISTING TOPSOIL IN PROPOSED AREAS AND STOCKPILE IN DESIGNATED AREA
5. EXCAVATE EXISTING MATERIALS TO SUBGRADE FOR PAVED AND TURF AREAS
 - STOCKPILE IN DESIGNATED AREA. ANY SURPLUS OR UNSUITABLE MATERIALS WILL BE LEGALLY DISPOSED OF OFF AIRPORT PROPERTY
6. INSTALL UNDERDRAINS AND DRAINAGE IMPROVEMENTS
7. STRIP EXISTING TOPSOIL IN PROPOSED AREAS AND STOCKPILE IN DESIGNATED AREA
8. CONSTRUCT SITE BUILDING
 - STOCKPILE IN DESIGNATED AREA. ANY SURPLUS OR UNSUITABLE MATERIALS WILL BE LEGALLY DISPOSED OF OFF AIRPORT PROPERTY
9. PLACE, GRADE, AND COMPACT BASE AND GRAVEL MATERIALS IN PROPOSED
10. INSTALL ELECTRICAL COMPONENTS
 - CABLES, DUCT BANKS, TAXWAY LIGHTS, AND GUIDANCE SIGNS
11. RESPREAD TOPSOIL TO FINISH GRADE
12. PLACE PAVEMENT ON TAXWAY
13. SEED, FERTILIZE, AND MULCH DISTURBED AREAS
14. REMOVE BMPS UNDER THE DIRECTION OF THE ENGINEER ONCE ALL DISTURBED AREAS HAVE BEEN STABILIZED

FIG. 16

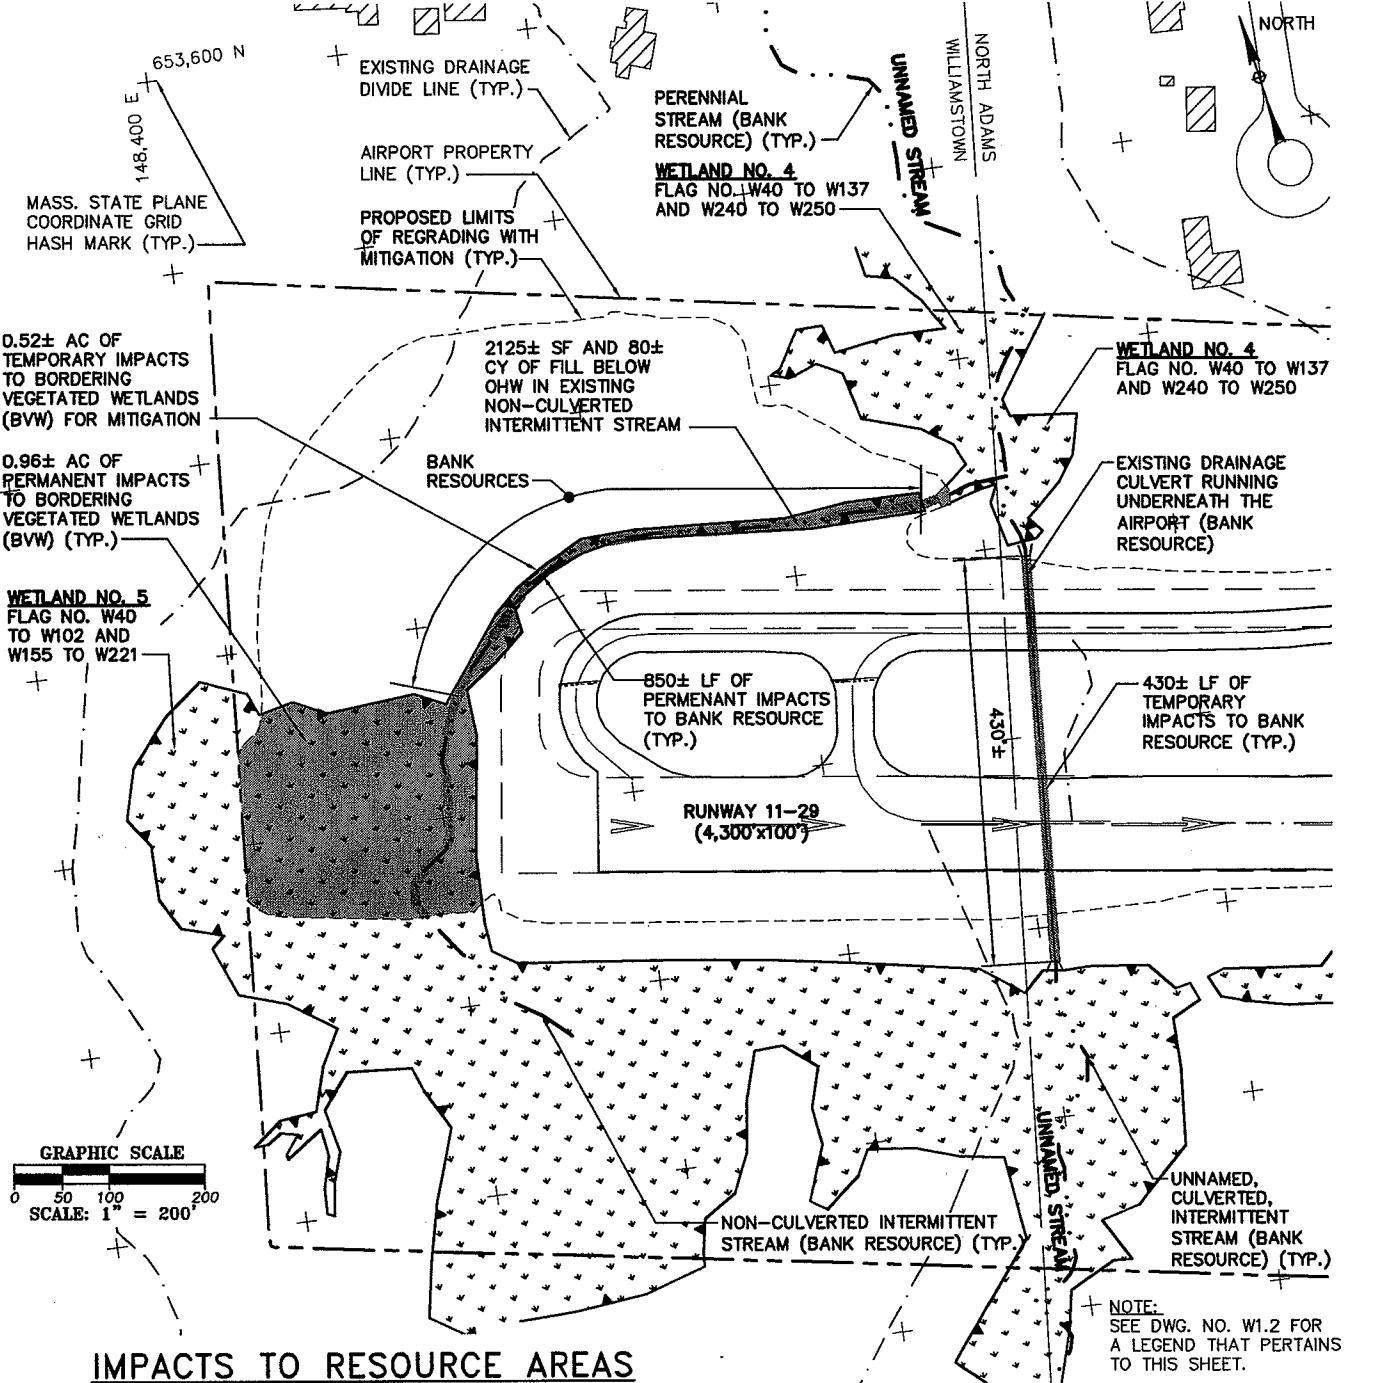


IMPACTS TO RESOURCE AREAS

RESOURCE AREA	PROJECT IMPACTS		TEMPORARY IMPACTS FROM MITIGATION	RESOURCE AREA REPLACEMENT
	PERMANENT	TEMPORARY		
BORDERING VEG. WETLANDS (BVW)	0.96± AC	0.03± AC	0.52± AC	3.30± AC
BANK	850± LF	1,430± LF	0± LF	1,950± LF

EXISTING WETLAND RESOURCES AND IMPACTS PLAN - NON-CULVERTED, INTERMITTENT STREAM AND UNNAMED, CULVERTED, INTERMITTENT STREAM

SCALE: 1"=200'

GALE Gale Associates, Inc. Engineers Architects Planners 15 Constitution Drive Bedford, NH 03110 P 603.471.1887 F 603.471.1809 www.galinc.com Boston Baltimore Orlando San Francisco	EXISTING WETLAND RESOURCES AND IMPACTS - NON-CULVERTED, INTERMITTENT STREAM AND UNNAMED, CULVERTED, INTERMITTENT STREAM				DATE: JUNE 2006
	PERMITTING PLAN SET	SECTION 404 PROGRAMMATIC GENERAL PERMIT, CATEGORY II PURSUANT TO 33 USC 1344	SCALE: 1" = 200'		
BES BAYSTATE ENVIRONMENTAL CONSULTANTS INC. Civil Engineers 200 North Main Street Environmental Scientists East Longmeadow, MA 01028	RUNWAY AND TAXIWAY RECONSTRUCTION WITH SAFETY AREA AND OTHER AIRPORT IMPROVEMENTS AIP NO. 3-25-0038-17 HARRIMAN AND WEST AIRPORT STATE ROAD (ROUTE 2) CITY OF NORTH ADAMS, MASSACHUSETTS				REVISION: 2: OCTOBER 2007
	PROJ. NO:	DRAWN	REVIEWED	CADD FILE	FIG. 17
	775750	EWS	BLA	775750-W11.DWG	

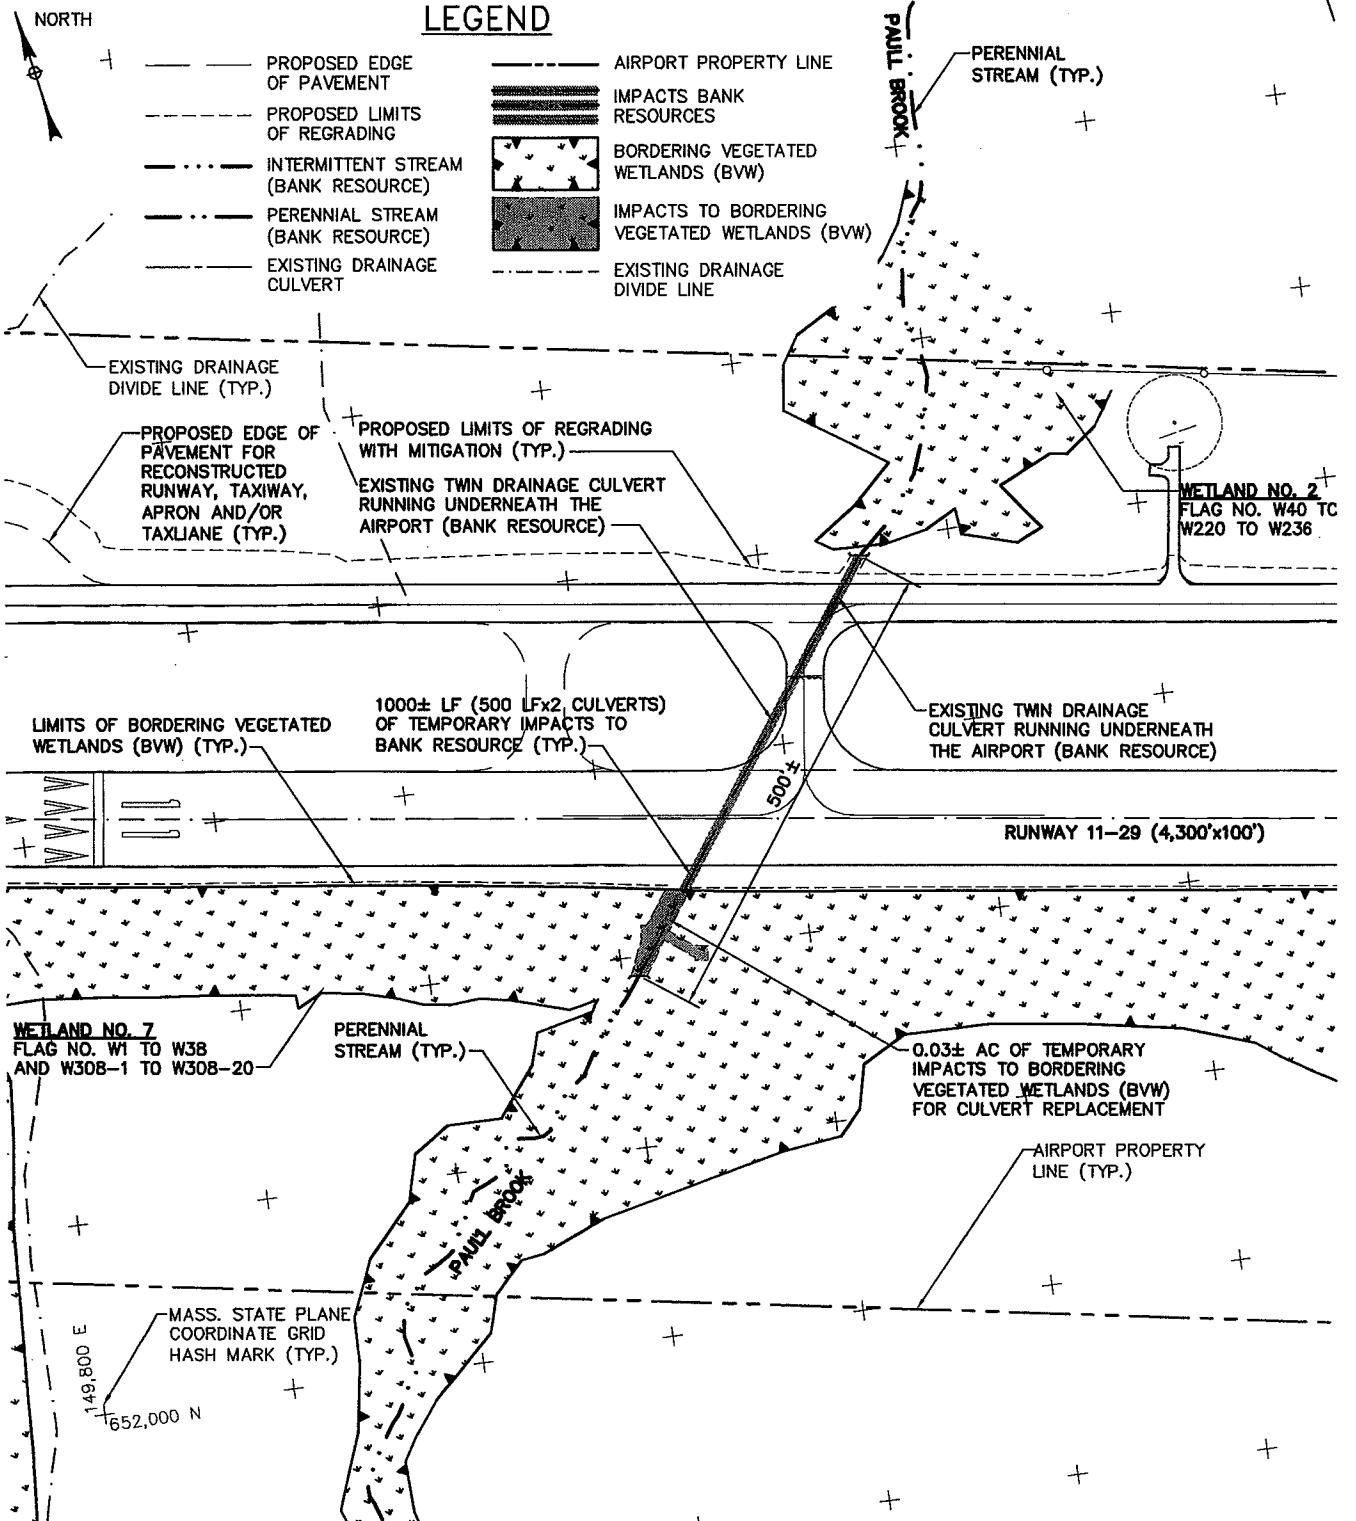

NOTE:
SEE DWG. NO. W1.1 FOR A TABLE TITLED,
"IMPACTS TO RESOURCE AREAS" THAT
PERTAINS TO THIS SHEET.

EXISTING WETLAND RESOURCES AND IMPACTS PLAN - PAULL BROOK

SCALE: 1"=200'

DATE:	JUNE 2006
SCALE:	1" = 200'
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EXISTING WETLAND RESOURCES AND IMPACTS - PAULL BROOK



RUNWAY AND TAXIWAY RECONSTRUCTION WITH
SAFETY AREA AND OTHER AIRPORT IMPROVEMENTS
AIP NO. 3-25-0038-17
HARRIMAN AND WEST AIRPORT
STATE ROAD (ROUTE 2)
CITY OF NORTH ADAMS, MASSACHUSETTS

PERMITTING PLAN SET

SECTION 404 PROGRAMMATIC
GENERAL PERMIT, CATEGORY II
PURSUANT TO 33 URS 1544

PROJ. NO:	DRAWN	REVIEWED	CADD FILE
775750	EWS	BL	775750-W11.DWG

FIG. 18